
EVERETT PARK IMPROVEMENTS

208 BLOOMFIELD AVENUE BLOCK 707 - LOT 10 TOWNSHIP OF VERONA ESSEX COUNTY, NEW JERSEY APRIL 11, 2025

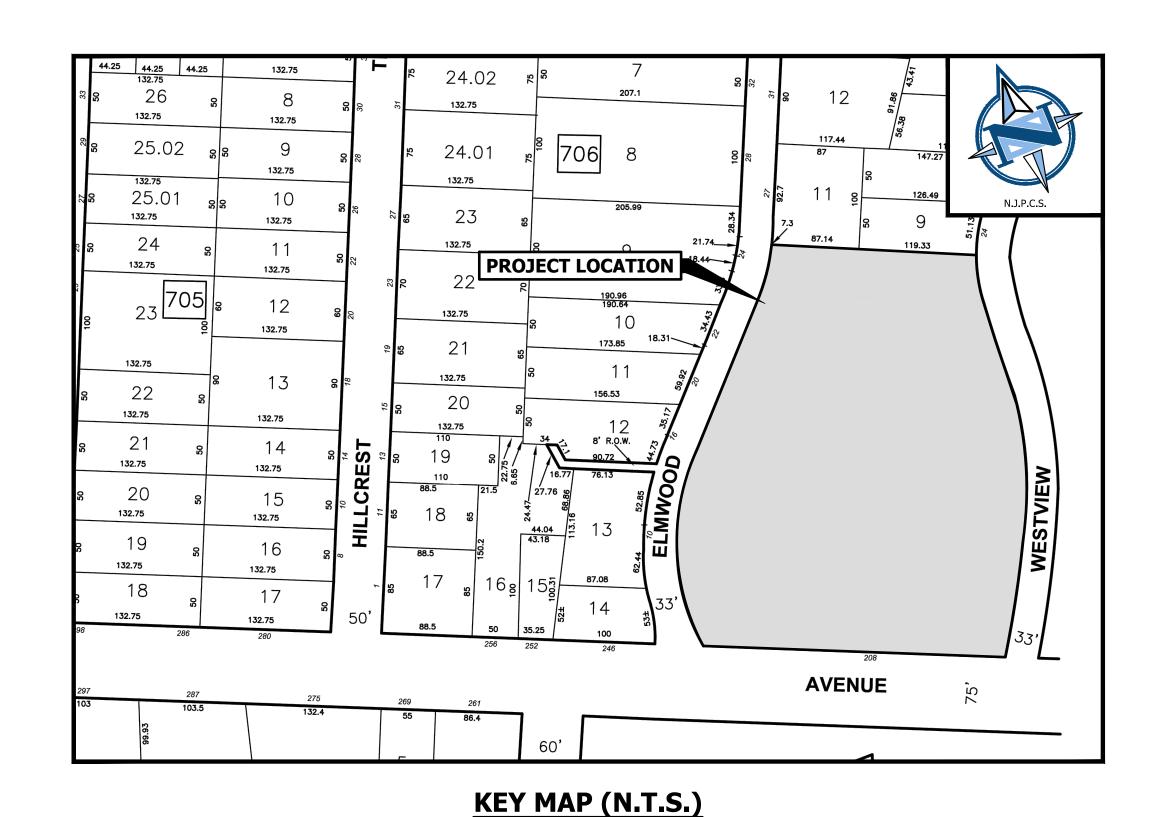


	ESTIMATE OF QUANTITIES		
tem No.	Item Description	Unit of Measure	Quantity
1	Mobilization / Demobilization	L.S.	1
3	Site Clearing / Demolition Tree Removals, 6" - 15"	L.S. UNIT	1 15
4	Tree Removals 16" - 23"	UNIT	3
5 6	Tree Removals 24" or Greater Additional Tree Removals, 6" - 15" (If and Where Directed.)	UNIT	20
7 8	Additional Tree Removals 16" - 23" (If and Where Directed.) Additional Tree Removals 24" or Greater (If and Where Directed.)	UNIT	3 2
9	Removal of Invasive Vines and Dead Trees (If and Where Directed.)	L.S.	1
10 11	Tree Stump Removal Soil Erosion Measures	UNIT L.S.	5 1
12	Site Grading (Includes Cut & Fill and Soil Removal)	L.S.	1
13 14	Temporary Chain Link Construction Fence and Gates 4" Perforated PVC Pipe	L.F.	1300 2820
15	8" Perforated HDPE Pipe	L.F.	190
16 17	12" HDPE Pipe	L.F.	530 240
18	15" HDPE Pipe 15" Perforated HDPE Pipe	L.F.	115
19	24" RCP Pipe	L.F.	35
20 21	30" RCP Pipe 36" Perforated HDPE Pipe	L.F.	470
22	2' x 2' Inlet, Complete	UNIT	9
23	Yard Drain (Buried), Complete Storm Manhole, 4' Dia., Complete	UNIT	6 8
25	New Type A, Inlet, Complete	UNIT	1
26 27	New Type B, Inlet, Complete New Type E, Inlet, Complete	UNIT	3
28	Reconstruct Existing Manhole for New 24" Connection	UNIT	1
29 30	Reconstruct Existing Inlet for New 30" Connection	UNIT	1
30 31	Outlet Control Structure 6" PVC SDR-35 Sanitary Pipe	UNIT L.F.	335
32	Sanitary Sewer Manhole, 4' Dia.	UNIT	4
33 34	Sanitary Sewer Saddle Connection 9" x 18" Concrete Vertical Curb	L.S. L.F.	1 830
35	Concrete Header Curb 12" x 18"	L.F.	200
36 37	Hot Mix Asphalt Surface Course, Mix 9.5M64, 2" Thick (Parking Lot Driveway) Hot Mix Asphalt Base Course, Mix 19M64, 4" Thick (Parking Lot Driveway)	TONS TONS	15 35
38	Dense-Graded Aggregate Base Course, 6" Thick (Parking Lot Driveway)	S.Y.	135
39	Decorative Pavers on 4" Thick Concrete Base	S.Y.	145
40 41	Concrete Sidewalk, 4" Thick Concrete Sidewalk, 4" Thick (If and Where Directed.)	S.Y. S.Y.	1,070 265
42	Concrete, Reinforced, 6" Thick	S.Y.	390
43 44	Open Graded Friction Course (OGFC), 4" Thick (Pervious Parking Lot) Pervious Pavement Choker Course, 1" Thick (Pervious Parking Lot)	S.Y.	1,800 1,800
45	Clean Washed and Open Graded ASSHTO No. 2 Broken Stone, 14 " Thick (Pervious Parking	S.Y.	1,800
46 47	Geotextile Fabric (Pervious Parking Lot)	S.Y.	1,800 1
48	Parking Lot Striping Retaining Wall (Height Varies 1' - 11' Max)	L.S. S.F.F.	6,000
49	Natural Grass Field (per Cross Section)	S.Y.	5,750
50 51	Topsoil and Sod for Slopes and Disturbed Areas ClayInfield/On Deck Skin Areas Complete (per Cross Section)	S.Y.	2,900 835
52	Sports Field Irrigation System Complete	L.S.	1
53	Furnish and Install Portable Pitching Mound, Little League, 6" High	UNIT	1
54 55	Furnish and Install Portable Bases, Complete with Covers (Set of 3) Furnish and Install Portable Homeplate, Complete with Covers	UNIT	3
56	Furnish and Install Pitchers Rubber, Complete with Covers	UNIT	3
57	Furnish and Install Fall Protection Fence, 4' High	L.F.	800
58 59	Furnish and Install Benches Black Vinyl Coated Chain Link Fence, 8' High	UNIT L.F.	6 1,050
60	Sports Netting, 20' Overall Height	L.F.	160
61 62	Black Vinyl Coated Chain Link Fence Gate, Single Swing, 8' High, 4' Wide Black Vinyl Coated Chain Link Fence Gate, Double Swing, 8' High, 12' Wide	UNIT	10
63	Playground, Black Vinyl Coated Chain Link Fence, 4' High	L.F.	200
64 65	Playground, Black Vinyl Coated Chain Link Fence Gate, 4' High, 4' Wide Furnish and Install Timber Guiderail	UNIT L.F.	310
66	Furnish and Install NJDOT Beam Guiderail	L.F.	15
67 68	Furnish and Install Backstop	UNIT	1
68 69	Furnish and Install Dugout Structure, 30' x 10' Furnish and Install 60' x 15' Batting Cage, Complete	UNIT	2
70	Furnish and Install Poured-in-Place Safety Surface, Complete	S.F.	4,600
71 72	Furnish and Install Playground Equipment, Complete (Inclusive Jake's Law) Furnish and Install ADA Accessible Bleachers, 27' Long, 5 Rows, Complete	L.S. UNIT	2
73	Furnish and Install Bleachers, 21' Long, 3 Rows, Complete	UNIT	2
74 75	Furnish and Install Player Benches - 27; with Backrest Furnish and Install Picnic Tables	UNIT	2
76	Furnish and Install Foul Poles	UNIT	2
77 78	Furnish and Install Decorative Park Signage with Landscaping, Complete	UNIT	1
78 79	Furnish and Install Detectable Warning Surface Furnish and Install Site Signage with Post	S.Y. UNIT	6 5
80	Furnish and Install Trash and Recycle Receptacles	UNIT	8
81 82	Final Cleanup / Site Restoration New 25' High Flagpole with Flag Lighting and Landscaping, Complete	L.S. L.S.	1
83	Foundation and Slab for Concession Building	L.S.	1
84	1 - 1/2" Copper Water Service, Complete with Backflow Preventer, Valves, and Meter Setup, and Wet-Tap Connection to Existing Water Main New Electrical Service for Concession Stand, Sports Lighting, Scoreboard, Flag Lighting,	L.S.	1
85 86	and Site Lighting, Complete (includes Conduit, Pull Boxes, Wiring, Controls, and Timers) Decorative LED Site Lighting Set Up (includes fixture, GFI outlets in Pole, Pole	L.S. UNIT	1
	Foundations, Bolt Patterns), Complete		
86 87	Empty Conduit for Future Fiber Connection to Park Acer Rubrum 'October Glory' (October Glory Red Maple) (3"-3 1/2" Cal. B&B)	L.S. UNIT	8
88	Fagus Grandifolia (American Beech) (3"-3 1/2" Cal. B&B)	UNIT	5
89 90	Liriodendron Tulipfera (Tuliptree) (3"-3 1/2" Cal. B&B) Nyssa Sylvatica (Black Gum) (3"-3 1/2" Cal. B&B)	UNIT	10
91	Quercus Bicolor (Swamp White Oak) (2 1/2"-3" Cal. B&B)	UNIT	4
92	Quercus Phellos (Willow Oak) (3"-3 1/2" Cal. B&B)	UNIT	7
93 94	Cornus Florida (White Dogwood) (7'-8' Ht., B&B) Ostrya Virginiana (Hophornbeam) (3 Gal. Container)	UNIT UNIT	6 12
95	Ceanothus Americanus (New Jersey Tea) (3 Gal. Container)	UNIT	3
96 97	Juniperus Confeerta (Shore Juniper) (3 Gal. Container) Carex Vulpinoidea (Fox Sedge) (3 Gal. Container)	UNIT	13 11
98	Contract Allowance for Additional Shade Trees with Water Bags	ALLOW	1
99	Contract Allowance for Supplying and Installing Engraved Fundraising Pavers	ALLOW	1



UTILITY CONTACTS									
SERVICE	COMPANY	ADDRESS							
GAS	PSE&G	214 HUDSON STREET HACKENSACK, NJ 07601							
ELECTRIC	PSE&G	214 HUDSON STREET HACKENSACK, NJ 07601							
WATER	TOWNSHIP OF VERONA WATER DEPARTMENT	10 COMMERCE COURT, VERONA, NJ 07044							
SEWER	TOWNSHIP OF VERONA SEWER DEPARTMENT	10 COMMERCE COURT, VERONA, NJ 07044							

SOURCE: REF. TAX MAPS

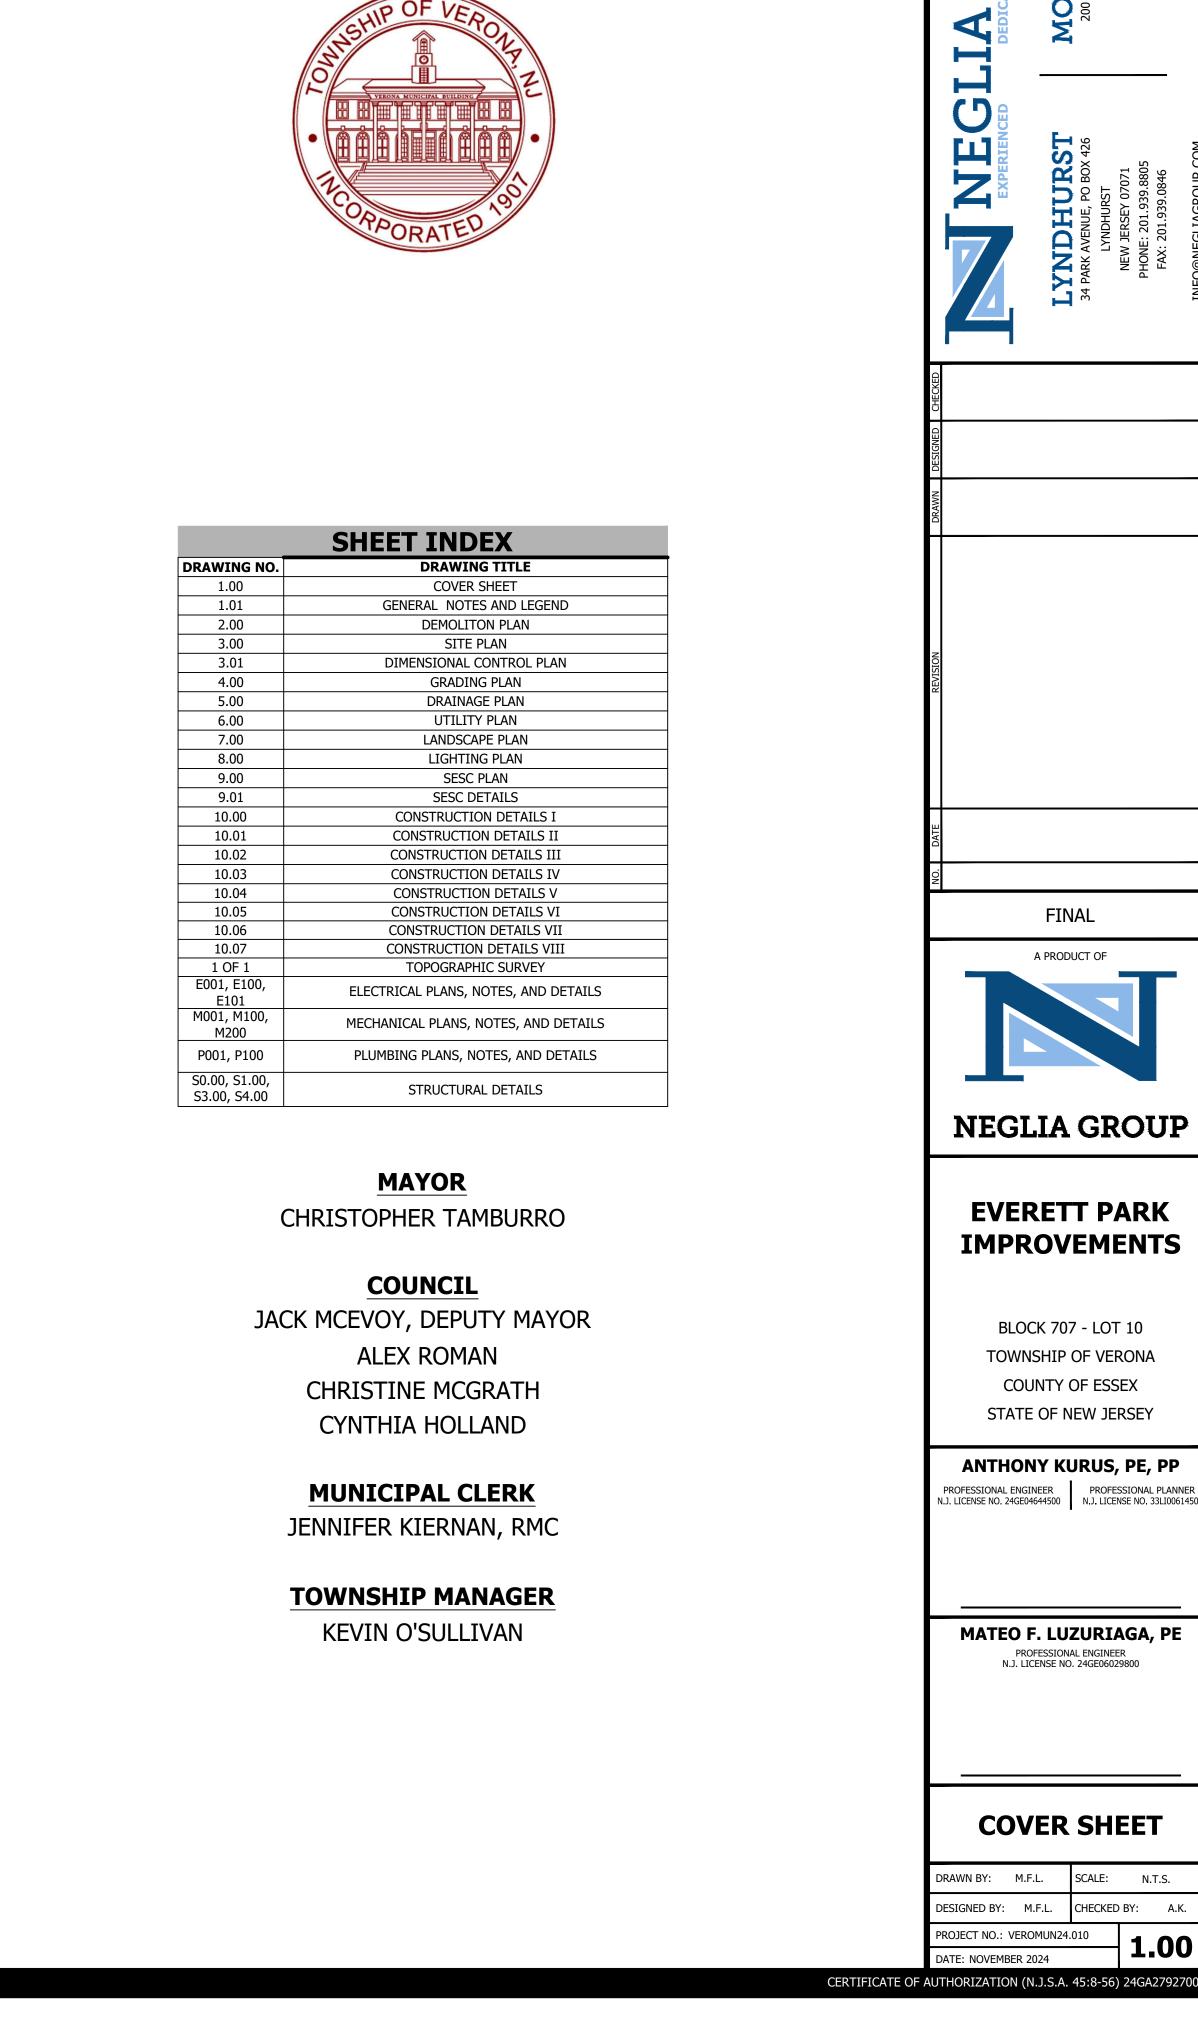



GENERAL NOTES

- A1. THE MOST CURRENT EDITIONS OF THE STANDARD SPECIFICATIONS FOR ROAD AND BRIDGE CONSTRUCTION, STANDARD INPUTS, AND STANDARD DETAILS, AS PUBLISHED BY THE NEW JERSEY DEPARTMENT OF TRANSPORTATION (NJDOT), THE PLANS, TECHNICAL SPECIFICATIONS, ADVERTISEMENT, CONTRACTOR'S PROPOSAL AND INCLUDING BUT NOT LIMITED TO THE AMENDMENTS CONTAINED HEREINAFTER SHALL COMPRISE THE CONTRACT DOCUMENTS. THE CONTRACTOR SHALL READ AND UNDERSTAND THE PROJECT SPECIFICATIONS PRIOR TO CONSTRUCTION. THE MUNICIPALITY IS UNDER THE JURISDICTION OF THE STATE CENTRAL LAW AND THE GOVERNMENT.
- A2. THE CONTRACTOR SHALL VISIT THE SITE AND FAMILIARIZE THEMSELVES WITH THE EXISTING CONDITIONS PRIOR TO SUBMITTING THEIR BID. ANY DISCREPANCIES BETWEEN THESE PLANS AND THE ACTUAL CONDITIONS AT THE SITE SHALL BE IMMEDIATELY REPORTED TO THE PROFESSIONAL ENGINEER.
- A3. THE CONTRACTOR SHALL COMPLY WITH ALL LAWS, ORDINANCES, RULES, ORDERS AND REGULATIONS RELATING TO THE PERFORMANCE OF THE WORK, THE PROTECTION OF ADJACENT
- A4. THE CONTRACTOR'S ATTENTION IS DIRECTED TO THE SAFETY REQUIREMENTS AS OUTLINED IN THE GENERAL CONDITIONS OF THE CONSTRUCTION SPECIFICATIONS. NEITHER THE ENGINEER NOR THE OWNER SHALL BE HELD RESPONSIBILITY AND/OR LIABLE FOR THE SAFETY OF THE WORK SITE. THE CONTRACTOR IS RESPONSIBLE FOR MAINTAINING A SAFE WORK SITE
- A5. THE CONTRACTOR IS RESPONSIBLE TO OBEY ALL THE SAFETY AND HEALTH REGULATIONS. THE OWNER ASSUMES NO RESPONSIBILITY FOR THE HEALTH AND SAFETY OF THE WORK
- SITE CLEARING AND CONSTRUCTION
- B1. THE CONTRACTOR SHALL OBTAIN ALL REQUIRED LOCAL, COUNTY, STATE, FEDERAL OPENING PERMITS AND SHALL BARE THE COST OF ALL ACCOMPANYING FEES. ALL PERMITS MUST BE SECURED PRIOR TO THE COMMENCEMENT OF WORK.
- B2. WHENEVER A QUESTION ARISES REGARDING THE SPECIFICATIONS OR DRAWINGS OR ANY SUPPLEMENTARY DRAWINGS OR INSTRUCTIONS OF THE ENGINEER, SAME SHALL BE IMMEDIATELY BROUGHT TO THE ATTENTION OF THE ENGINEER RESPONSIBLE FOR THE DESIGN.
- B3. ONE COPY OF THE APPROVED CONSTRUCTION PLANS AND SPECIFICATIONS FURNISHED TO THE CONTRACTOR MUST BE KEPT ON THE PROJECT SITE. ALL WORK AND MATERIALS NECESSARY FOR THE COMPLETION OF THE WORK ACCORDING TO THE INTENT AND MEANING OF THE CONTRACT DOCUMENTS, SHALL BE FURNISHED, PERFORMED AND DONE IN ACCORDANCE WITH THE SPECIFICATIONS AND PLANS. ANY CONFLICT OR INCONSISTENCY BETWEEN THE PLANS AND SPECIFICATIONS, OR ANY DISCREPANCY BETWEEN THE FIGURES AND SCALE OF DRAWINGS SHALL BE SUBMITTED BY THE CONTRACTOR TO THE ENGINEER, WHOSE DECISION THEREON SHALL BE FINAL. THE DECISION OF THE ENGINEER AS TO WHICH SPECIFICATION WILL GOVERN WILL BE
- B4. THE CONTRACTOR IS RESPONSIBLE TO CONSTRUCT THE PROJECT IN ACCORDANCE WITH THE CONTRACT DOCUMENTS. ALL PROPOSED FIELD CHANGES MUST BE APPROVED IN WRITING BY THE PROFESSIONAL ENGINEER RESPONSIBLE FOR THE DESIGN (PROJECT MANAGER, PE) PRIOR TO THE CONSTRUCTION OF ANY FIELD CHANGES.
- B5. ALL INFORMATION SHOWN OR NOTED FOR EXISTING FACILITIES, GRADES, ROADWAYS AND MATERIALS IS APPROXIMATE. THE CONTRACTOR SHALL BE RESPONSIBLE TO VERIFY ALL
- B6. ALL DISTURBED SHRUBS, FENCING, WALKWAYS, SIGNS, MAILBOXES, DRIVEWAYS, ETC., SHALL BE RESTORED TO THEIR ORIGINAL CONDITION AND TO THE SATISFACTION OF THE ENGINEER AND/OR THE OWNER. NO SEPARATE PAYMENT SHALL BE MADE FOR THIS RESTORATION WORK UNLESS SAME IS CLEARLY SPECIFIED ELSEWHERE IN THE CONSTRUCTION DOCUMENTS. THE CONTRACTOR SHALL TAKE PRUDENT MEASURES TO PROTECT ALL EXISTING PROPERTY EVIDENCE (MONUMENTS, IRON PIPE, PINS, ETC.) DURING CONSTRUCTION.
- B7. ALL PROPERTY CORNERS OR MONUMENTS REMOVED OR DAMAGED DURING CONSTRUCTION SHALL BE REPLACED BY A NJ LICENSED LAND SURVEYOR AT NO ADDITIONAL COST TO THE
- B8. RECONSTRUCTED CURB SHALL BE INSTALLED TO MATCH EXISTING CURB ELEVATIONS AND ALIGNMENT UNLESS OTHERWISE SPECIFIED ON GRADING PLANS, PROFILES OR CROSS SECTIONS. SEPARATE PAYMENT WILL NOT BE MADE FOR REMOVAL OF EXISTING CURB IN RECONSTRUCTED AREAS. PAYMENT FOR THE REMOVAL OF EXISTING CURB SHALL BE INCLUDED IN THE UNIT
- B9. THE CONTRACTOR SHALL SAWCUT AND REPAIR THE PAVEMENT ADJACENT TO NEWLY CONSTRUCTED CURB PRIOR TO PROCEEDING ON TO SUBSEQUENT STAGES OF WORK. CURB TRENCHES WILL NOT BE LEFT OPEN OVERNIGHT IN AREAS WHERE THE ROADWAY IS TO BE OPENED TO TRAFFIC. NO SEPARATE PAYMENT WILL BE GIVEN FOR SUCH SAID SAWCUTTING AND RESTORATION, THE COST OF WHICH SHALL BE INCLUDED IN THE UNIT PRICE BID FOR THE CORRESPONDING CURB LINE ITEM.
- B10. ALL ASPHALT MATERIAL REMOVED FROM THE PROJECT MUST BE TRANSPORTED TO AN APPROVED RECYCLING CENTER AND THE TONNAGE CERTIFIED TO THE OWNER. NO SEPARATE PAYMENT WILL BE MADE FOR THIS WORK BUT SHALL BE INCLUDED IN THE VARIOUS ITEMS IN THE PROPOSAL.
- 311. THE CONTRACTOR SHALL BE RESPONSIBLE FOR THE DISPOSAL OF ALL EXCESS MATERIALS EXCAVATED, WHATEVER NATURE, AT THEIR OWN EXPENSE. THE OWNER IS NOT OBLIGATED TO SUPPLY A DISPOSAL SITE. THE CONTRACTOR MUST NOT DEPOSIT THE EXCESS MATERIALS WITHIN THE MUNICIPAL LIMITS WITHOUT EXPRESS PERMISSION OF THE PROFESSIONAL ENGINEER.
- B12. ALL EXCAVATED MATERIALS ARE TO BE DISPOSED OF IN ACCORDANCE WITH APPROVED NJDOT/NJDEP METHODS AND MEANS, OR TRANSPORTED AT THE DIRECTION OF THE OWNER.

EXCAVATED MATERIAL MAY NOT BE STORED ON SITE AND SHALL BE REMOVED AT THE END OF EACH DAY.

- B13. ALL DISTURBED AREAS OUTSIDE THE PROJECT LIMITS OR NOT INTENDED TO BE INCLUDED IN THIS PROJECT, SHALL BE RESTORED TO THEIR ORIGINAL CONDITION, AND TO THE SATISFACTION OF THE OWNER. NO SEPARATE PAYMENT SHALL BE MADE FOR THIS RESTORATION, UNLESS SPECIFIED ELSEWHERE.
- B14. THE CONTRACTOR MUST PROVIDE A SMOOTH SAWCUT EDGE IN ALL CASES WHERE PROPOSED PAVEMENT OF WHATEVER NATURE, CONCRETE CURBS OR CONCRETE SIDEWALKS ABUT EXISTING PAVEMENTS, CURBS OR SIDEWALKS. NO SEPARATE PAYMENT WILL BE MADE FOR SAWCUTTING. THE COST SHALL BE INCLUDED IN THE VARIOUS ITEMS IN THE PROPOSAL.
- B15. THE CONTRACTOR MAY DISCOVER THAT EXISTING ROADWAY MAY CONTAIN EXISTING CONCRETE BASE OR COBBLE STONE AND SHALL MAKE ALL NECESSARY REQUIREMENTS FOR ITS REMOVAL WHERE REQUIRED. THE COST FOR THIS WORK SHALL BE INCLUDED IN THE COST OF EXCAVATION, UNCLASSIFIED (IF AND WHERE DIRECTED)
- B16. THE REPLACEMENT OF ANY SIDEWALK WITHIN THE PROJECT AREA MAY REQUIRE THAT SIDEWALK SLABS BE SAWCUT FROM THE SURROUNDING CONCRETE WALK. NO SPECIFIC PAYMENT FOR SAW CUTTING WILL BE MADE AND THEREFORE SHALL BE INCLUDED UNDER PRICES BID FOR CONCRETE SIDEWALK ITEMS IN THE PROPOSAL.
- B17. AS PART OF THIS CONTRACT, THE CONTRACTOR IS REQUIRED TO PREPARE THE EXISTING PAVEMENT AND SEAL ALL CRACKS AND JOINTS PER SECTION 404 OF THE NJDOT SPECIFICATIONS PRIOR TO RESURFACING. THIS WORK SHALL INCLUDE, BUT IS NOT LIMITED TO, ALL LABOR, MATERIALS AND EQUIPMENT NECESSARY TO CLEAN CRACKS PRIOR TO THE INSTALLATION OF SURFACE COURSE AND APPLY A SEALANT AS OUTLINED IN THE NIDOT SPECIFICATION. PRIOR TO COMMENCEMENT, THE CONTRACTOR SHALL OBTAIN APPROVAL FROM THE PROFESSIONAL ENGINEER AS TO THE INTENDED METHODS AND MATERIALS THAT WILL BE USED FOR THIS PROJECT. THIS ITEM SHALL NOT BE MEASURED FOR PAYMENT, BUT THE COST THEREOF SHALL BE INCLUDED IN THE UNIT PRICE BIDS FOR THE CORRESPONDING HOT MIX ASPHALT SURFACE COURSE LINE ITEM.
- B18. NO CONSTRUCTION, MAINTENANCE OR UTILITY WORK ON, UNDER OR ABOVE THE PROJECT ROAD THAT WILL OBSTRUCT, INTERFERE WITH AND/OR DETOUR TRAFFIC ON THE ROAD, SHALL BE PERFORMED BEFORE THE HOUR OF 9:00 AM OR AFTER 4:00 PM. THE CONTRACTOR'S WORK HOURS SHALL CONFORM TO LOCAL ORDINANCE REQUIREMENTS.

- B. <u>SITE CLEARING AND CONSTRUCTION (CONT.)</u>
- B19. ALL TRENCHES IN THE EXISTING PAVEMENT SHALL BE SAW CUT. NO SEPARATE PAYMENT WILL BE MADE FOR SAW CUTTING AND THE COST THEREOF SHALL BE INCLUDED UNDER PRICES BID
- B20. THE CONTRACTOR SHALL BE RESPONSIBLE FOR RESTORATION AND MAINTENANCE OF ALL ACCESS DRIVEWAYS AT ALL TIMES DURING CONSTRUCTION AT NO ADDITIONAL COST TO THE
- B21. ALL SEDIMENT AND SOIL EROSION CONTROL PRACTICES ARE TO BE INSTALLED IN CONFORMANCE WITH SOIL CONSERVATION DISTRICT STANDARDS PRIOR TO ANY MAJOR SOIL DISTURBANCES. ALL WORK SHALL BE COMPLETED IN PROPER SEQUENCE AND ALL EROSION CONTROL DEVICES SHALL BE MAINTAINED UNTIL PERMANENT PROTECTION IS ESTABLISHED.
- B22. CONTRACTOR SHALL MAINTAIN ACCESS TO ALL PROPERTIES AT ALL TIMES DURING CONSTRUCTION.
- B23. THE CONTRACTOR SHALL TAKE ALL NECESSARY MEASURES TO MAINTAIN DUST CONTROL AS REQUIRED OR DIRECTED BY THE PROFESSIONAL ENGINEER. ALL VEHICLES SHALL BE CLEAN AND ALL ROADWAYS SHALL BE MAINTAINED AS DIRECTED BY THE PROFESSIONAL ENGINEER.
- B24. CONTRACTOR SHALL KEEP THE SITE CLEAN AT ALL TIMES AND SWEEP THE STREET AT THE END OF EACH WORK DAY.
- B25. ALL MATERIAL ENCOUNTERED WITHIN THE WORK ZONE AREA THAT MUST BE REMOVED TO CONSTRUCT THE PROJECT AS DIRECTED BY THE ENGINEER, SHALL BE INCLUDED IN THE UNIT PRICE BID FOR CLEARING SITE. THIS IS INCLUSIVE OF BUT NOT LIMITED TO THE REMOVAL OF ALL CURBED EDGING AND CONCRETE GUTTER.
- B26. ALL TREES ARE TO BE SAVED AND PROTECTED FROM HARM DURING CONSTRUCTION WITH THE EXCEPTION OF THE TREES MARKED WITH AN X ON THE CONSTRUCTION PLANS. IF ANY TREES ARE DAMAGED DURING CONSTRUCTION, THE CONTRACTOR WILL BE RESPONSIBLE FOR THE REMOVAL AND REPLACEMENT AS DETERMINED BY THE MUNICIPALITY.
- B27, ALL TREES TO BE REMOVED SHALL BE MARKED WITH A REMOVABLE TIED RIBBON BY THE CONTRACTOR AND SHALL BE APPROVED BY THE OWNER PRIOR TO ANY TREE REMOVALS. NO PERMANENT PAINT SHALL BE SPRAYED ON THE EXISTING TREES. EACH TREE THAT HAS BEEN APPROVED FOR REMOVAL, SHALL BE COMPLETELY REMOVED, EXCEPT IN CASES WHERE THE TREE STUMP CANNOT BE REMOVED. THE CONTRACTOR SHALL GRIND THE STUMPS THAT COULD NOT BE REMOVED SO THAT THE STUMP IS TWELVE (12) INCHES BELOW THE EXISTING GROUND
- B28. THE CONTRACTOR SHALL INSTALL PROTECTIVE BLOCKING, BRACING OR SHEETING TO SUPPORT ANY EXPOSED GAS, WATER, SANITARY, TELECOMMUNICATIONS, OR ELECTRIC UTILITIES IN ACCORDANCE WITH THE RESPECTIVE UTILITY COMPANY'S REGULATIONS.
- B29. THE CONTRACTOR SHALL BE RESPONSIBLE FOR TAPERING PROPOSED WORK TO MEET EXISTING CONDITIONS IN A UNIFORM MANNER.
- . PRIOR TO THE START OF CONSTRUCTION, THE CONTRACTOR SHALL HAVE ALL UNDERGROUND UTILITIES LOCATED AND PHYSICALLY MARKED OUT WITHIN THE LIMITS OF THE PROJECT (CALL 1-800-272-1000). THE CONTRACTOR SHALL PROVIDE TEST HOLES IN AREAS OF POSSIBLE CONFLICT TO VERIFY THE DEPTH AND LOCATION OF THE UTILITY. NO SEPARATE PAYMENT SHALL BE MADE FOR DELAYS THAT MAY BE NECESSARY TO RELOCATE UTILITIES OR THE PROPOSED LOCATION OF UNDERGROUND UTILITIES. NO SEPARATE PAYMENT WILL BE MADE FOR TEST PITS BUT THE COST SHALL BE INCLUDED IN THE VARIOUS ITEMS IN THE PROPOSAL.
- C2. LOCATION AND DEPTH OF EXISTING UTILITIES ARE ONLY INDICATED TO BRING ATTENTION TO POSSIBLE CONFLICTS. ANY DAMAGE TO UTILITIES SHALL BE THE SOLE RESPONSIBILITY OF THE CONTRACTOR AND ALL COSTS FOR REPAIRS SHALL BE BORNE BY THE CONTRACTOR.
- C3. ANY DAMAGE TO UTILITIES SHALL BE THE SOLE RESPONSIBILITY OF THE CONTRACTOR AND ALL COSTS FOR REPAIR SHALL BE BORNE BY THE CONTRACTOR. ALL DISTURBED OR DAMAGED WALKWAYS, SIGNS, CURBING, TREES, HYDRANTS, UTILITIES, PAVED SURFACES, DRIVEWAYS, BUILDING FACADES, ETC. SHALL BE RESTORED TO THEIR ORIGINAL CONDITION AND TO THE SATISFACTION OF THE OWNER. NO SEPARATE PAYMENT WILL BE MADE FOR THIS RESTORATION UNLESS SPECIFIED ELSEWHERE IN THE CONTRACT.
- C4. THE LOCATIONS OF UTILITIES SHOWN ARE APPROXIMATE. THE CONTRACTOR IS RESPONSIBLE FOR VERIFYING THE EXACT LOCATIONS OF THE UTILITIES PRIOR TO THE START OF
- C5. ALL GAS AND WATER VALVES AND VARIOUS MANHOLES TO REMAIN SHALL BE RESET TO FINISH GRADE.
- C6. THE CONTRACTOR SHALL COORDINATE ALL WORK WITH THE PUBLIC UTILITY COMPANIES. ELECTRIC, TELEPHONE, GAS & CABLE UTILITY MANHOLE CASTINGS AND VALVE BOX COVERS SHALL BE RESET BY THE RESPECTIVE UTILITY COMPANIES.
- C7. PRIVATE UTILITY COMPANIES MUST BE CONTACTED BY THE CONTRACTOR SO THAT PRIVATELY OWNED CASTINGS WILL BE RESET AS REQUIRED.
- C8. WATER SERVICE VALVE BOXES, GAS SERVICE VALVE BOXES, JUNCTION BOXES, ELECTRIC BOXES, BASEMENT VAULT DOORS AND ALL OTHER APPURTENANCES LOCATED IN THE SIDEWALK AREA SHALL BE RESET TO THE NEW SIDEWALK ELEVATION. THE COST FOR RESETTING ANY AND ALL OF THESE CASTINGS SHALL NOT BE PAID SEPARATELY BUT SHALL BE INCLUDED IN THE VARIOUS CONCRETE SIDEWALK LINE ITEMS IN THE PROPOSAL.
- C9. THE CONTRACTOR IS RESPONSIBLE FOR ACCURATELY LOCATING EXISTING TRAFFIC SIGNAL LOOP DETECTOR AND LEADS. THE CONTRACTOR WILL ONLY BE COMPENSATED FOR THE REPLACEMENT OF LOOP DETECTORS AND LEADS WHICH HAVE BEEN REMOVED AT THE DIRECTION OF THE PROFESSIONAL ENGINEER. THE CONTRACTOR SHALL NOT REMOVE LOOP DETECTORS AND LEADS UNLESS DIRECTED TO DO SO BY THE PROFESSIONAL ENGINEER.
- C10. TRENCHES SHALL BE BACKFILLED WITHOUT DELAY, OPEN EXCAVATIONS SHALL BE KEPT TO A MINIMUM AND MADE SAFE AT ALL TIMES. ALL TRENCHES SHALL BE ADEQUATELY COMPACTED BY APPROVED METHODS AND WITH MATERIALS APPROVED BY THE FIELD ENGINEER. ANY TRENCH SETTLEMENT SHALL BE IMMEDIATELY BROUGHT TO GRADE AND TEMPORARY PAVING SHALL BE PLACED WHERE REQUIRED. NO TRENCH (INCLUDING CURBS) SHALL BE LEFT OPEN OVERNIGHT.
- C11. THE CONTRACTOR SHALL PROVIDE AND MAINTAIN TEMPORARY RAMPS AROUND ALL EXPOSED UTILITY CASTINGS, BOTH PUBLIC AND PRIVATE WHICH HAVE BEEN UNCOVERED DURING CONSTRUCTION.

- D1. THE CONTRACTOR IS RESPONSIBLE TO CLEAN AND MAINTAIN ALL EXISTING DRAINAGE STRUCTURES PRIOR TO THE START OF CONSTRUCTION WITHIN THE PROJECT LIMITS.
- D2. ALL EXISTING STORM SEWER PIPES WITHIN PROJECT LIMITS MUST BE CLEANED BY THE CONTRACTOR AFTER COMPLETION OF CONSTRUCTION. THE COST FOR CLEANING SHALL NOT BE PAID SEPARATELY BUT SHALL BE INCLUDED IN THE VARIOUS DRAINAGE ITEMS IN THE PROPOSAL.
- D3. ALL ROOF LEADERS AND CURB DRAINS ARE TO REMAIN FREE FLOWING, DURING CONSTRUCTION.
- D4. ALL ROOF DRAIN PIPES IN CURB/SIDEWALK AREA TO BE MAINTAINED AND RECONNECTED, AND SHALL BE EXTENDED UNDER THE SIDEWALK AND THROUGH THE CURB.

- D5. ALL INLETS, MANHOLES AND VAULT CASTINGS TO BE RESET SHALL BE RESET TO THE PROPOSED FINISHED GRADE AS DIRECTED BY THE FIELD ENGINEER. THESE CASTINGS MUST BE RESET FLUSH TO THE PROPOSED GRADE AND THE NEW PAVEMENT SHALL NOT BE MOUNDED UP OR FEATHERED DOWN TO MEET THESE CASTINGS. ALL CASTINGS RESET TO THE IMPROPER GRADE OR NOT TO THE SATISFACTION OF THE FIELD ENGINEER SHALL BE RESET TO THE NEW GRADE AT NO ADDITIONAL EXPENSE TO THE OWNER.
- D6. EXISTING GRATES ARE THE PROPERTY OF THE MUNICIPALITY OR UTILITY AUTHORITY AND WILL BE DELIVERED, AT NO ADDITIONAL COST TO THE OWNER, TO THE LOCAL DEPARTMENT OF
- D8. THE CONTRACTOR WILL BE RESPONSIBLE FOR MAINTAINING POSITIVE DRAINAGE DURING AND AFTER CONSTRUCTION. IF A SITUATION ARISES WHERE WATER WILL POND AT A PARTICULAR

- E1. THE CONTRACTOR SHALL BE RESPONSIBLE FOR COORDINATION OF TRAFFIC CONTROL MEASURES.
- E2. MAINTENANCE AND PROTECTION OF PEDESTRIAN TRAFFIC CONTROL MUST CONFORM TO NJDOT AND MUTCD STANDARDS ALONG WITH THE REQUIREMENTS OF THE MUNICIPALITY. POLICE TRAFFIC DIRECTORS SHALL BE COORDINATED WITH THE MUNICIPALITY, AS NEEDED.
- E3. THE CONTRACTOR SHALL BE RESPONSIBLE TO PREPARE A DETOUR PLAN AS NEEDED OR REQUIRED BY THE OWNER AND/OR LOCAL POLICE DEPARTMENT FOR REVIEW AND APPROVAL PRIOR
- F1. ANY SIGNS LOCATED WITHIN THE SIDEWALK AREAS SHOULD BE RESET/RELOCATED IN ACCORDANCE WITH THE STANDARD NJDOT STANDARD DETAILS. SEPARATE PAYMENT WILL NOT BE MADE FOR RESETTING OBJECTS LOCATED IN THE SIDEWALK. THE COST SHALL BE INCLUDED IN THE UNIT PRICE BID FOR THE REPLACEMENT OF SIDEWALKS, UNLESS PAYMENT FOR SUCH WORK IS SPECIFIED IN THE PROPOSAL.
- F2. THE CONTRACTOR SHALL RELOCATE/RESET SIGNS AS SHOWN ON THE PLANS OR DIRECTED BY THE PROFESSIONAL ENGINEER. NO SEPARATE PAYMENT WILL BE MADE FOR THIS WORK BUT THE COST SHALL BE INCLUDED IN THE VARIOUS ITEMS IN THE PROPOSAL.
- F3. SIGNS FOR PARKING PROHIBITION MUST BE POSTED AT LEAST 48 HOURS IN ADVANCE OF CONSTRUCTION. CONTRACTOR SHALL COORDINATE, OBTAIN AND PLACE SIGNS AS DIRECTED BY

- G1. LAYOUT OF ALL WORK SHALL BE ADJUSTED IN THE FIELD TO MEET SITE CONDITIONS AS APPROVED IN WRITING BY THE PROFESSIONAL ENGINEER RESPONSIBLE FOR THE DESIGN.
- G2. THE CONTRACTOR IS RESPONSIBLE TO LAYOUT ALL NEW WORK PRIOR TO CONSTRUCTION FOR FIELD ENGINEER'S APPROVAL. ANY LOCATIONS NOT APPROVED BY THE FIELD ENGINEER AND

- H2. ALL TREES THAT HAVE ROOTS THAT ENCROACH INTO THE PROPOSED CURBS OR PAVEMENT AND ARE TO BE SAVED SHALL BE EVALUATED BY THE CONTRACTOR'S CERTIFIED TREE EXPERT. ALL EVALUATIONS SHALL BE IN WRITING AND SHALL ACCURATELY IDENTIFY THE TREE IN QUESTION BY STATION AND OFFSET (LEFT OR RIGHT). ALL EVALUATIONS SHALL BE SUBMITTED TO THE PROFESSIONAL ENGINEER FOR REVIEW AND CONSULTATION WITH THE MUNICIPALITIES TREE EXPERTS PRIOR TO CUTTING ANY ROOTS. NO SEPARATE PAYMENT WILL BE MADE FOR THIS
- H3. TREES THAT ARE TO BE SAVED, WHERE IT IS DETERMINED THAT ROOT CUTTING MAY SEVERELY DAMAGE THE TREE, SHALL HAVE A CURB BREAK AND STEEL CURB FACE PLATES INSTALLED AS
- H5. IN AREAS WHERE THE ROOTS ENCROACH INTO THE CURB LINE, THE FULL PAVEMENT SECTION SHALL BE REMOVED PRIOR TO REMOVING THE CURB. THEN THE EXISTING CURB SHALL BE REMOVED BY PULLING IT AWAY FROM THE TREE TOWARDS THE ROADWAY TO MINIMIZE ROOT DAMAGE DURING THE REMOVAL OF THE EXISTING CURB. NO SEPARATE PAYMENT SHALL BE

ADA REQUIREMENTS

- II. THE CONTRACTOR SHALL BE FULLY RESPONSIBLE FOR COMPLYING WITH NJDOT AND ADA REQUIREMENTS RELATED TO THE INSTALLATION OF HANDICAP ACCESSIBLE RAMPS AND THE ASSOCIATED SLOPES. THE RAMPS AND ALIGNMENTS ILLUSTRATED ON THESE PLANS SHALL BE USED FOR SCHEMATIC PURPOSES ONLY. THE CONTRACTOR SHALL BE FULLY RESPONSIBLE FOR PROPER CONSTRUCTION AND ALIGNMENT IN THE FIELD.
- STANDARDS, ONCE CONSTRUCTED, SHALL BE REPLACED TO MEET SAID STANDARDS AT NO ADDITIONAL COST TO THE OWNER.
- CONTRACTOR SHALL BE RESPONSIBLE FOR ALL CORRECTIONS TO A RAMP SHOULD THEY PROCEED WITH DEMOLITION PRIOR TO CONFIRMATION OF CONSTRUCTABILITY AT NO ADDITIONAL

- PUBLIC WORKS OR UTILITY AUTHORITY YARD. PAYMENT WILL NOT BE MADE FOR NEW GRATES UNLESS THE EXISTING GRATES ARE RETURNED TO THE OWNER.
- D7. ALL OPEN DRAINAGE EXCAVATIONS SHALL BE BACKFILLED AT THE END OF EACH DAY AND PROTECTED FROM PEDESTRIAN AND VEHICULAR TRAFFIC.
- LOCATION, THE PROFESSIONAL ENGINEER RESPONSIBLE FOR THE DESIGN MUST BE NOTIFIED IMMEDIATELY IN ORDER TO MAKE CORRECTIVE MEASURES IN WRITING.
- D9. THE CONTRACTOR IS FULLY RESPONSIBLE FOR VERIFYING THAT ALL PROPOSED STORM SEWER CONNECTIONS ARE TO THE EXISTING STORM SEWER SYSTEMS.

- TO STARTING WORK.

- INSTALLED BY THE CONTRACTOR SHALL BE REMOVED AND REPLACED AS PER THE FIELD ENGINEER'S INSTRUCTIONS AT NO ADDITIONAL COST TO THE OWNER.
- G3. ALL LAYOUT WORK SHALL BE DONE BY A NEW JERSEY LICENSED LAND SURVEYOR.
- G4. ALL EXISTING LOCATIONS TAKEN FROM A SURVEY PREPARED BY NEGLIA GROUP.

- H1. CONTRACTOR MUST RETAIN A CERTIFIED TREE EXPERT FOR TREE EVALUATION WHERE NECESSARY. NO ADDITIONAL PAYMENT WILL BE MADE FOR TREE EXPERT; PRICE TO BE INCLUDED IN SITE CLEARING.
- WORK BUT THE COST THEREOF SHALL BE INCLUDED IN THE CLEARING SITE ITEM.
- H4. THE CONTRACTOR IS RESPONSIBLE FOR THE TIMELY EVALUATION OF ALL TREES AND THERE WILL NOT BE CHANGE ORDERS FOR DELAYS RESULTING FROM ROOT CUTTING.
- MADE FOR THIS WORK BUT THE COST THEREOF SHALL BE INCLUDED IN THE CLEARING SITE LINE ITEM.

- 12. IT IS THE CONTRACTOR'S RESPONSIBILITY TO VERIFY THAT THE PROPOSED DROP CURB RAMPS MEET CURRENT NJDOT AND ADA STANDARDS. THOSE RAMPS THAT DO NOT MEET
- 13. THE CONTRACTOR IS RESPONSIBLE FOR DETERMINING THE EXTENT OF IMPROVEMENTS REQUIRED FOR THOSE RAMP LOCATIONS IDENTIFIED AND COMPLETING SAID WORK TO ENSURE RAMPS ARE IN CONFORMANCE WITH CURRENT NJDOT AND ADA STANDARDS
- I4. CONTRACTOR SHALL NOT BEGIN SITE CLEARING OPERATIONS ON A RAMP UNTIL VERIFIED THAT THE RAMP CAN BE CONSTRUCTED TO COMPLY WITH APPLICABLE STANDARDS. THE

PAVEMENT MARKING STANDARD

ALL TRAFFIC CONTROL DEVICES SHALL CONFORM TO THE CURRENT MANUAL ON UNIFORM TRAFFIC CONTROL DEVICES

AND



EVERETT PARK IMPROVEMENTS

NEGLIA GROUP

BLOCK 707 - LOT 10 TOWNSHIP OF VERONA COUNTY OF ESSEX

ANTHONY KURUS, PE, PP

PROFESSIONAL ENGINEER
N.J. LICENSE NO. 24GE04644500
PROFESSIONAL PLANNER
N.J. LICENSE NO. 33L10061450

STATE OF NEW JERSEY


MATEO F. LUZURIAGA, PE PROFESSIONAL ENGINEER N.J. LICENSE NO. 24GE06029800

GENERAL NOTES AND LEGEND

DESIGNED BY: M.F.L. CHECKED BY: A.K. PROJECT NO.: VEROMUN24.010 DATE: NOVEMBER 2024

SCALE: N.T.S.

DRAWN BY: M.F.L.

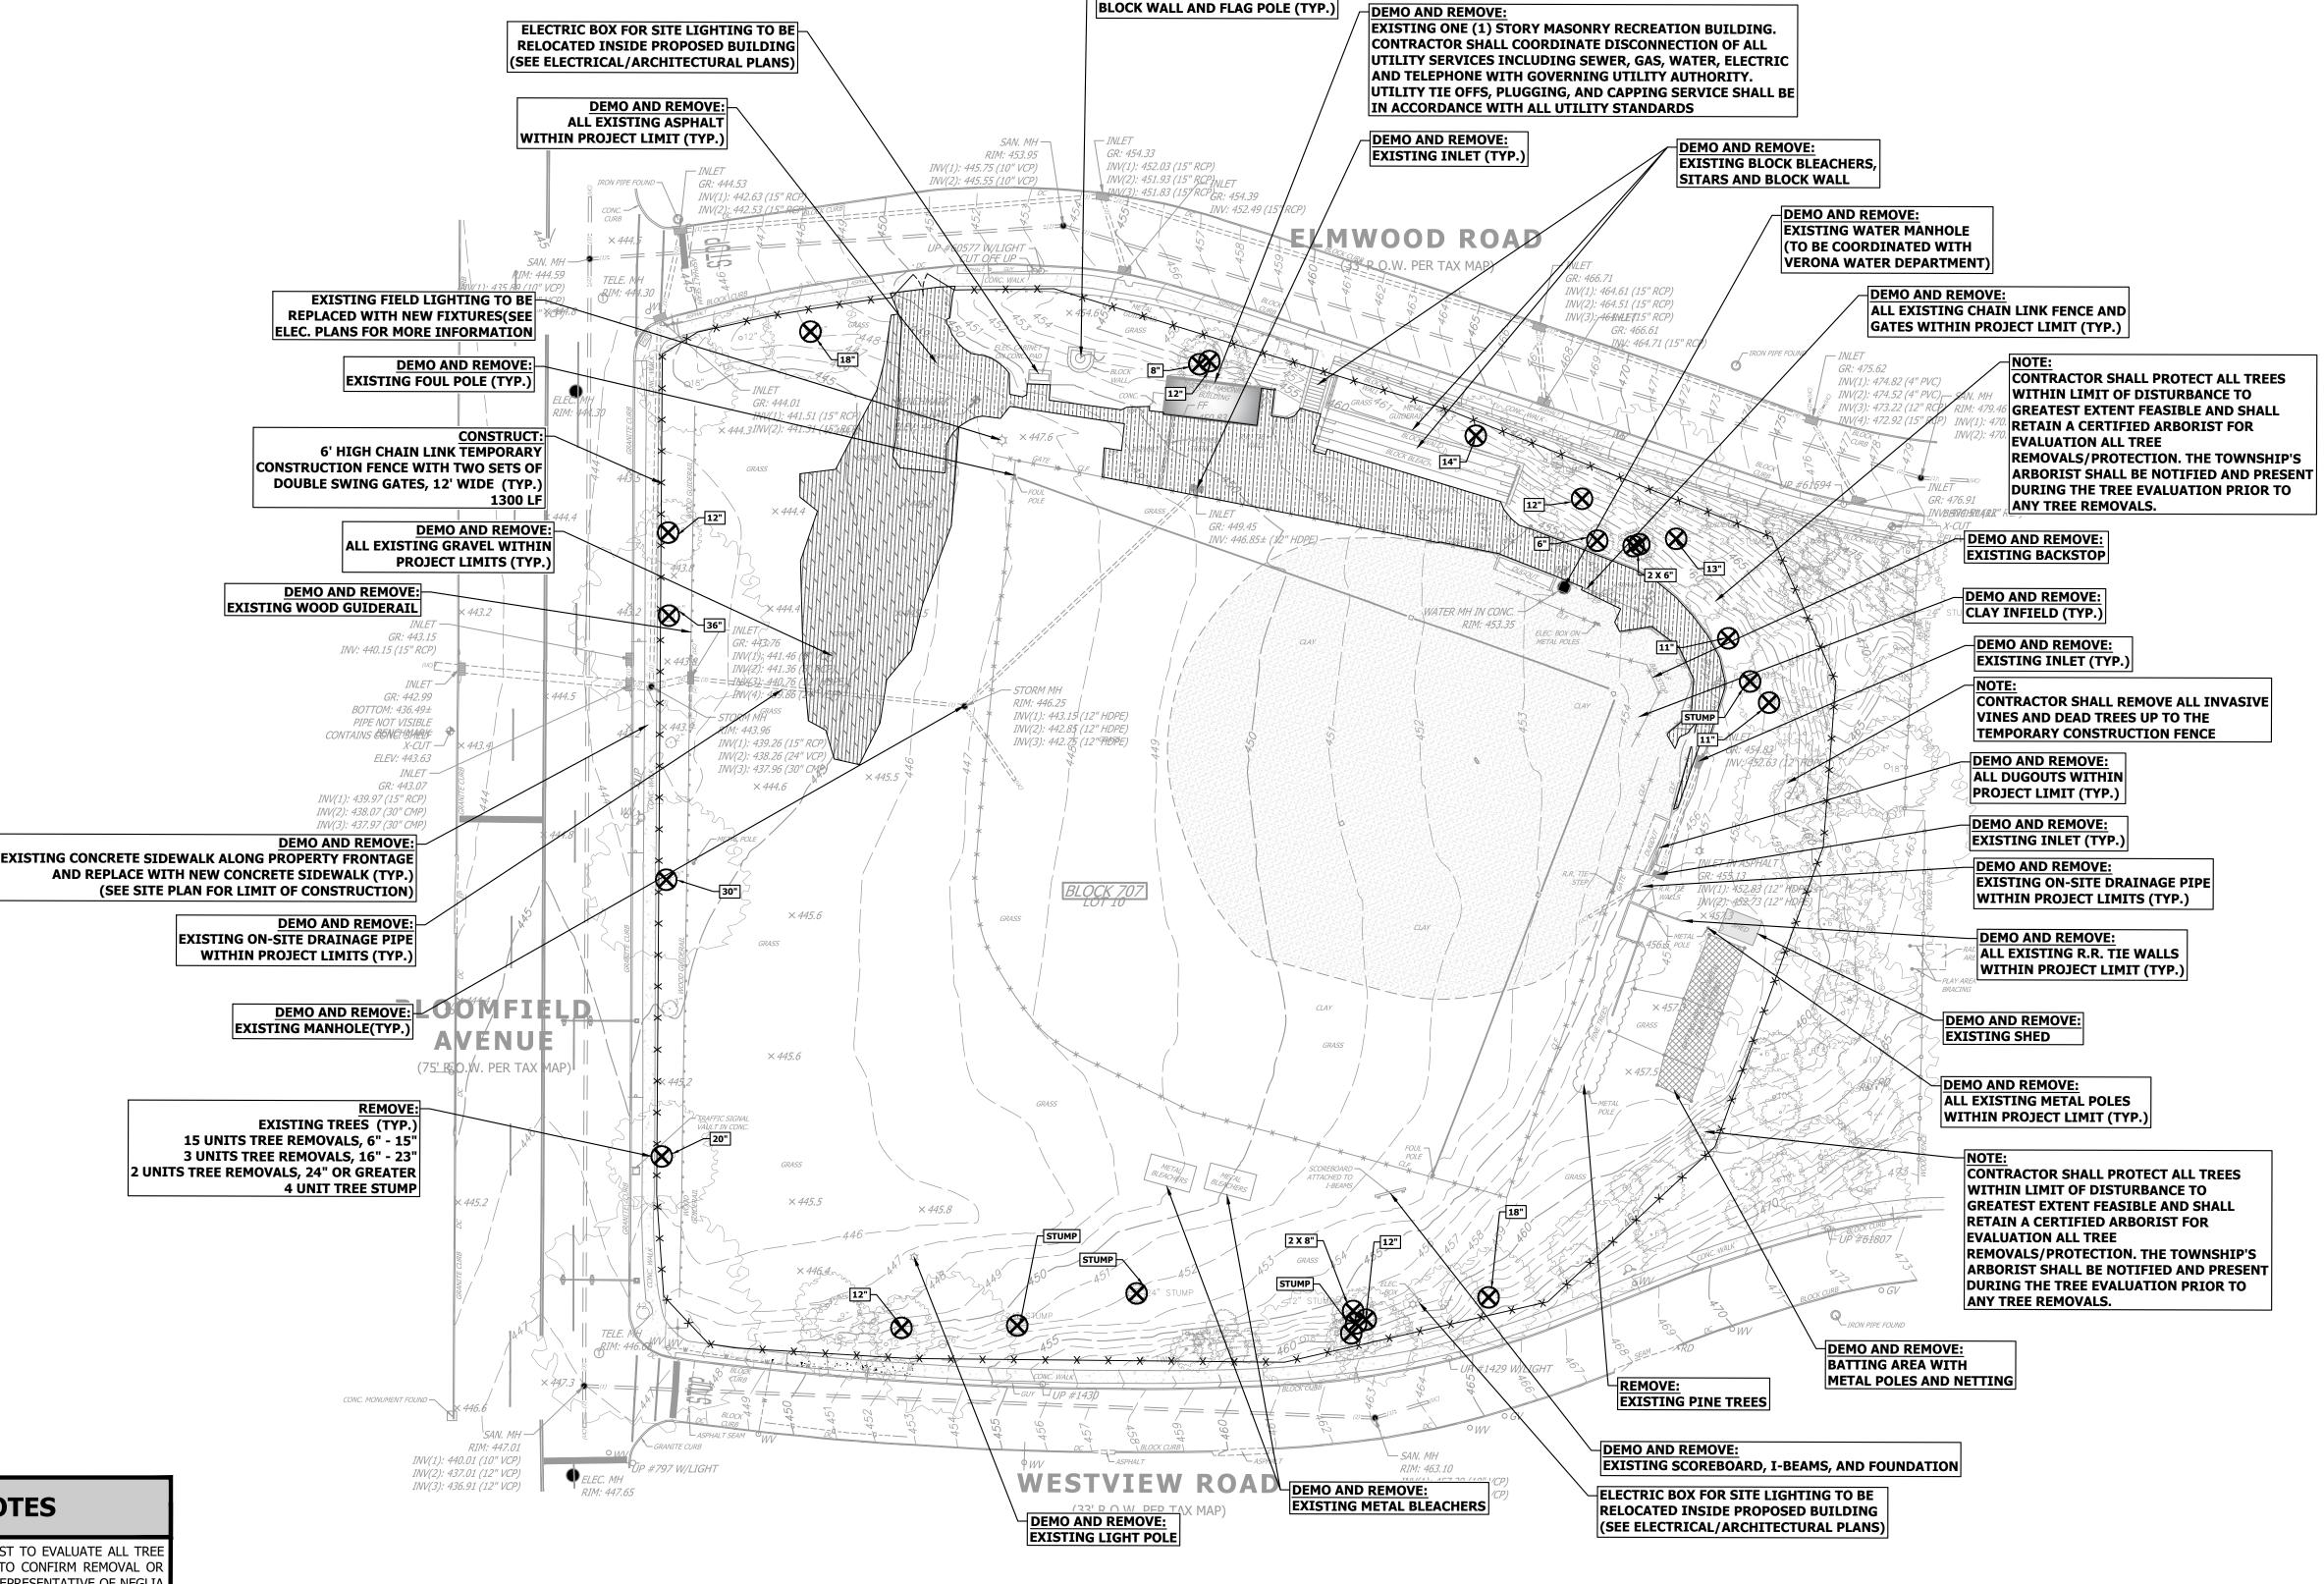

DEMO AND REMOVE:

TREE REMOVAL NOTES

- CONTRACTOR SHALL RETAIN A CERTIFIED ARBORIST TO EVALUATE ALL TRI REMOVALS WITHIN THE LIMIT OF DISTURBANCE TO CONFIRM REMOVAL O PROTECTION. THE TOWNSHIP'S ARBORIST AND A REPRESENTATIVE OF NEGLIA GROUP SHALL BE PRESENT DURING THE EVALUATION.
- FINAL LIST OF ALL TREE'S BEING REMOVED SHALL BE PROVIDED TO TH TOWNSHIP'S ARBORIST FOR REVIEW PRIOR TO ANY TREE REMOVAL. ALL TREES DESIGNATED TO BE REMOVED SHALL BE IDENTIFIED WITH AN ORANGE REMOVABLE RIBBON. NO SPRAY PAINT ON TREES IS PERMITTED.

TREE REMOVAL SUMMARY

TREE REMOVALS OF 6" DPM BUT LESS THAN 16"

15 TREE REPLACEMENTS REQ. PER ORD.

TREE REMOVAL OF 24" OR GREATER TREE REMOVAL

TREE REMOVAL OF 16" BUT LESS THAN 24" TREE REMOVAL 6 TREE REPLACEMENTS REQ. PER ORD. 8 TREE REPLACEMENTS REQ. PER ORD

TOTAL OF 29 TREE REPLACEMENTS REQ.

GENERAL NOTES

EXISTING CONDITIONS AS PER PLAN ENTITLED, "TOPOGRAPHIC SURVEY, EVERETT PARK, BLOCK 707 LOT 10, TOWNSHIP OF VERONA, ESSEX COUNTY, NEW JERSEY," PREPARED BY NEGLIA ENGINEERING ASSOCIATES, DATED JUNE 6, 2023.

- **DEMOLITION PLAN NOTES**
- BURNING DEBRIS IS PROHIBITED. THE USE OF EXPLOSIVES IS PROHIBITED.

FEDERAL, STATE, AND COUNTY JURISDICTIONS FOR ALL PHASES AND OPERATIONS OF THE WORK.

- PROTECT UTILITIES DURING THE WORK OF THIS SECTION, UNLESS OTHERWISE NOTED ON THIS PLAN. CONTRACTOR SHALL VERIFY THE LOCATION WITHIN AND SURROUNDING THE DEMOLITION LIMITS.
- REMOVAL AND DISPOSAL OF CONCRETE AND BITUMINOUS SIDEWALK, WALLS, FENCES, DECKING, TREES, SHRUBS, HEDGES, BRUSH, STUMPS, ROOTS, DIRT, STONE, DEBRIS, SURPLUS MATERIALS, RUBBISH, AS 14. DO NOT STORE, SELL, OR BURN MATERIALS ON COUNTY PROPERTY. SHOWN OR OTHERWISE DIRECTED. PAVERS SHALL BE CAREFULLY REMOVED AND STOCKPILED FOR 15. ALL DEMOLITION WORK SHALL BE IN ACCORDANCE WITH COUNTY, STATE, AND FEDERAL REGULATIONS. REINSTALLATION.
- REMOVE CURBS, DECKING, SLABS ON GRADE, AND FENCES AS SHOWN OR DIRECTED OTHERWISE. REPAIR ANY AND ALL DAMAGED OR INJURY TO THE ADJOINING PROPERTIES CAUSED BY THE WORK AND LEAVE THE PROPERTIES IN AS GOOD CONDITION AS BEFORE WORK WAS STARTED. THE CONTRACTOR SHALL RELIEVE THE OWNER OF ALL RESPONSIBILITY FOR ANY CLAIMS DUE TO SUCH INJURY AND SHALL DEFEND ANY ACTION BROUGHT BY REASON THEREOF.
- IF SO DIRECTED, THE CONTRACTOR SHALL THOROUGHLY WET THE WORK TO PREVENT DUST.
- DETAIL FOR IMPLEMENTATION OF PROTECTION MEASURES. 11. REMOVE DEMOLITION DEBRIS AND EXCESS FILL FROM THE PROJECT SITE AS SOON AS PRACTICABLE, EVERYDAY.
- BEFORE THE DEMOLITION WORK IS STARTED, CONTRACTOR SHALL OBTAIN ALL PERMITS REQUIRED BY 12. THE REMOVAL AND DISPOSAL OF MATERIALS AND DEBRIS ACCUMULATED BY CLEARING SITE IS REGULATED UNDER THE SOLID WASTE MANAGEMENT ACT (NJSA 13:1 E-1) AND IS GOVERNED BY NJAC 7:26 ET SEQ. THE CONTRACTOR SHALL DISPOSE OF THE MATERIAL AND DEBRIS ACCORDING TO THE SOLID WASTE MANAGEMENT PLAN DEVELOPED BY THE SOLID WASTE MANAGEMENT DISTRICT OF ORIGIN. PROPER DOCUMENTATION FROM THE DISPOSAL FACILITY SHALL BE SUBMITTED TO THE ENGINEER.
 - 13. TRANSPORT DEMOLITION DEBRIS AND EXCESS FILL TO DESIGNATED DISPOSAL AREA AS SOON AS PRACTICABLE. GRADE DISPOSAL AREAS TO ADJACENT CONTOURS AND SLOPE TO DRAIN.
 - 16. VARIOUS UTILITIES SHOWN ON THESE PLANS IS BASED ON RECORDS OF THE VARIOUS UTILITY COMPANIES AND WHERE POSSIBLE FIELD MEASUREMENTS. THE INFORMATION IS NOT TO BE RELIED ON AS BEING COMPLETE OR EXACT. THE CONTRACTOR MUST CONTACT ALL THE APPROPRIATE UTILITY COMPANIES AT LEAST 48 HOURS BEFORE ANY WORK OR EXCAVATION TO REQUEST A FIELD MARK OUT OF EXISTING UTILITIES. THE CONTRACTOR MUST CALL 1800-242-1000 BEFORE COMMENCEMENT OF WORK. IT SHALL BE THE CONTRACTOR'S RESPONSIBILITY TO LOCATE ALL ON SITE UTILITIES PRIOR TO START OF DEMOLITION WORK.

10. PROTECT TREES NOT DESIGNATED FOR REMOVAL AS SHOWN ON THE PLANS, SEE TREE PROTECTION 17. CONTRACTOR SHALL PREPARE AND SUBMIT FOR APPROVAL BY THE OWNER'S ENGINEER A PLAN DETAILING THE LOCATIONS OF THE TEMPORARY FENCING, GATES, BARRICADES AND OTHER ITEMS REQUIRED TO SECURE THE DEMOLITION WORK AREA AND TO PROTECT THE PUBLIC.

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YNDHURST
34 PARK AVFNIF PO ROY 476

FINAL



NEGLIA GROUP

EVERETT PARK IMPROVEMENTS

BLOCK 707 - LOT 10 TOWNSHIP OF VERONA COUNTY OF ESSEX STATE OF NEW JERSEY


ANTHONY KURUS, PE, PP

PROFESSIONAL ENGINEER
N.J. LICENSE NO. 24GE04644500
PROFESSIONAL PLANNER
N.J. LICENSE NO. 33L10061450

MATEO F. LUZURIAGA, PE PROFESSIONAL ENGINEER N.J. LICENSE NO. 24GE06029800

DEMOLITON PLAN

	DATE: NOVEMB	4	.00		
ı	PROJECT NO.: \	7	00		
	DESIGNED BY:	M.F.L.	CHECKED	BY:	A.K.
	DRAWN BY:	M.F.L.	SCALE:		AS NOTED

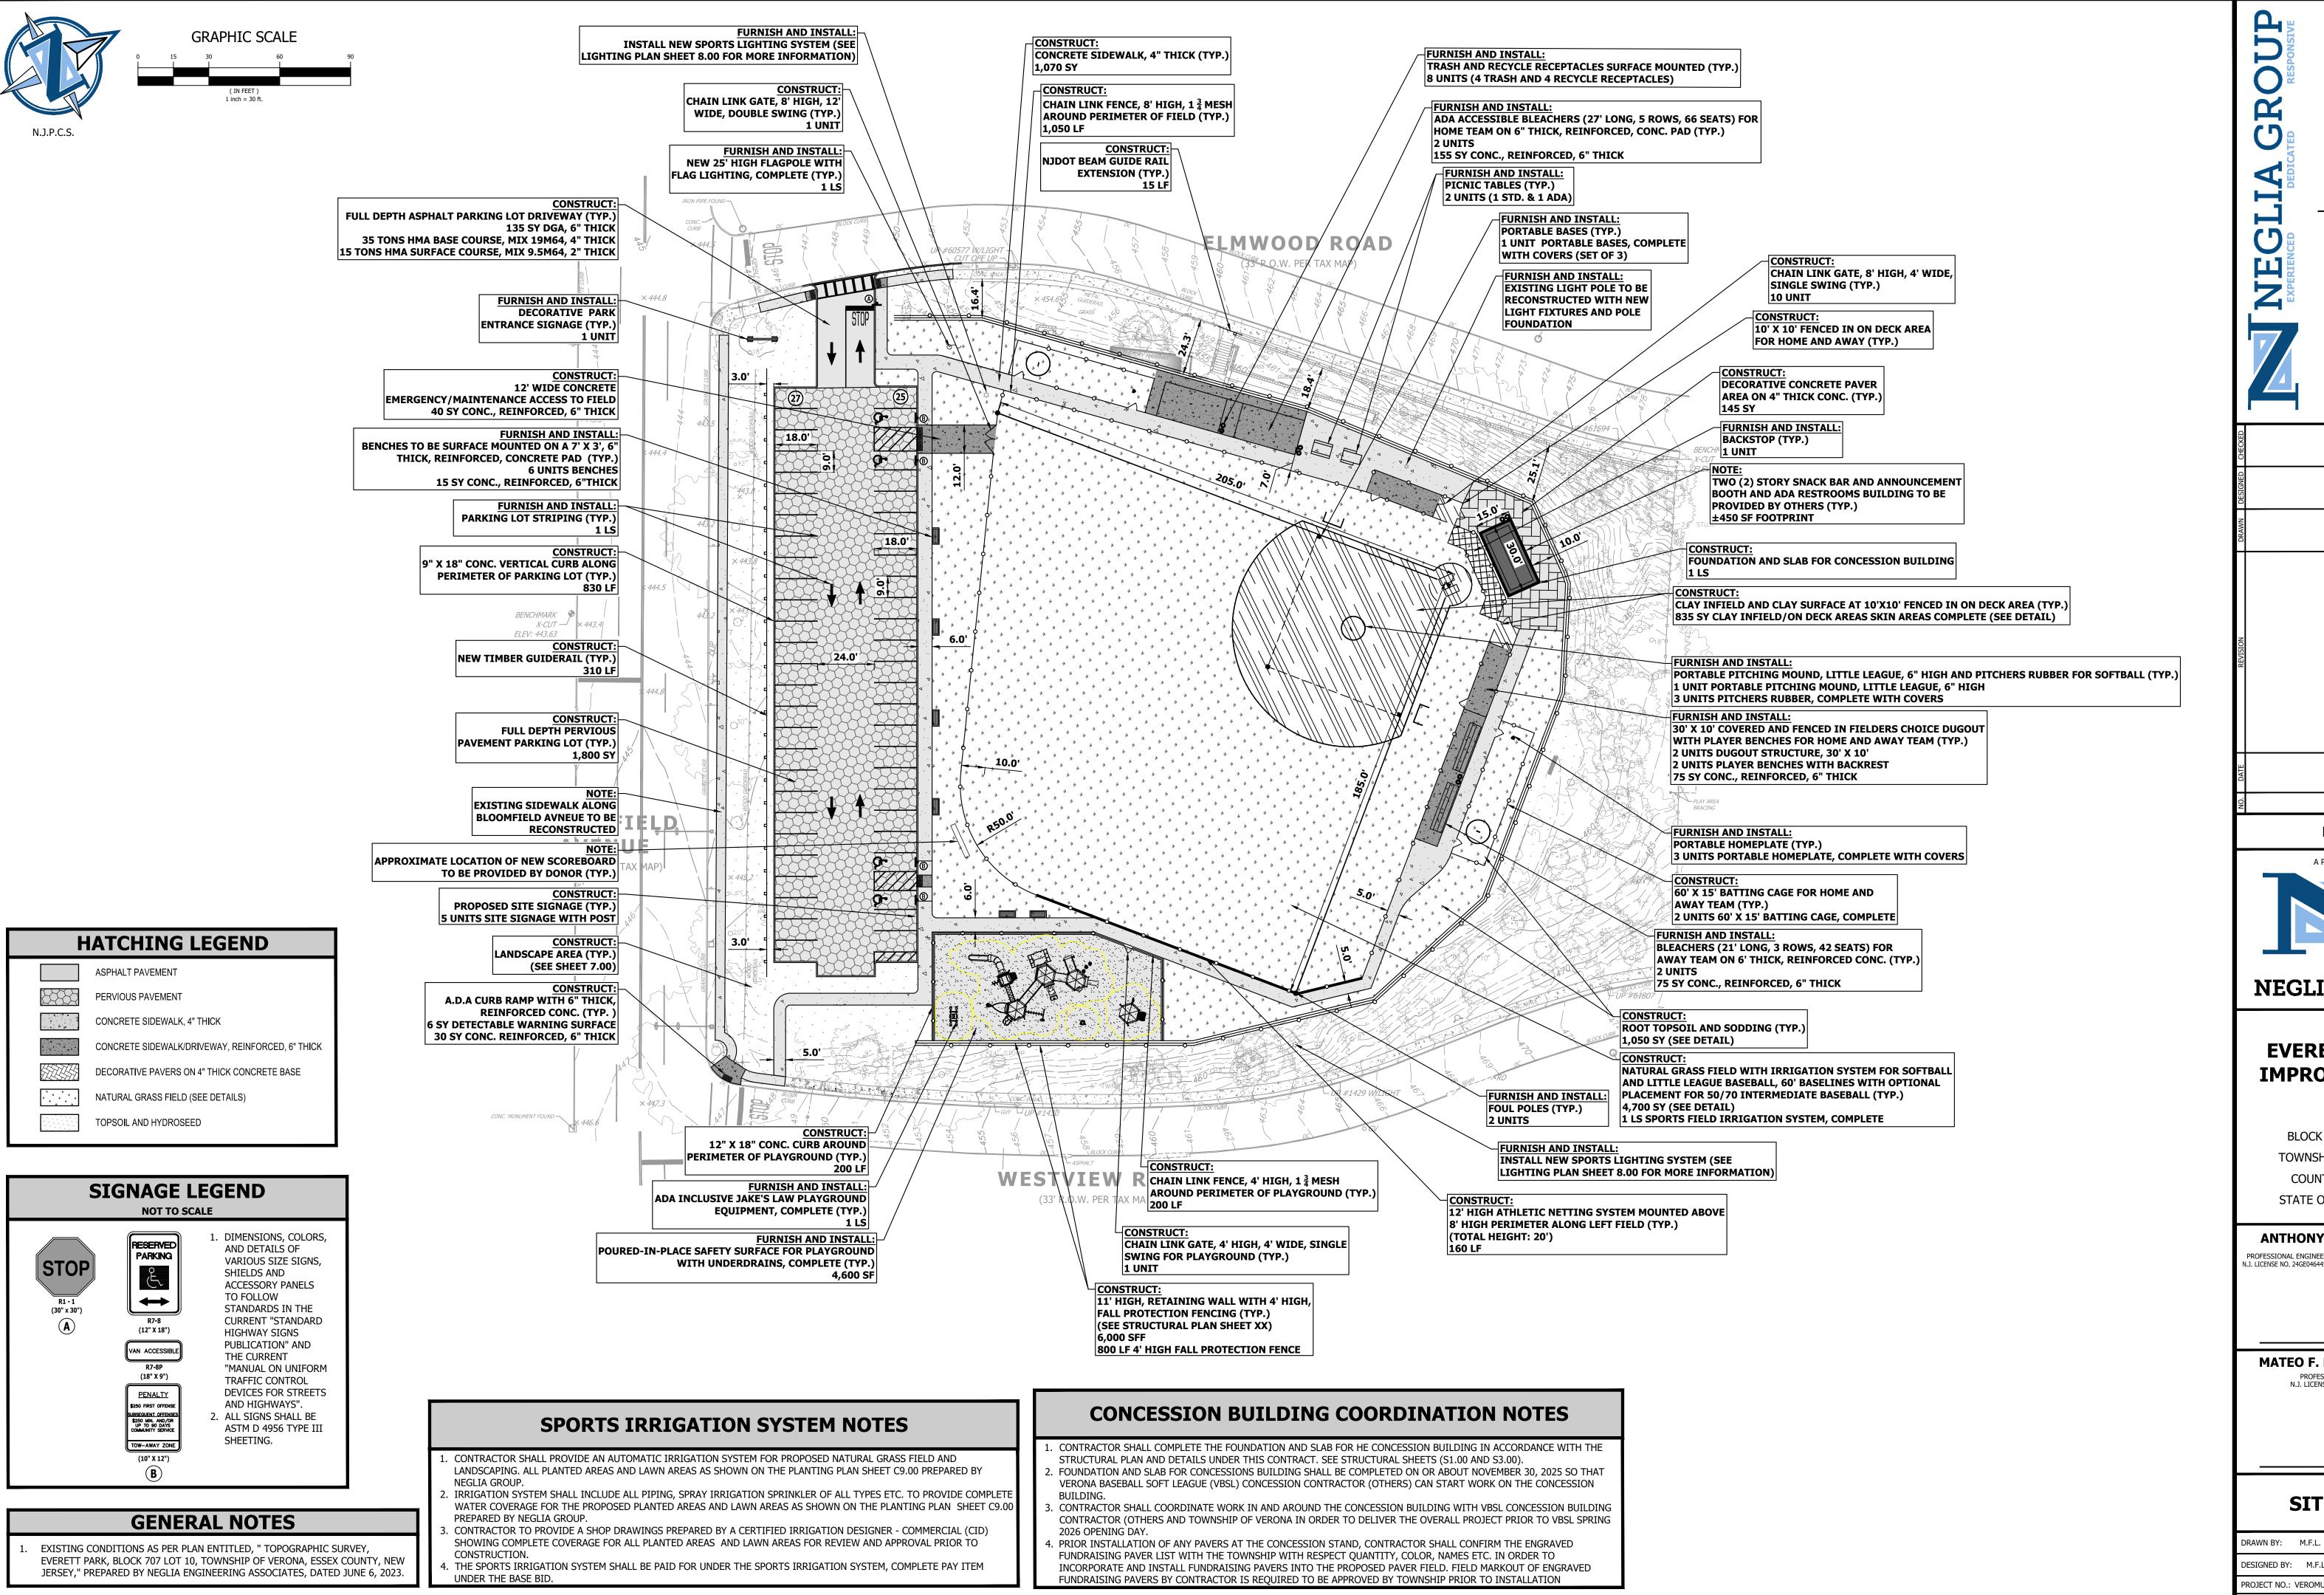

COUNTY AVE

LYNDHURS1

FINAL



NEGLIA GROUP

EVERETT PARK IMPROVEMENTS

BLOCK 707 - LOT 10 TOWNSHIP OF VERONA COUNTY OF ESSEX STATE OF NEW JERSEY


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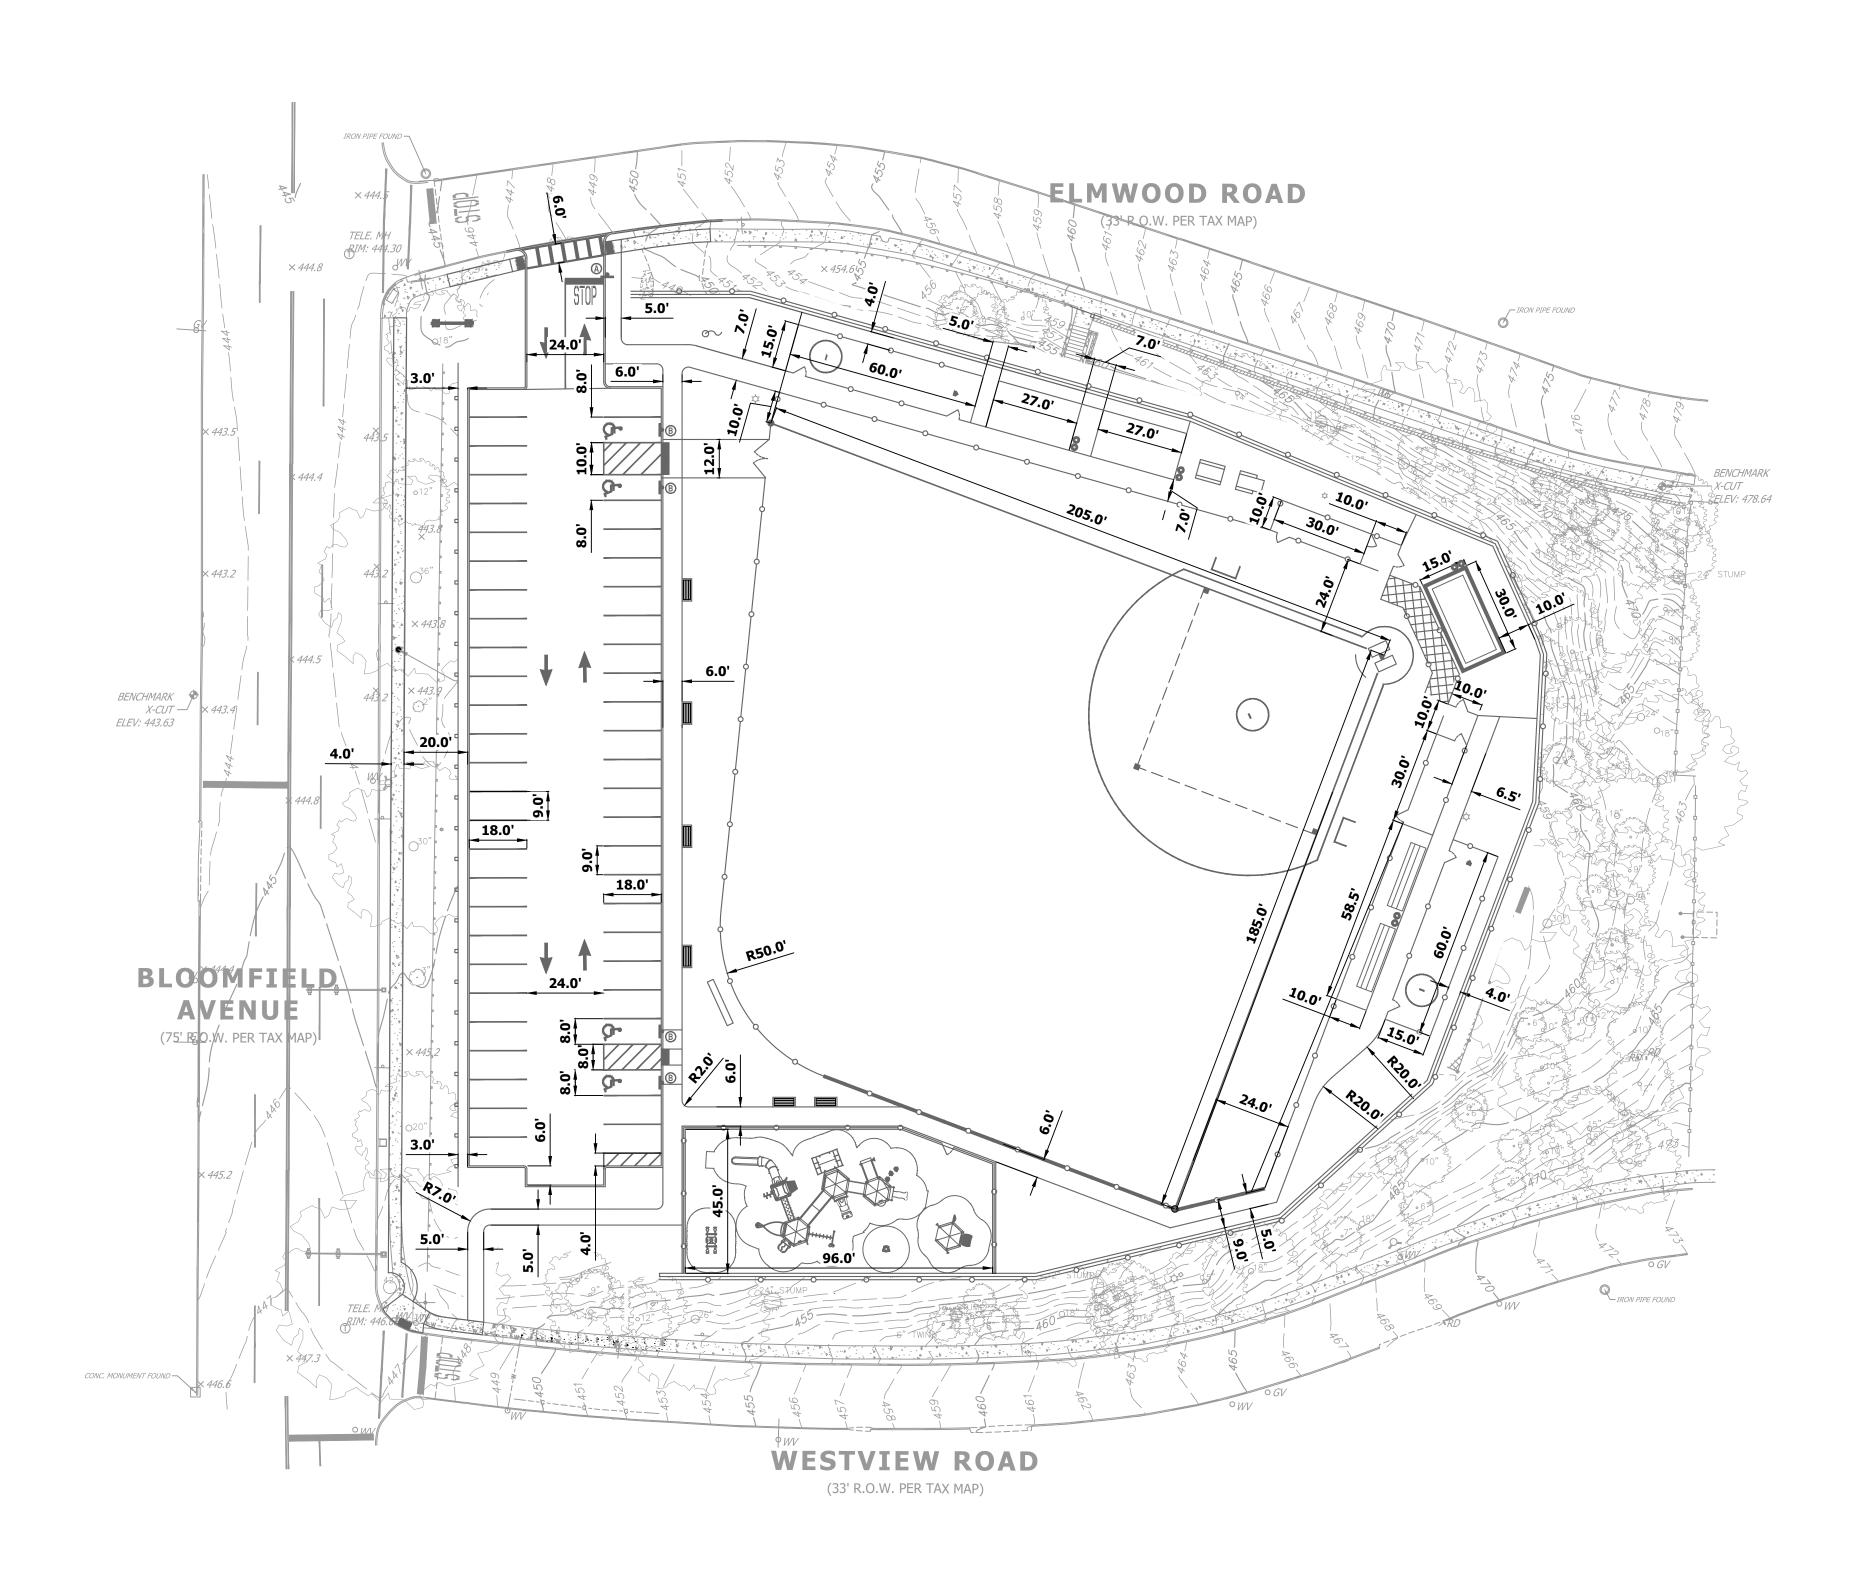
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PROFESSIONAL PLANNER
N.J. LICENSE NO. 33L10061450

MATEO F. LUZURIAGA, PE PROFESSIONAL ENGINEER N.J. LICENSE NO. 24GE06029800

SITE PLAN

SCALE: 1" = 30' CHECKED BY: A.K. DESIGNED BY: M.F.L. PROJECT NO.: VEROMUN24.010 DATE: NOVEMBER 2024



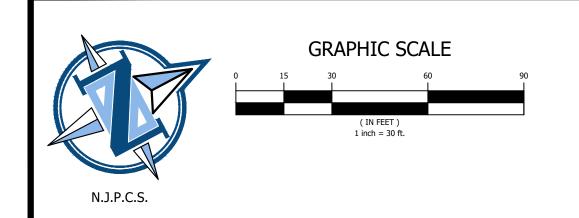

GENERAL NOTES

EXISTING CONDITIONS AS PER PLAN ENTITLED, "TOPOGRAPHIC SURVEY, EVERETT PARK, BLOCK 707 LOT 10, TOWNSHIP OF VERONA, ESSEX COUNTY, NEW JERSEY," PREPARED BY NEGLIA ENGINEERING ASSOCIATES, DATED JUNE 6, 2023.

LYNDHURST
34 PARK AVENUE, PO BOX 426

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NEGLIA GROUP

EVERETT PARK IMPROVEMENTS

BLOCK 707 - LOT 10 TOWNSHIP OF VERONA COUNTY OF ESSEX STATE OF NEW JERSEY

ANTHONY KURUS, PE, PP


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N.J. LICENSE NO. 24GE04644500 PROFESSIONAL PLANNER
N.J. LICENSE NO. 33LI00614500

MATEO F. LUZURIAGA, PE PROFESSIONAL ENGINEER N.J. LICENSE NO. 24GE06029800

DIMENSIONAL CONTROL PLAN

SCALE: 1" = 30' CHECKED BY: A.K. DESIGNED BY: M.F.L.

DRAWN BY: M.F.L.

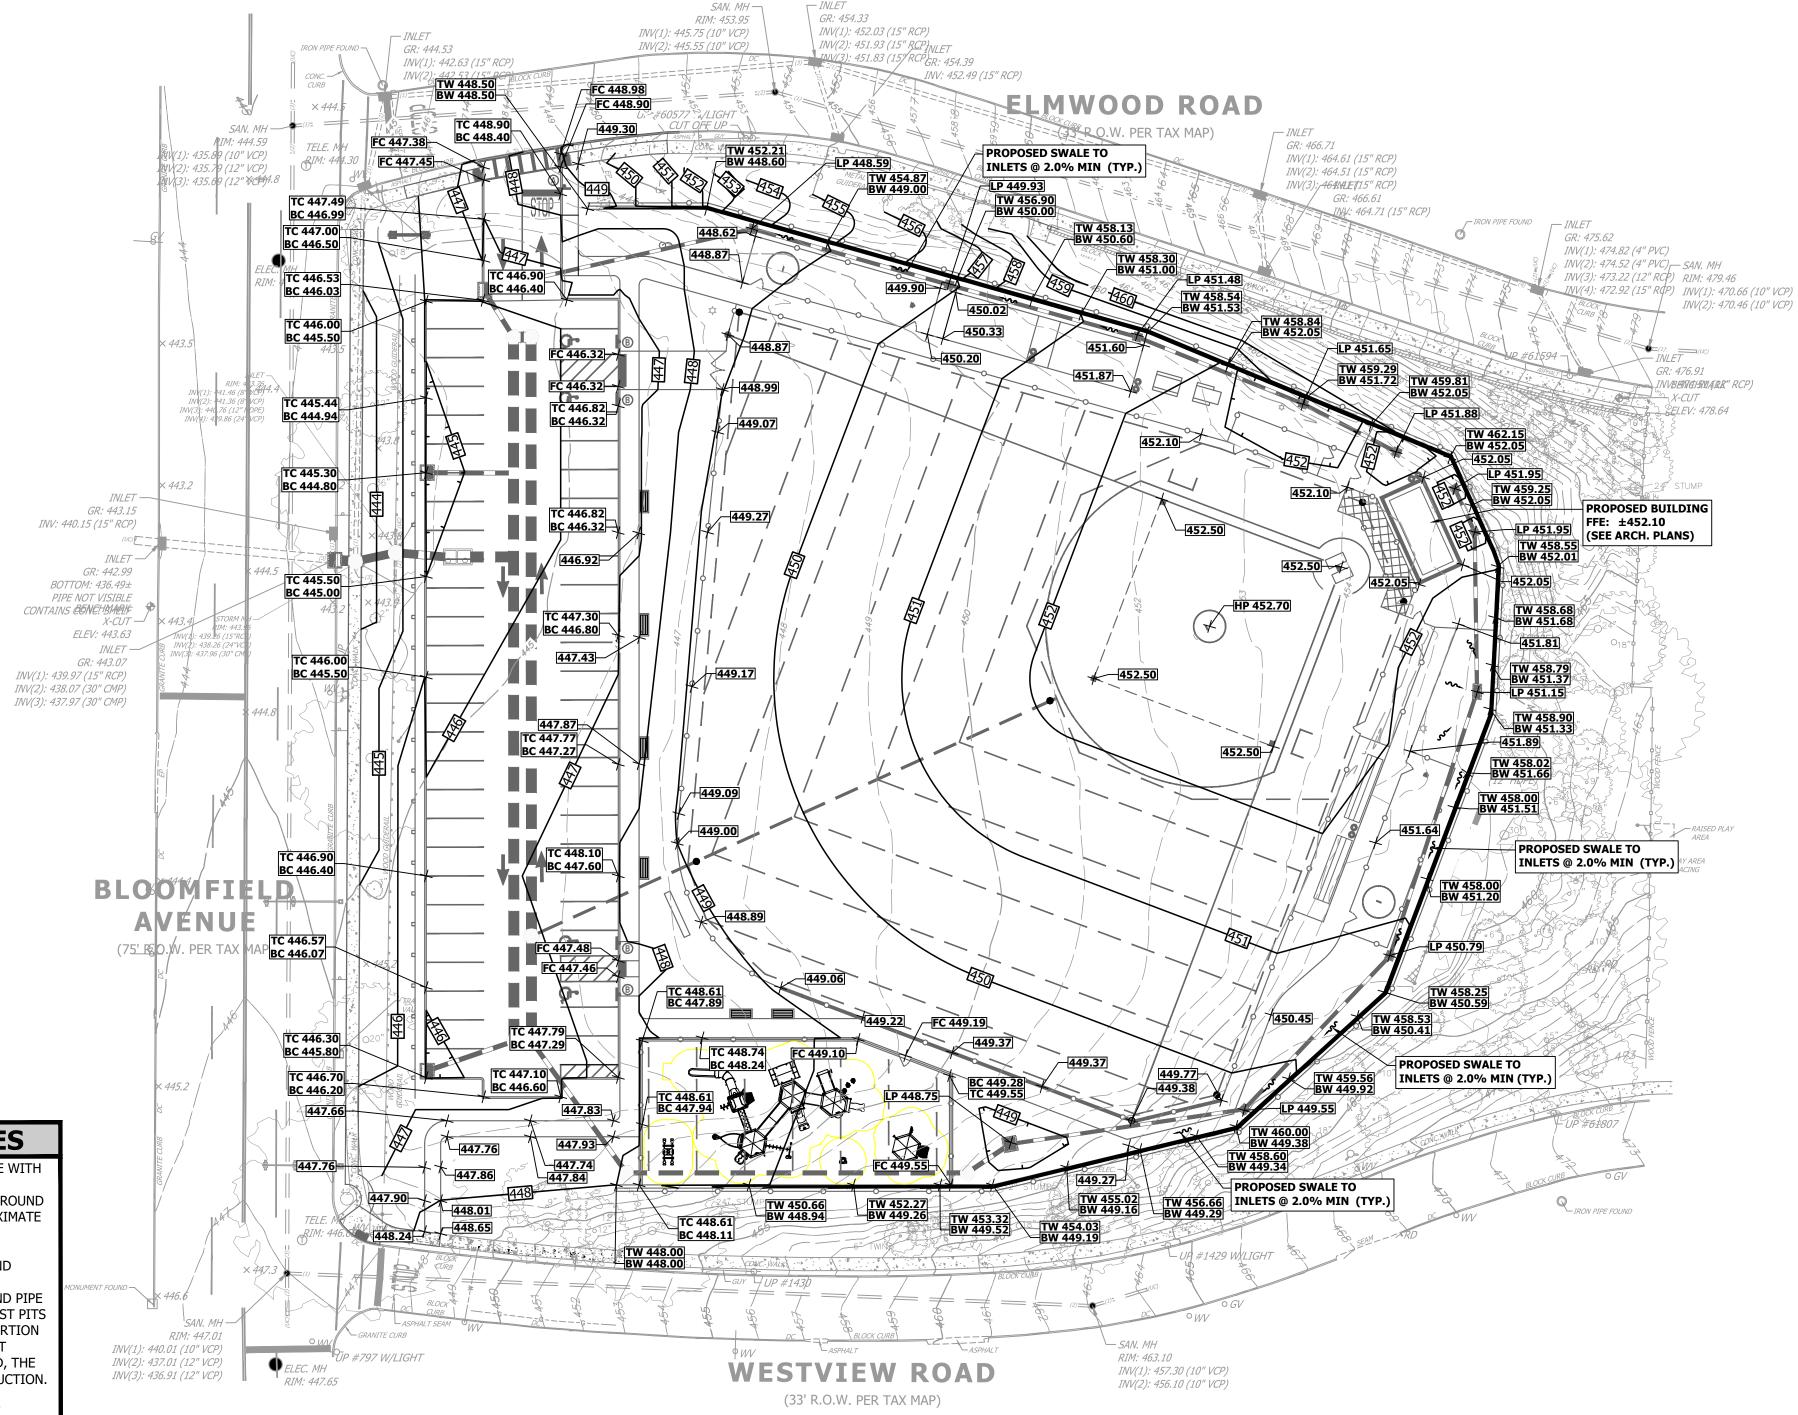

GRADING AND DRAINAGE NOTES

ALL SIDEWALKS AND CURBING MUST BE CONSTRUCTED IN ACCORDANCE WITH THE REQUIREMENTS OF THE AMERICANS WITH DISABILITIES ACT.
ALL ROOF DRAIN DOWNSPOUTS SHALL BE CONNECTED TO THE UNDERGROUND STORM DETENTION SYSTEM. LOCATIONS OF ROOF DRAINS ARE APPROXIMATE AT THIS TIME AND SHALL BE COORDINATED WITH ARCHITECTURAL DOWNSPOUT PLANS PRIOR TO CONSTRUCTION. ALL ROOF DRAINS, ALL DOWNSPOUTS, ALL CANOPY DRAINS SHALL BE PIPED UNDERGROUND AND

CONNECTED TO THE SITE DRAINAGE SYSTEM.

CONTRACTOR SHALL FIELD VERIFY/CONFIRM LOCATION, ELEVATION, AND PIPE SIZE OF EXISTING DOWNSTREAM STORM CONVEYANCE SYSTEMS VIA TEST PITS AT PROPOSED CONNECTION POINTS PRIOR TO CONSTRUCTING ANY PORTION OF THE SITE DRAINAGE SYSTEM AND PRIOR TO ORDERING ANY PRECAST DRAINAGE STRUCTURES. SHOULD ANY DISCREPANCIES BE DETERMINED, THE ENGINEER SHALL BE CONTACTED IMMEDIATELY PRIOR TO ANY CONSTRUCTION. CONTRACTOR SHALL CONFIRM THAT EXISTING DOWNSTREAM STORM CONVEYANCE SYSTEM IS FREE FLOWING PRIOR TO CONSTRUCTION ANY PORTION OF THE SITE DRAINAGE SYSTEM AND PRIOR TO ORDERING ANY

PRECAST DRAINAGE STRUCTURES.
GRADING AND DRAINAGE SHALL BE CONSTRUCTED SUCH THAT ALL RUNOFF SHALL BE DIRECTED TO PROPOSED CATCH BASINS, DRAINS, AND ADJACENT ROADWAY WITH POSITIVE PITCH.

GRADING ALONG BUILDINGS, FOUNDATIONS, AND STRUCTURE WALLS SHALL BE CONSTRUCTED TO PROVIDE 2% MINIMUM SLOPING AWAY FROM BUILDING, FOUNDATION, AND STRUCTURE WALLS TO PROVIDE POSITIVE DRAINAGE AWAY FROM SAID STRUCTURES TOWARDS PROPOSED CATCH BASINS, DRAINS, AND ADJACENT ROADWAY.

CROSS SLOPES WITHIN PROPOSED STREETSCAPE SIDEWALK SHALL NOT EXCEED 2.0% MAX CROSS SLOPE.
 SIDEWALK MUST BE A MINIMUM OF 4' WIDE AT A 1.8% MAXIMUM CROSS SLOPE

THRU THE PROPOSED DRIVEWAY.

SLOPES WITHIN ADA LANDINGS SHALL NOT EXCEED 1.8% SLOPE IN ANY DIRECTION. CONTRACTOR SHALL USE SMART LEVEL. SEE CONSTRUCTION

DETAILS.

GENERAL NOTES

EXISTING CONDITIONS AS PER PLAN ENTITLED, "TOPOGRAPHIC SURVEY, EVERETT PARK, BLOCK 707 LOT 10, TOWNSHIP OF VERONA, ESSEX COUNTY, NEW JERSEY," PREPARED BY NEGLIA ENGINEERING ASSOCIATES, DATED JUNE 6, 2023.

STEEP SLOPE DISTURBANCE CALCULATION

TOTAL AREA OF PROJECT SITE	125,888 S.F. (2.89 ACRES)	
NONREGULATED SLOPE (0%-14.9%)	89,618 S.F. (2.06 ACRES)	86.0% OF STEEP SLOPE DIST.
PRECAUTIONARY SLOPE (15% - 24.9%)	6,166 S.F. (0.14 ACRES)	5.9% OF STEEP SLOPE DIST.
PROHIBITIVE SLOPES (25% OR GREATER)	8,445 S.F. (0.19 ACRES)	6.7% OF STEEP SLOPE DIST.

LA GROUP

DEDICATED
RESPONSIVE

MOUNTAINSIDE
200 CENTRAL AVENUE, SUITE 102

NDHURST MOU

LYNDHURST
34 PARK AVENUE, PO BOX 426
LYNDHURST
NEW JERSEY 07071
PHONE: 201.939.8805
FAX: 201.939.0846

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EVERETT PARK IMPROVEMENTS

BLOCK 707 - LOT 10 TOWNSHIP OF VERONA COUNTY OF ESSEX STATE OF NEW JERSEY


ANTHONY KURUS, PE, PP
PROFESSIONAL ENGINEER | PROFESSIONAL PLANNE

PROFESSIONAL ENGINEER
N.J. LICENSE NO. 24GE04644500
PROFESSIONAL PLANNER
N.J. LICENSE NO. 33LI00614500

PROFESSIONAL ENGINEER
N.J. LICENSE NO. 24GE06029800

GRADING PLAN

DATE: NOVEMBER 2024	4	.00	
PROJECT NO.: VEROMUN24.	1	00	
DESIGNED BY: M.F.L.	CHECKED	BY:	A.K.
DRAWN BY: M.F.L.	SCALE:	4	as noted

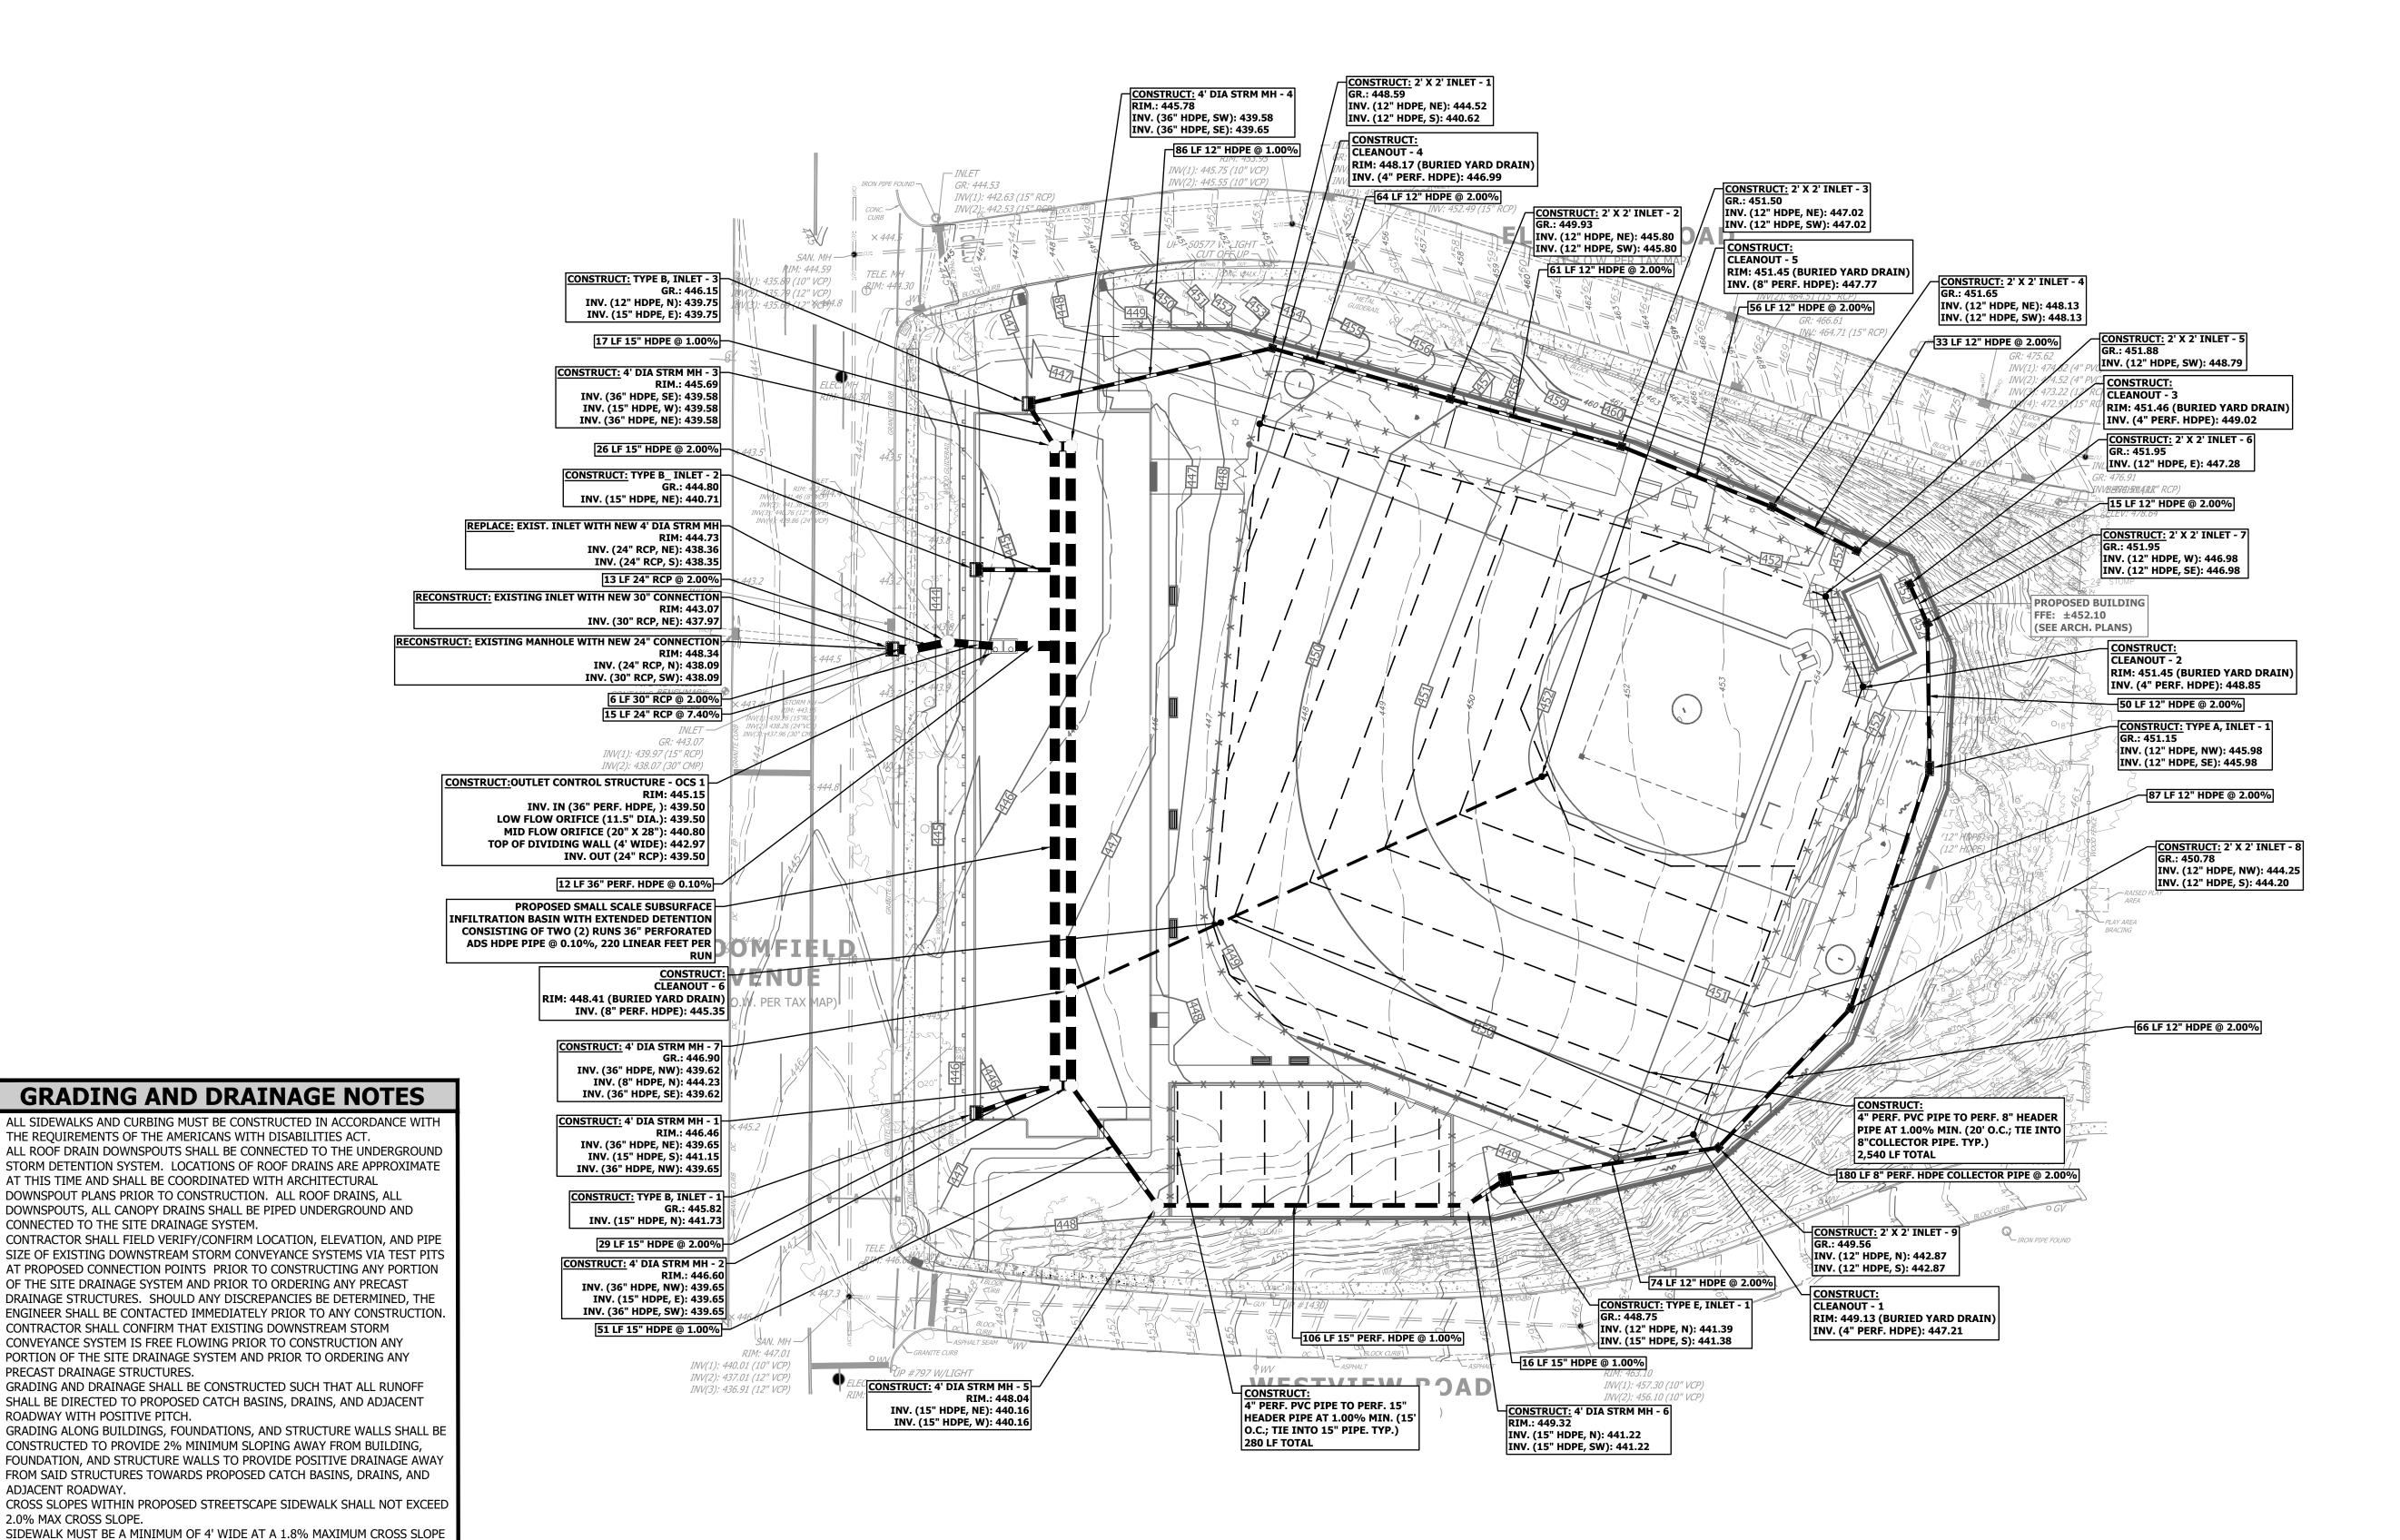

GENERAL NOTES

EXISTING CONDITIONS AS PER PLAN ENTITLED, "TOPOGRAPHIC SURVEY, EVERETT PARK, BLOCK 707 LOT 10, TOWNSHIP OF VERONA, ESSEX COUNTY, NEW JERSEY," PREPARED BY NEGLIA ENGINEERING ASSOCIATES, DATED JUNE 6, 2023.

SLOPES WITHIN ADA LANDINGS SHALL NOT EXCEED 1.8% SLOPE IN ANY DIRECTION. CONTRACTOR SHALL USE SMART LEVEL. SEE CONSTRUCTION

CONNECTED TO THE SITE DRAINAGE SYSTEM.

PRECAST DRAINAGE STRUCTURES.

ROADWAY WITH POSITIVE PITCH.

THRU THE PROPOSED DRIVEWAY.

ADJACENT ROADWAY.


DETAILS.

2.0% MAX CROSS SLOPE.

'AINSIDI

COUNTY AVE

LYNDHURST 34 PARK AVENIJE PO ROY 476

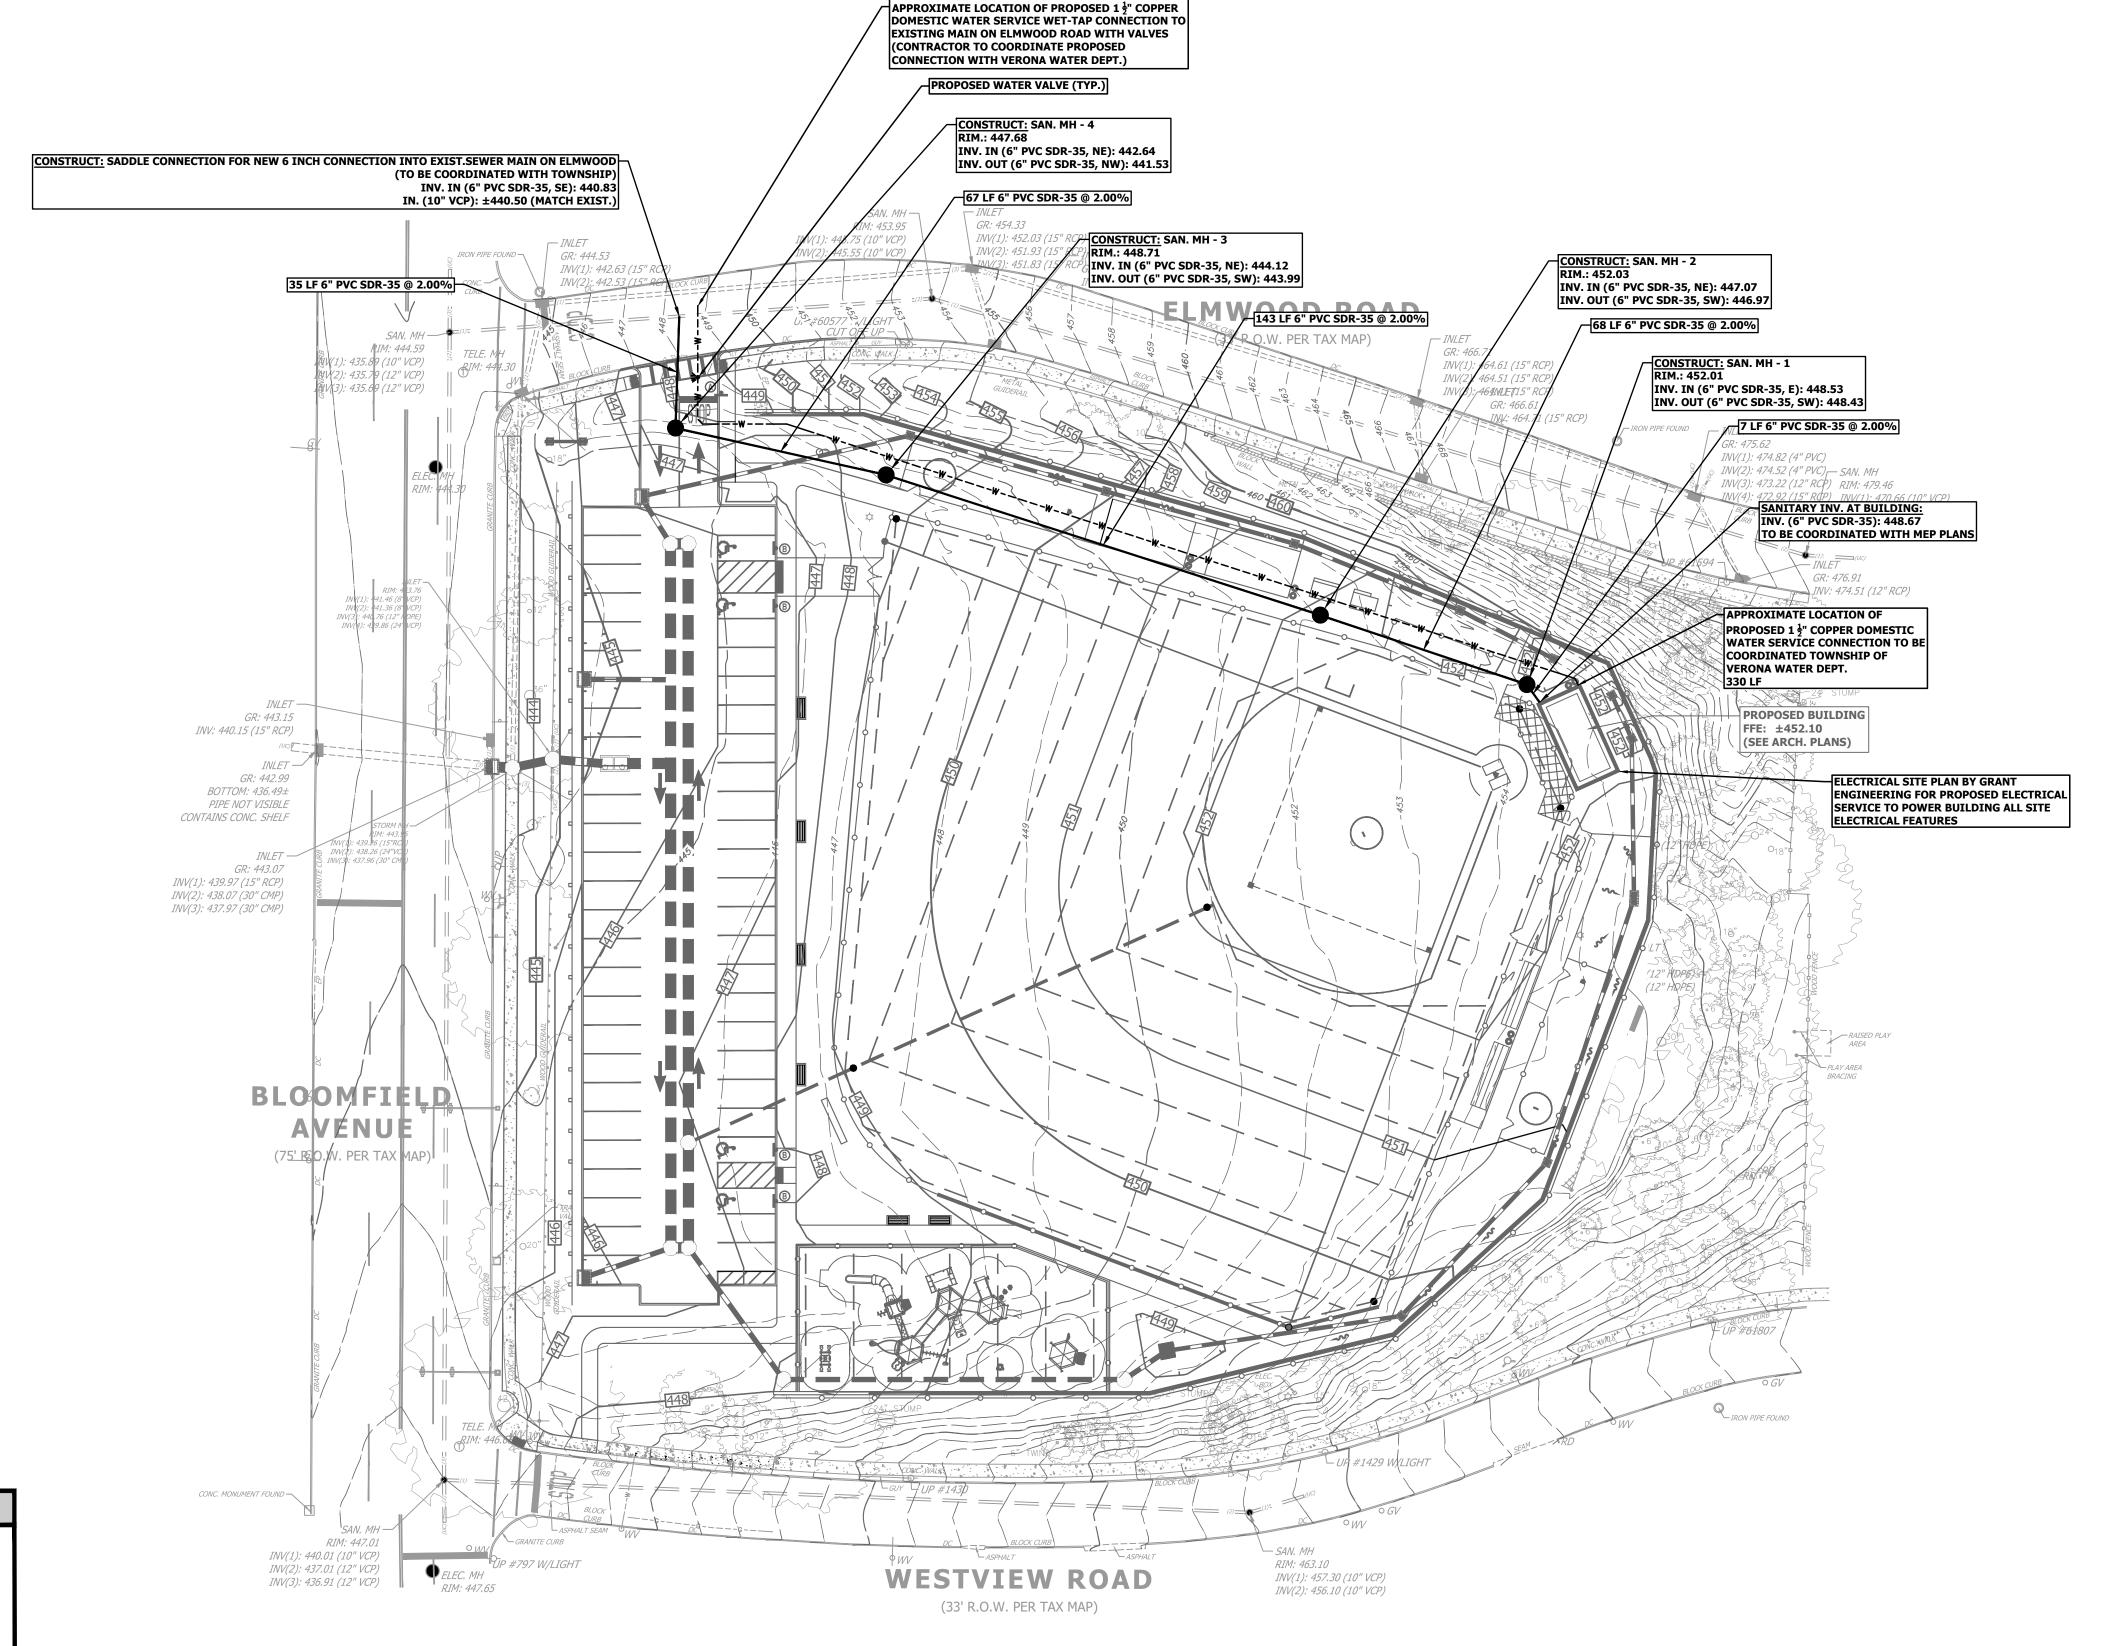

UTILITY NOTES

UTILITY CONNECTIONS AT PROPOSED BUILDING TO BE COORDINATED WITH MEP DESIGN BY OTHERS AND GOVERNING UTILITY AUTHORITIES.
CONTRACTOR SHALL FIELD LOCATE EXISTING UTILITIES AT ALL UTILITY CROSSINGS VIA TEST PITS PRIOR TO CONSTRUCTION AND SHALL COORDINATE ANY REQUIRED RELOCATIONS WITH GOVERNING UTILITY AUTHORITIES.
EXISTING UTILITY LINES ON SITE THAT ARE NO LONGER IN SERVICE SHALL BE PROPERLY REMOVED AND CAPPED PER UTILITY AUTHORITY REQUIREMENTS. CONTRACTOR SHALL COORDINATE RECONSTRUCTION/RELOCATION OF ANY UTILITIES NECESSARY FOR THE CONSTRUCTION OF PROJECT AS SHOWN ON THE SITE PLAN DRAWINGS WITH GOVERNING UTILITY AUTHORITIES
CONTRACTOR SHALL TELEVISE EXISTING SANITARY SEWER DOWNSTREAM OF PROPOSED CONNECTION AND PROVIDE COPIES OF THE VIDEO TO THE TOWNSHIP AND THIS OFFICE PRIOR TO CONNECTION.
CONTRACTOR SHALL ENSURE DOWNSTREAM SEWER IS FREE FLOWING PRIOR TO

GENERAL NOTES

10" SANITARY SEWER LOCATED ON ELMWOOD ROAD SHALL BE VIDEO INSPECTED WITH COPIES OF THE VIDEO PROVIDED TO THE TOWNSHIP OF

CONSTRUCTING PROPOSED SEWER CONNECTION.

VERONA AND THIS OFFICE PRIOR TO CONSTRUCTION.

 EXISTING CONDITIONS AS PER PLAN ENTITLED, "TOPOGRAPHIC SURVEY, EVERETT PARK, BLOCK 707 LOT 10, TOWNSHIP OF VERONA, ESSEX COUNTY, NEW JERSEY," PREPARED BY NEGLIA ENGINEERING ASSOCIATES, DATED JUNE 6, 2023. MOUNTAINSIDE
MOUNTAINSIDE

LYNDHURST
34 PARK AVENUE, PO BOX 426
LYNDHURST
NEW JERSEY 07071

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EVERETT PARK IMPROVEMENTS

BLOCK 707 - LOT 10 TOWNSHIP OF VERONA COUNTY OF ESSEX STATE OF NEW JERSEY


ANTHONY KURUS, PE, PP
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PROFESSIONAL PLANNER
N.J. LICENSE NO. 33LI00614500

PROFESSIONAL ENGINEER
N.J. LICENSE NO. 24GE06029800

UTILITY PLAN

	DATE: NOVEMB	ER 2024		O	.00
	PROJECT NO.: \	6	00		
	DESIGNED BY:	M.F.L.	CHECKED	BY:	A.K.
I	DRAWN BY:	M.F.L.	SCALE:		AS NOTED

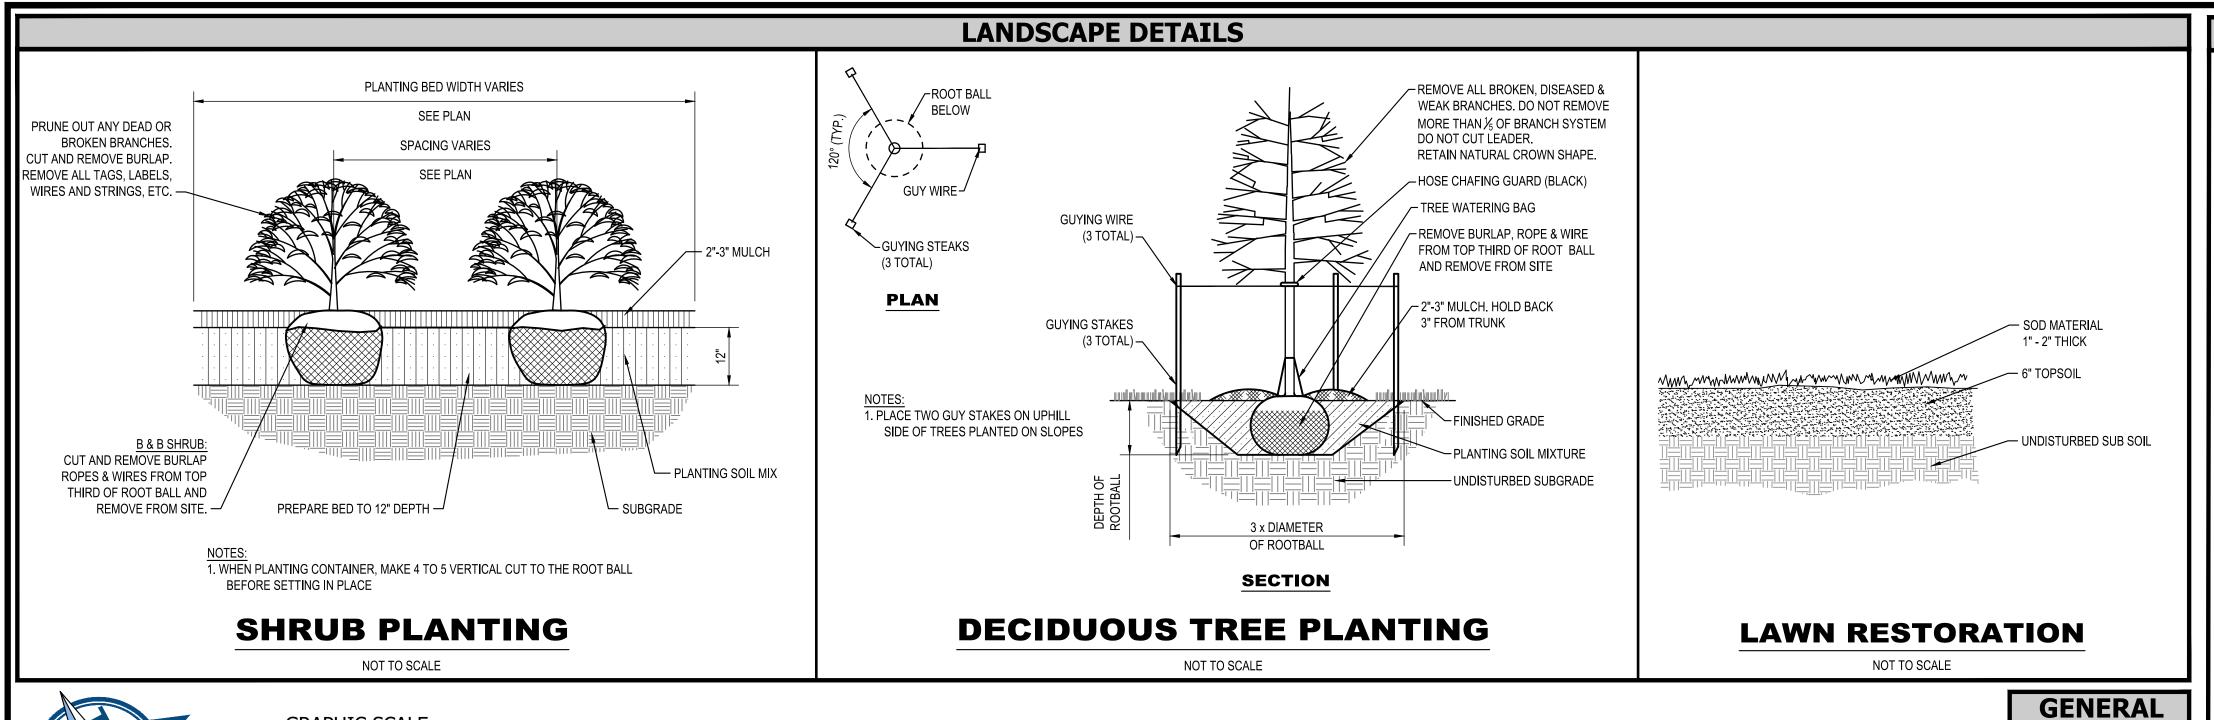

ELMWOOD ROAD T-LT R.O.W. PER TAX MAP) G-CV T-LT BLOOMFI#LD (75' R) O.W. PER TAX MAP

WESTVIEW ROAD

(33' R.O.W. PER TAX MAP)

LANDSCAPE NOTES

. THIS PLAN SHALL BE USED FOR LANDSCAPE PLANTING PURPOSES ONLY. EXAMINE ALL ENGINEERING DRAWINGS AND FIELD CONDITIONS FOR SPECIFIC LOCATIONS OF UTILITIES, STRUCTURES, ETC. AND NOTIFY THE PROJECT PROFESSIONAL IN REFERENCE TO ANY DISCREPANCIES OR LOCATION CONFLICTS PRIOR TO PLANTING INSTALLATION.

- ALL PLANT MATERIAL SHALL CONFORM TO THE AMERICAN STANDARD FOR NURSERY STOCK, ANSI Z60.1 CURRENT EDITION.
 THE PLANT MATERIAL SHALL BE TRUE TO SPECIES, VARIETY, SIZE AND BE CERTIFIED DISEASE AND INSECT FREE. THE
 PROJECT PROFESSIONAL RESERVES THE RIGHT TO REJECT PLANT MATERIAL WHEN DELIVERED TO THE SITE AND UP TO THE
 TIME OF FINAL ACCEPTANCE.
- 3. NO PLANT SUBSTITUTIONS SHALL BE PERMITTED WITH REGARDS TO SIZE, SPECIES VARIETY, ETC. WITHOUT WRITTEN

PERMISSION OF THE PROJECT PROFESSIONAL. WRITTEN PROOF OF PLANT MATERIAL UNAVAILABILITY MUST BE PROVIDED.

- LOCATION AND SPACING FOR PROPOSED VEGETATION IS AS SHOWN ON LANDSCAPE PLANS. FINAL ADJUSTMENTS TO BE
- THE PLANTING PLAN SHALL TAKE PRECEDENCE OVER THE PLANT SCHEDULE SHOULD ANY PLANT QUANTITY DISCREPANCIES
- ALL PLANT MATERIAL SHALL BE PLANTED IN CONFORMANCE WITH THE TYPICAL PLANTING DETAILS AND ACCEPTED HORTICULTURAL PRACTICES. INSTALL ALL PLANT MATERIAL ON UNDISTURBED GRADE. CUT AND REMOVE BURLAP FROM THE TOP ONE-THIRD OF THE ROOT BALL. NO SYNTHETIC MATERIAL IS TO REMAIN IN PLANTING HOLE. SEE DETAIL SHEET FOR PLANTING DETAILS.
- PROJECT PROFESSIONAL SHALL HAVE FINAL ACCEPTANCE OF ALL PLANT MATERIAL.
- PLANT ROOT FLAIR SHALL BE EXPOSED AT TIME OF PLANTING. PLANTS SHALL BE INSTALLED AT SAME GRADE AS GROWN IN
- NEWLY INSTALLED PLANT MATERIAL SHALL BE THOROUGHLY WATERED AT THE TIME OF INSTALLATION BY THE LANDSCAPE CONTRACTOR. LANDSCAPE CONTRACTOR IS RESPONSIBLE FOR THE REGULAR WATERING OF PLANT MATERIAL UNTIL IRRIGATION SYSTEM HAS BEEN INSTALLED AND OPERATING NORMALLY.
- 10. ALL PLANT MATERIAL SHALL BE GUARANTEED BY THE CONTRACTOR FOR TWO (2) YEAR AFTER THE DATE OF FINAL ACCEPTANCE.
- ALL DISTURBED AREAS SHALL RECEIVE TEMPORARY AND PERMANENT STABILIZATION DEPENDING UPON STAGE OF WORK AND TIME OF YEAR (REFER TO N.J. SOIL EROSION AND SEDIMENT CONTROL REGULATIONS).
- 12. WIRE BASKETS ARE TO BE CUT AND FOLDED TO BOTTOM OF PLANTING HOLE AWAY FROM SIDES OF ROOT BALL.
- 13. PROVIDE SUSTAINED RELEASE 5-10-5 FERTILIZER FOR ALL PLANT MATERIAL IN QUANTITIES AS PER MANUFACTURES RECOMMENDATIONS. THOROUGHLY MIX IN TOP 12" OF ALL PLANTING AREAS.
- 4. ALL PLANTS ARE SHOWN SEMI-MATURE SIZE ON PLANS. SIZES INDICATED IN PLANT LIST ARE SIZES AT TIME OF INSTALLATION.
- 15. PLANTING PITS ARE TO BE 3X ROOT BALL DIAMETER.

NOTES

CONDITIONS AS PER

PLAN ENTITLED, "
TOPOGRAPHIC

SURVEY, EVERETT

10, TOWNSHIP OF

JERSEY," PREPARED

ASSOCIATES, DATED

VERONA, ESSEX

COUNTY, NEW

ENGINEERING

JUNE 6, 2023.

BY NEGLIA

PARK, BLOCK 707 LOT

EXISTING

- 16. TREES TO BE HANDLED BY ROOT BALL ONLY. HANDLING OF TREES BY THE TRUNK OR THE PLACING OF STRAPS AROUND THE TRUNK WILL BE CAUSE FOR IMMEDIATE REJECTION OF PLANT MATERIAL.
- 17. TREES ARE TO BE LABELED WITH PERMANENT TAG. LABEL TO INCLUDE BOTANICAL NAME AND DATE OF INSTALLATION.
- 18. ALL DISTURBED AREAS TO BE RESTORED TO THE SATISFACTION OF THE PROJECT PROFESSIONAL.
- 19. TREES TO BE INSTALLED WITH SAME ORIENTATION AS AT PLACE GROWN. NORTH SIDE OF TREE TO BE IDENTIFIED PRIOR TO DIGGING.
- 20. CONTRACTOR IS RESPONSIBLE FOR THE INITIAL PRUNING OF TREES. PRUNING TO BE LIMITED TO CROSSOVER LIMBS, CO-DOMINANT LEADERS, AND BROKEN OR DEAD BRANCHES. SOME INTERIOR TWIGS AND LATERAL BRANCHES MAY BE PRUNED; HOWEVER, DO NOT REMOVE THE TERMINAL BUDS OF BRANCHES THAT EXTEND TO THE EDGE OF THE CROWN.
- 21. CONTRACTOR IS RESPONSIBLE FOR THE REMOVAL OF TREE STAKES 1 YEAR FROM THE DATE OF FINAL ACCEPTANCE.
- 22. CONTRACTOR TO PROVIDE WATERING BAGS FOR ALL PROPOSED SHADE TREES

			PLANTI	NG SCHEDULE		
SYMBOL	KEY	QUANTITY	BOTANICAL NAME	COMMON NAME	SIZE	NOTES
TREES			1			
The way had	T-AR	8	ACER RUBRUM 'OCTOBER GLORY'	OCTOBER GLORY RED MAPLE	3"-3 ½" cal.	Shade tree. B & B
+	T-FG	5	FAGUS GRANDIFOLIA	AMERICAN BEECH	3"-3 ½" cal.	Shade tree. B & B
	T-LT	10	LIRIODENDRON TULIPFERA	TULIPTREE	3"-3 ½" cal.	Shade tree. B & B
	T-NS	4	NYSSA SYLVATICA	BLACK GUM	3"-3 ½" cal.	Shade tree. B & B
(°)	T-QB	4	QUERCUS BICOLOR	SWAMP WHITE OAK	2 ½"-3" cal.	Columnar shade tree. B & B
\bigcirc	T-QP	7	QUERCUS PHELLOS	WILLOW OAK	3"-3 ½" cal.	Shade tree. B & B
PRNAMENTAL TRI	EES					
+	O-CF	6	CORNUS FLORIDA	WHITE DOGWOOD	7'-8' height	Fragrant white flowers in spring. B & B
	o-ov	12	OSTRYA VIRGINIANA	HOPHORNBEAM	7'-8' height	Fragrant white flowers in spring. B & B
SHRUBS						
	S-CA	3	CEANOTHUS AMERICANUS	NEW JERSEY TEA	3 gallon	18-24" ht. at time of planting
The state of the s	S-JC	13	JUNIPERUS CONFERTA	SHORE JUNIPER	3 gallon	Low growing evergreen, 10-12" ht. at time of planting
GRASSES	,					
	G-CV	11	CAREX VULPINOIDEA	FOX SEDGE	3 gallon	Ornamental grass, 18" - 24" ht. at time of planting

MOUNTAINSIDE

MOUNTAINSIDE


LYNDHURST

NEW JERSEY 07071

PHONE: 201.939.8805

34 PARK AVE
LYN
NEW JE
PHONE: 3

FINAL

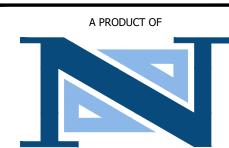

NEGLIA GROUP

EVERETT PARK IMPROVEMENTS

BLOCK 707 - LOT 10 TOWNSHIP OF VERONA COUNTY OF ESSEX STATE OF NEW JERSEY

ANTHONY KURUS, PE, PP


PROFESSIONAL ENGINEER
N.J. LICENSE NO. 24GE04644500
PROFESSIONAL PLANNER
N.J. LICENSE NO. 33L10061450

MATEO F. LUZURIAGA, PE

PROFESSIONAL ENGINEER
N.J. LICENSE NO. 24GE06029800


LANDSCAPE PLAN

	DATE: NOVEMB		.00		
	PROJECT NO.: \	7			
	DESIGNED BY:	M.F.L.	CHECKED	BY:	A.K.
•	DRAWN BY:	M.F.L.	SCALE:		AS NOTED

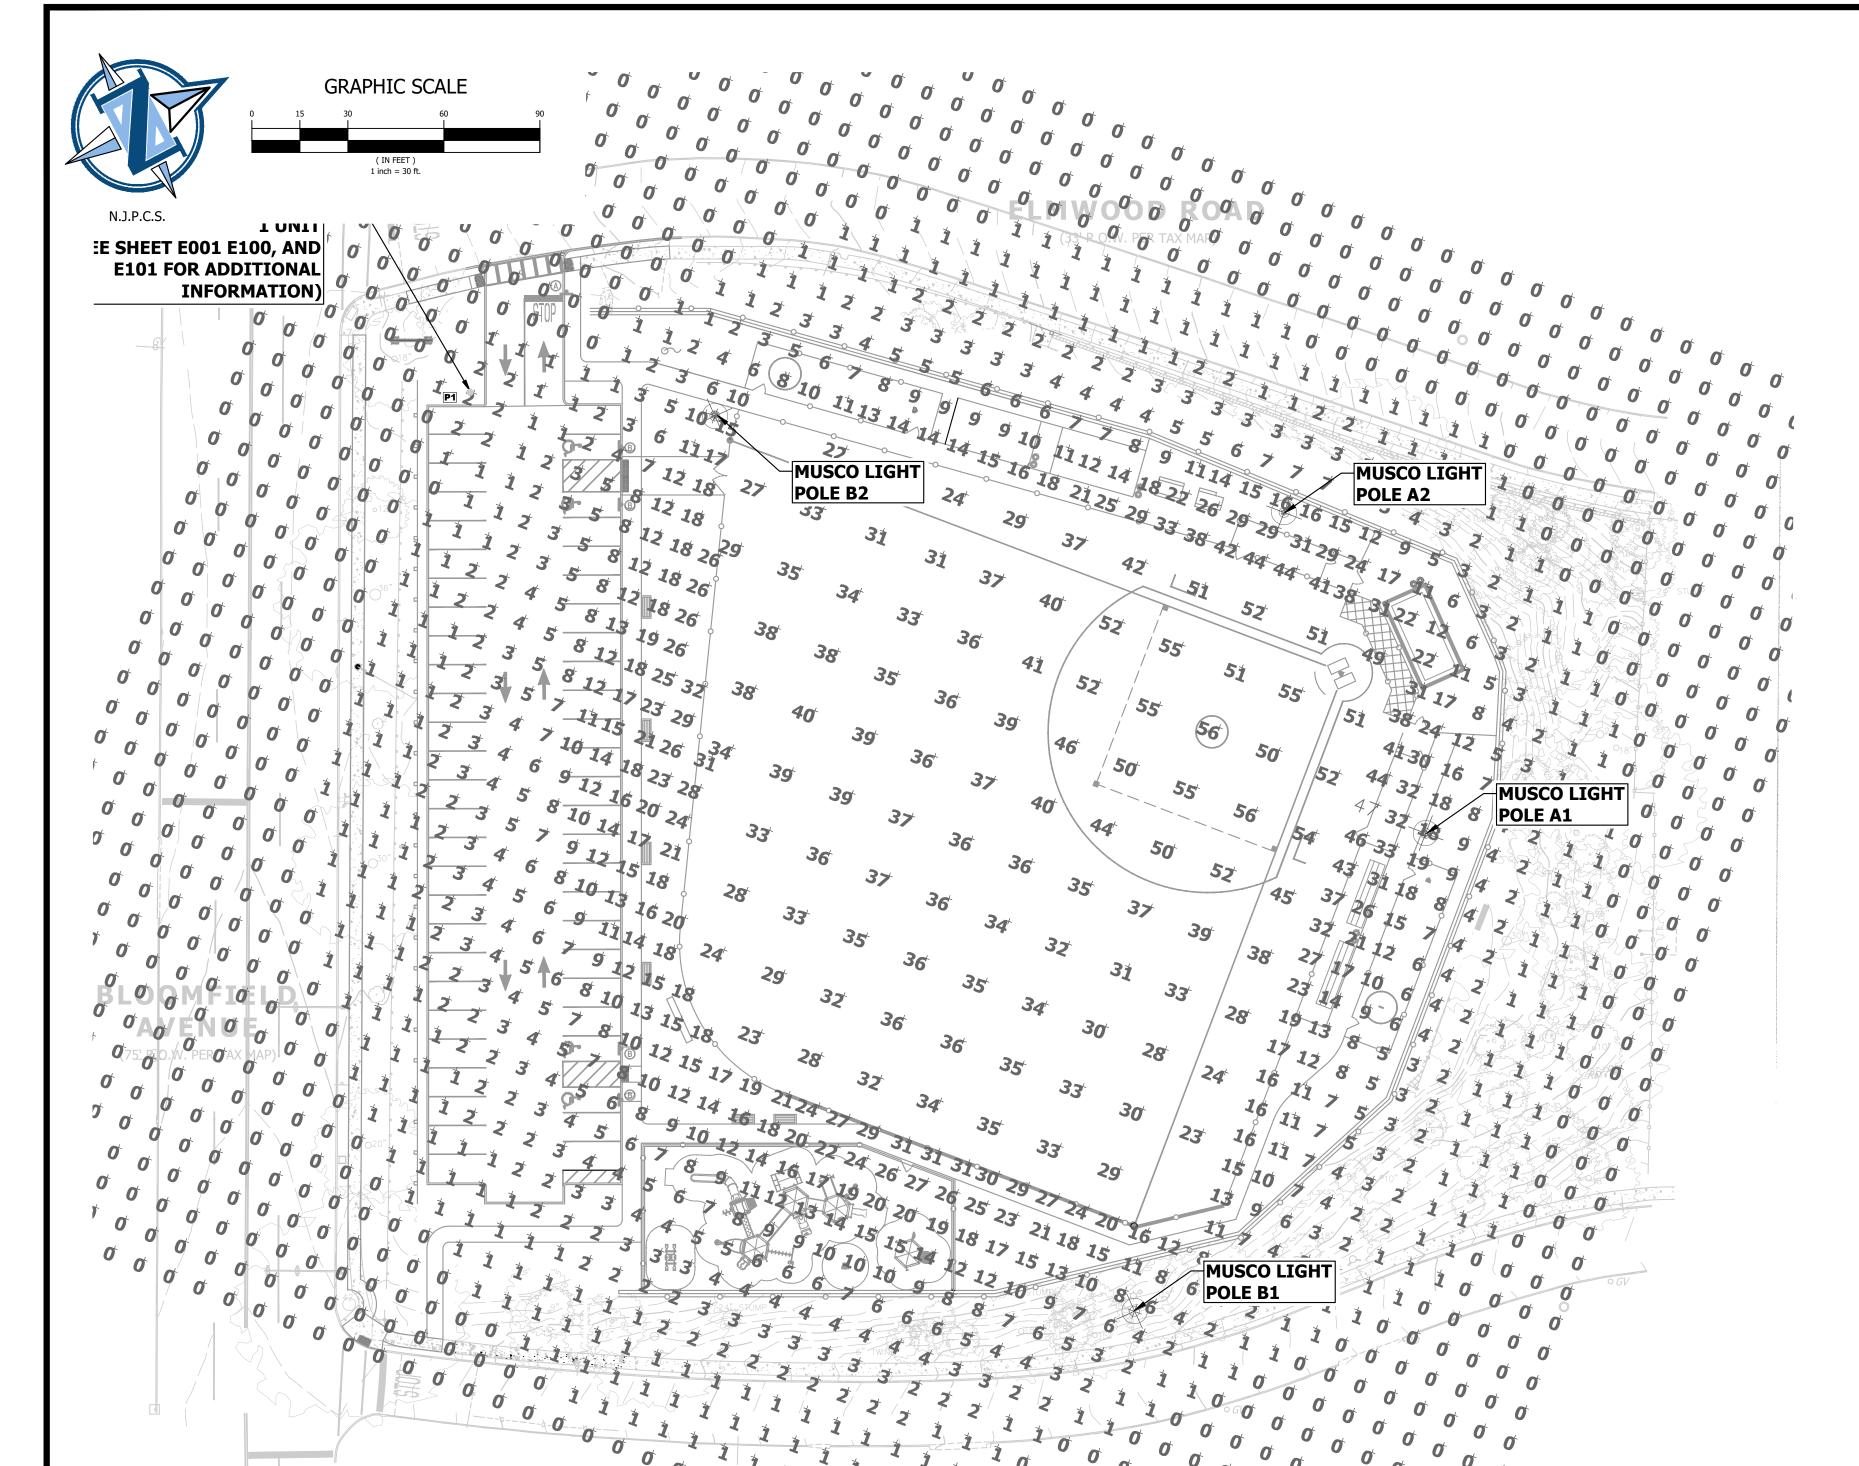

Equi	Equipment List For Areas Shown												
	Pole	1			Luminaires								
QTY	LOCATION	SIZE	GRADE ELEVATION	ABOVE GRADE LEVEL	LUMINAIRE TYPE	QTY/POLE	THIS GRID	OTHER GRIDS					
2	A1-A2	60'	-	60'	TLC-LED-900	3	3	0					
				15.5'	TLC-BT-575	1	1	0					
1	B1	80'	5'	85'	TLC-LED-1200	5	5	0					
				20.5'	TLC-BT-575	1	1	0					
1	B2	80'	-	80'	TLC-LED-1200	5	5	0					
				15.5'	TLC-BT-575	1	1	0					
4				Totals		20	20	0					

*Above Grade level relative to the field

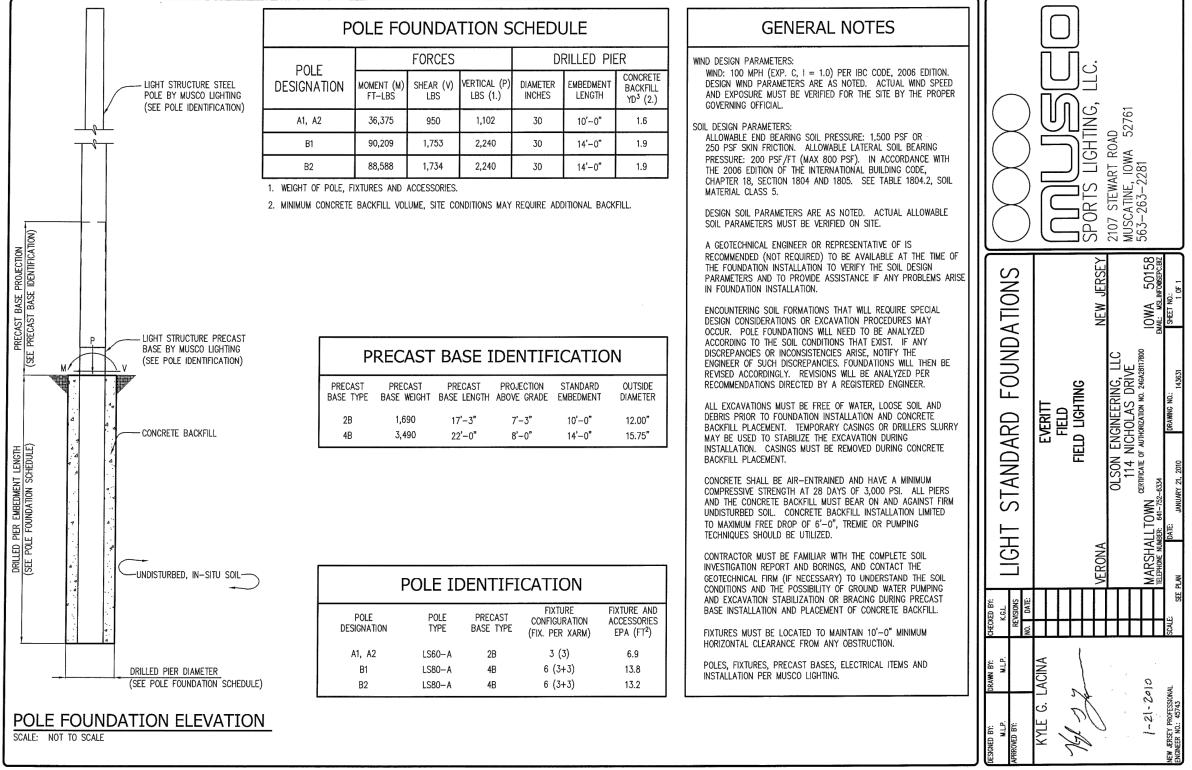

FIELD LIGHTING POLE FOUNDATIONS

NOT TO SCALE

CONTRACTOR TO CONSTRUCT NEW POLE FOUNDATIONS FOR A1 AND A2.

- CONTRACTOR SHALL CONSTRUCT POLE FOUNDATION IN ACCORDANCE WITH
- MUSCO LIGHT STANDARD POLE FOUNDATION.
- 3. THE COST FOR ALL WORK, LABOR, EQUIPMENT, ETC. FOR THE COMPLETE CONSTRUCTION OF THE MUSCO POLE FOUNDATION SHALL BE INCLUDED IN THE ITEM: SPORTS LIGHTING LIGHT STRUCTURE RETROFIT COMPLETE SYSTEM UPGRADE.

Musco Light Fixture Type Summary L90 L80 L70 Source Wattage Quantity Lumens TLC-BT-575 LED 5700K - 75 CRI 575W 52,000 >120,000 >120,000 >120,000 1170W TLC-LED-1200 LED 5700K - 75 CRI 150,000 >120,000 >120,000 >120,000 10 TLC-LED-900 >120,000 LED 5700K - 75 CRI 880W 104,000 >120,000 >120,000

GRP LUMINAIRE SCHEDULE

0 Plotte	Qty	Туре	Arrangement	Symbol	Manufacturer	Light Fixture Spec	ССТ	Lum. Lumens	LLF	Lum. Watts	Arr. Watts	Pole/Bracket Spec	Mounting AFG (FT)
out: 8.0	1	P1	Single		SUN VALLEY	DS8A-PLED-II-20LED-525mA-30K-VOLTS-1-RAL-9005-T-HS-PLED-MS8-TPR7(MOD	3000K	3420	0.900	35.5	35.5	43-1040-14'-PT27/GFI-RFH-1/2"COUPLING(OCC SENSOR)-	14
vg Layo						BRKT) w/ NXOFM-1R1D-UNV & WSPD-LWO-EM-UNV-BK/WSP-LWO-L180-BK						RAL-9005-T & XPL-1-MOD CAP (7PIN)-RAL-9005-T	

SITE LIGHTING CONTROLS (P1 ONLY)

- EACH POLE SETUP TO BE EQUIPPED WITH NX BLUETOOTH WIRELESS-MESH CONTROL SYSTEM.
- CONTROL SYSTEM IS TO BE ACCESSIBLE VIA IOS APP FOR PROGRAMMING. EACH SITE POLE TO HAVE AN OCCUPANCY SENSOR TO PROVIDE CONTROL BASED ON MOTION.
- . NX CONTROL MODULE TO HAVE PHOTOCELL CAPBABILITY AS WELL AS A BUILT-IN TIME KEEPER FUNCTIONALITY TO ALLOW FOR SCHEDULING DIMMING EVENTS BASED ON TIME OF DAY.
- ALL SITE LIGHTS TO TURN ON AT DUSK AND OFF AT DAWN.
- LIGHTS TO REMAIN FULL BRIGHTNESS UNIT 12 A.M., AT WHICH TIME THE LIGHTS WILL DIM TO 50% OUTPUT UNTIL
- ANY MOTION DETECTED ON SITE AFTER 12 A.M. WILL KICK THE POWER UP TO 100% BRIGHTNESS. AFTER A DURATION OF 15 MINUTES WITH NO MOTION DETECTION. THE LIGHTS WILL RESUME BACK TO THE DIMMED 50%
- MULTIPLE LIGHT FIXTURES TO BE GROUPED TOGETHER INTO ZONES BASED ON AREA AND TRAFFIC PATTERNS MOTION DETECTION WILL ACTIVATE THE ENTIRE ZONE. NOT THE INDIVIDUAL FIXTURE. TO ENSURE UNIFORM COVERAGE IN THE AREA.

LIGHTING NOTES (FOR P1 ONLY)

- THE CONTRACTOR'S BID SHALL INCLUDE ALL EQUIPMENT, MATERIALS, LABOR, ETC. TO PROVIDE A COMPLETE AND OPERATING SITE LIGHTING SYSTEM INCLUDING, BUT NOT LIMITED TO: LIGHTS, POLES POLE FOUNDATIONS, TRANSFORMERS, DISTRIBUTION PANELS, CIRCUIT BOXES, CONTROL, SWITCHES, WIRE, CONDUIT AND PULL BOXES, AND LIGHTING CONTROL PANEL AND ELECTRICAL SERVICE. THE CONTRACTOR SHALL INCLUDE IN THEIR PRICING ALL PROFESSIONAL SERVICES TO PROVIDE DETAILED ELECTRICAL DESIGNS AND DETAILS SUITABLE FOR OBTAINING BUILDING PERMITS AND
- CONSTRUCTION OF THE PROPOSED LIGHTING SYSTEM COMPLETE.

- POLES SHALL BE AS SHOWN ON THE LUMINAIRE SCHEDULE OR APPROVED EQUAL. CONTRACTOR SHALL PROVIDE SHOP DRAWINGS CERTIFIED BY MANUFACTURER'S ENGINEER FOR WIND RATING
- (90MPH), POLE COLOR TO BE BLACK OR AS APPROVED BY BOROUGH OF BOGOTA PRIOR TO ORDERING. SITE LIGHTING SHALL BE ON A TIMER AND SHALL BE IN ACCORDANCE WITH ALL ON/OFF TIMING REQUIREMENTS FOR SITE LIGHTING.
- CONTRACTOR SHALL COORDINATE ELECTRICAL SERVICE WITH PSE&G AND THE COST TO PROVIDE NEW ELECTRICAL SERVICE, METER, PULL BOXES, CONDUIT, WIRE, AND ALL ELSE NECESSARY TO
- PROVIDE FULLY OPERATIONAL LIGHTING SYSTEM SHALL BE INCLUDED IN THE BID PRICE. . SUBISITIONS WITHOUT SUPPORTING PHOTOMETRIC ANALYSIS WILL NOT BE REVIEWED.
- 2. SEE ELECTRICAL DESIGN BY MEP ENGINEER FOR ENERGIZING OF EXTERIOR SITE LIGHTING.

GENERAL NOTES

EXISTING CONDITIONS AS PER PLAN ENTITLED, "TOPOGRAPHIC SURVEY, EVERETT PARK, BLOCK 707 LOT 10, TOWNSHIP OF VERONA, ESSEX COUNTY, NEW JERSEY," PREPARED BY NEGLIA ENGINEERING ASSOCIATES, DATED JUNE 6, 2023.

MUSCO LIGHTING NOTES

- THE SCOPE OF WORK FOR THE SPORTS LIGHTING STRUCTURE RETROFIT COMPLETE SYSTEM UPGRADES INCLUDES LIGHT POLES A1, A2, B1 AND B2, RELOCATING POLE A1 AND A2 WITH NEW POLE FOUNDATIONS, INSTALLATION OF
- LIGHTING CONTROLS, AND ELECTRIFICATION OF SPORTS LIGHTING SYSTEM THE WORK FOR CONSTRUCTING THE NEW POLE FOUNDATION INCLUDING BUT NOT LIMITED TO CONCRETE FOUNDATION, EXCAVATION AND DISPOSAL OF MATERIAL, RE-ASSEMBLING THE STEEL LIGHT POLE, REPLACING THE EXISTING MUSCO LUMINARIES WITH NEW LUMINARIES ON THE LIGHT POLES, INSTALLATION OF LIGHTING CONTROL PANEL, AND ELECTRIFICATION OF THE SPORTS SYSTEM SHALL BE INCLUDED IN THE PRICE FOR THE ITEM: SPORTS LIGHTING LIGHT
- STRUCTURE RETROFIT COMPLETE SYSTEM UPGRADE. THE CONTRACTOR SHALL INSTALL THE SPORTS LIGHTING CONTROL PANEL IN THE CONCESSION BUILDING AS SHOWN ON THE ELECTRICAL PLAN SHEET E101. CONTRACTOR SHALL COORDINATE INSTALLATION OF LIGHTING CONTROLS WITH VSBL
- CONTRACTORS (OTHERS). 4. SEE ELECTRICAL DESIGN BY MEP ENGINEER FOR ENERGIZING OF SPORTS SITE LIGHTING.

0 8

LYNDHURS1 34 PARK AVENUE. PO BOX 476

FINAL



NEGLIA GROUP

EVERETT PARK IMPROVEMENTS

BLOCK 707 - LOT 10 TOWNSHIP OF VERONA COUNTY OF ESSEX STATE OF NEW JERSEY

ANTHONY KURUS, PE, PP

PROFESSIONAL ENGINEER
N.J. LICENSE NO. 24GE04644500
PROFESSIONAL PLANNER
N.J. LICENSE NO. 33L10061450

MATEO F. LUZURIAGA, PE PROFESSIONAL ENGINEER


N.J. LICENSE NO. 24GE06029800

SCALE:

LIGHTING PLAN

DESIGNED BY:	M.F.L.	CHECKED	BY:	A.K.
PROJECT NO.: V	0	.00		
DATE: NOVEMBER 2024				UU

DRAWN BY: M.F.L.

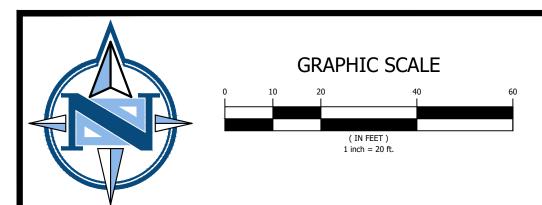

SOIL DECOMPACTION NOTE


AS DETERMINED BY THE STATE POLICY MAP, THE PROJECT AREA FALLS WITHIN THE METROPOLITAN PLANNING AREA (PA1). UNDER EXISTING CONDITIONS, THE SITE IS NOT COVERED IN WOODY VEGETATION NOR REGROWTH. IN ACCORDANCE WITH NEW JERSEY STANDARD FOR LAND GRADING (REVISED 2017), NON-WOODY VEGETATED PA1 AREAS FALL UNDER THE SOIL COMPACTION EXEMPTION LIST AS AN "URBAN DEVELOPMENT" AND IS DEFINED BY NJDEP AS "PREVIOUSLY

GENERAL NOTES


EXISTING CONDITIONS AS PER PLAN ENTITLED, "TOPOGRAPHIC SURVEY, EVERETT PARK, BLOCK 707 LOT 10, TOWNSHIP OF VERONA, ESSEX COUNTY, NEW JERSEY," PREPARED BY NEGLIA ENGINEERING ASSOCIATES, DATED JUNE 6, 2023.

RESTORATION OF DISTURBED AREAS

ALL VEGETATED AREAS WITHIN THE DISTURBED LIMITS OF THE PROJECT SHALL RECEIVE TOPSOIL, FERTILIZER, HYDRO-SEEDING OR SOD AND MULCH PER PLANS. ALL SEEDED AREAS SHALL BE MULCHED WITH SALT HAY, PENN MULCH, OR APPROVED EQUAL. SEE SPECIFICATIONS FOR SOD, LAWN, TOPSOIL DETAILS. TOPSOIL SHALL BE SCREENED TOPSOIL SHALL CONTAIN NO STONES, LUMPS, ROOTS, OR SIMILAR OBJECTS LARGER THAN 1/2 INCH IN ANY DIMENSION, AND SHALL HAVE A PH VALUE OF NOT LESS THAN 5.8. WHEN THE PH VALUE OF THE TOPSOIL IS LESS THAN 5.8, IT SHALL BE INCREASED BY APPLYING GROUND LIMESTONE AT A RATE NECESSARY TO ATTAIN A PH VALUE OF 6.5. TOPSOIL SHALL BE INSPECTED AND APPROVED BY THE PROJECT LANDSCAPE ARCHITECT OR ENGINEER PRIOR TO PLACEMENT. ANY TOPSOIL IMPORTED FOR CONSTRUCTION SHALL BE CERTIFIED CLEAN. WHEN THE ORGANIC CONTENT OF THE TOPSOIL FURNISHED FROM SOURCES OUTSIDE THE LIMITS OF THE PROJECT IS LESS THAN 2.75 PERCENT, IT SHALL BE INCREASED BY ADDING PEAT AT A RATE NECESSARY TO ATTAIN THIS MINIMUM ORGANIC CONTENT. THE ORGANIC CONTENT OF SOILS SHALL BE DETERMINED BY THE LABORATORY USING THE CHROMIC ACID TITRATION METHOD, AS DESCRIBED IN THE UNITED STATES DEPARTMENT OF AGRICULTURE'S CIRCULAR 757. ALL LABORATORY TESTING REPORTS SHALL BE SUBMITTED TO THE PROJECT LANDSCAPE ARCHITECT OR ENGINEER FOR APPROVAL PRIOR TO CONSTRUCTION. THE GRADATION OF THE TOPSOIL FURNISHED FROM SOURCES OUTSIDE THE LIMITS OF THE PROJECT SHALL BE DETERMINED BY THE LABORATORY, USING THE BOUYOUCOS HYDROMETER ANALYSIS CONFORMING TO THE REQUIREMENTS OF CURRENT A.A.S.H.O. DESIGNATION T88. CONTRACTOR SHALL WATER SEEDED/SODDED AREAS DAILY AND AS REQUIRED TO ESTABLISH NEW TURF/MEADOW

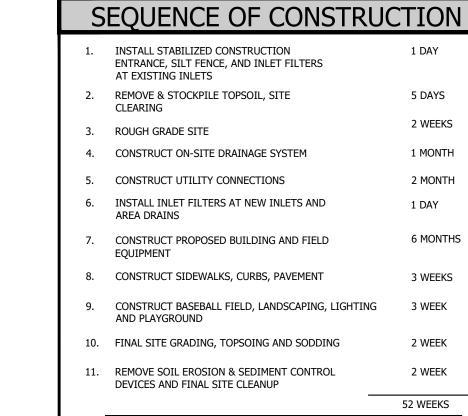

FOR SOIL CONSERVATION DISTRICT SUBMISSION ONLY. CONTRACTOR TO PROVIDE DETAILED CONSTRUCTION SCHEDULE

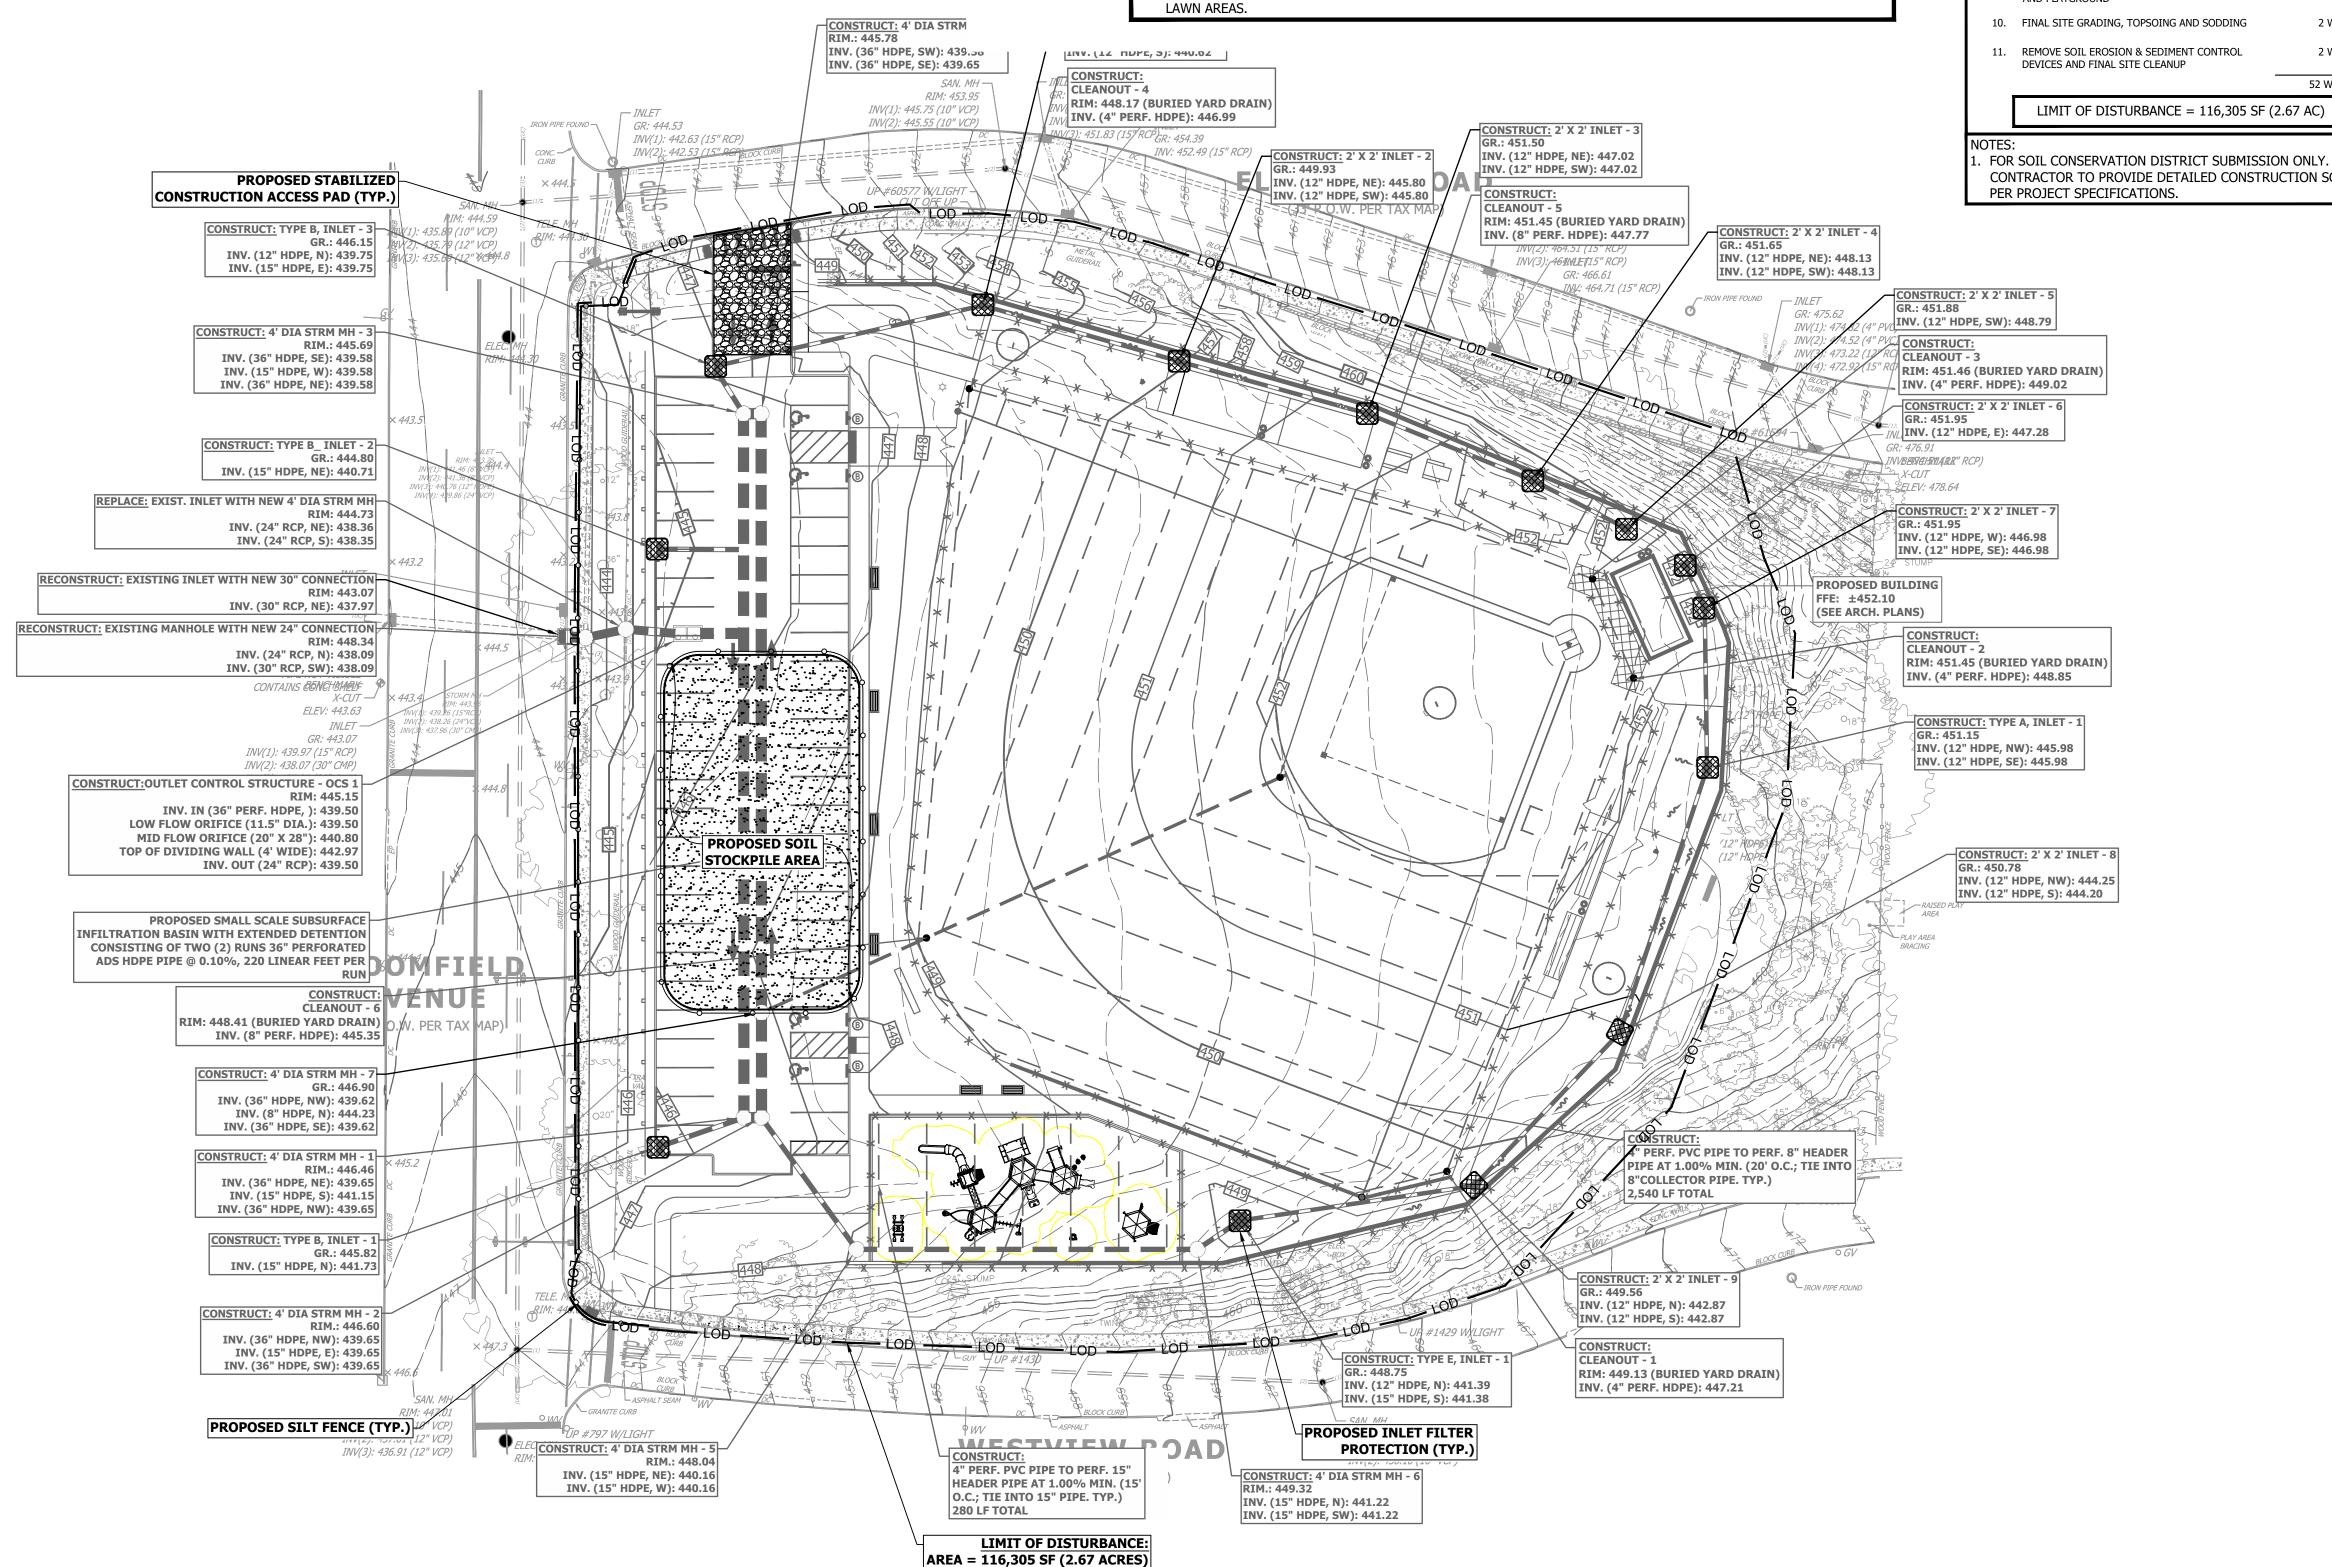

AINSIDI COUCENTED AND LYNDHURST
34 PARK AVENUE, PO BOX 426 **FINAL** A PRODUCT OF **NEGLIA GROUP EVERETT PARK IMPROVEMENTS** BLOCK 707 - LOT 10 TOWNSHIP OF VERONA COUNTY OF ESSEX **ANTHONY KURUS, PE, PP** PROFESSIONAL ENGINEER
N.J. LICENSE NO. 24GE04644500 PROFESSIONAL PLANNER
N.J. LICENSE NO. 33LI00614500

STATE OF NEW JERSEY

MATEO F. LUZURIAGA, PE PROFESSIONAL ENGINEER N.J. LICENSE NO. 24GE06029800

SESC PLAN

DRAWN BY: M.F.L. SCALE: AS NOTED

			•		
DESIGNED BY:	M.F.L.	CHECKED	BY:	A.K.	
PROJECT NO.: V	0	0			
DATE: NOVEMBE	R 2024		5	.00	

HUDSON-ESSEX-PASSAIC SOIL CONSERVATION DISTRICT SOIL EROSION & SEDIMENT CONTROL NOTES

- ALL SOIL EROSION AND SEDIMENT CONTROL PRACTICES ON THIS PLAN WILL BE CONSTRUCTED IN ACCORDANCE WITH THE "NEW JERSEY STANDARDS FOR SOIL EROSION AND SEDIMENT CONTROL" 7TH EDITION LAST REVISED JULY 2017, EFFECTIVE DECEMBER 2017. THESE MEASURES WILL BE INSTALLED PRIOR TO ANY MAJOR SOIL DISTURBANCE OR IN THEIR PROPER SEQUENCE AND MAINTAINED UNTIL PERMANENT PROTECTION IS ESTABLISHED.
- SOIL TO BE EXPOSED OR STOCKPILED FOR A PERIOD OF GREATER THAN 14 DAYS, AND NOT UNDER ACTIVE CONSTRUCTION, MAY BE REQUIRED TO BE TEMPORARILY MULCHED, AND SEEDED OR OTHERWISE PROVIDED WITH VEGETATIVE COVER AS PER APPENDIX A3. THIS TEMPORARY COVER SHALL BE MAINTAINED UNTIL SUCH TIME WHEREBY PERMANENT RESTABILIZATION IS ESTABLISHED.
- SEEDING DATES: THE FOLLOWING SEEDING DATES ARE RECOMMENDED TO BEST ESTABLISH PERMANENT VEGETATIVE COVER WITHIN MOST LOCATIONS IN THE HEPSCD: SPRING - 3/1-5/15 AND FALL - 8/15 - 10/1
- 4. SEDIMENT FENCES ARE TO BE PROPERLY TRENCHED AND MAINTAINED UNTIL PERMANENT VEGETATIVE COVER IS ESTABLISHED
- 5. ALL STORM DRAINAGE INLETS SHALL BE PROTECTED BY ONE OF THE PRACTICES ACCEPTED IN THE STANDARDS, AND PROTECTION SHALL REMAIN UNTIL PERMANENT STABILIZATION HAS BEEN ESTABLISHED. STORM DRAINAGE OUTLET POINTS SHALL BE PROTECTED AS REQUIRED BEFORE THEY BECOME FUNCTIONAL.
- MULCH MATERIALS SHALL BE UN-ROTTED SMALL GRAIN STRAW APPLIED AT THE RATE OF 70 TO 90 POUNDS PER 1,000 SQUARE FEET AND ANCHORED WITH A MULCH ANCHORING TOOL, LIQUID MULCH BINDERS, OR NETTING TIE DOWN. OTHER SUITABLE MATERIALS MAY BE USED IF APPROVED BY THE SOIL CONSERVATION DISTRICT.
- ALL EROSION CONTROL DEVICES SHALL BE PERIODICALLY INSPECTED, MAINTAINED AND CORRECTED BY THE CONTRACTOR. ANY DAMAGE INCURRED BY EROSION SHALL BE RECTIFIED IMMEDIATELY.
- 8. THE HUDSON-ESSEX-PASSAIC SOIL CONSERVATION DISTRICT WILL BE NOTIFIED IN WRITING AT LEAST 48 HOURS PRIOR TO ANY SOIL DISTURBING ACTIVITIES. FAX - (862) 333-4507 OR EMAIL - INFORMATION@HEPSCD.ORG.
- THE APPLICANT MUST OBTAIN A DISTRICT ISSUED REPORT-OF-COMPLIANCE PRIOR TO APPLYING FOR THE CERTIFICATE OF OCCUPANCY OR TEMPORARY CERTIFICATE OF OCCUPANCY FROM THE RESPECTIVE MUNICIPALITY, NJ - DCA OR ANY OTHER CONTROLLING AGENCY. CONTACT THE DISTRICT AT 862-333-4505 TO REQUEST A FINAL INSPECTION, GIVING ADVANCED NOTICE UPON COMPLETION OF THE RESTABILIZATION MEASURES. A PERFORMANCE DEPOSIT MAY BE POSTED WITH THE DISTRICT WHEN WINTER WEATHER OR SNOW COVER PROHIBITS THE PROPER APPLICATION OF SEED. MULCH, FERTILIZER OR HYDRO-SEED.
- PAVED ROADWAYS MUST BE KEPT CLEAN AT ALL TIMES. DO NOT UTILIZE A FIRE OR GARDEN HOSE TO CLEAN ROADS UNLESS THE RUNOFF IS DIRECTED TO A PROPERLY DESIGNED AND FUNCTIONING SEDIMENT BASIN. WATER PUMPED OUT OF THE EXCAVATED AREAS CONTAINS SEDIMENTS THAT MUST BE REMOVED PRIOR TO DISCHARGING TO RECEIVING BODIES OF WATER USING REMOVABLE PUMPING STATIONS, SUMP PITS, PORTABLE SEDIMENTATION TANKS AND/OR SILT CONTROL BAGS.
- 11. ALL SURFACES HAVING LAWN OR LANDSCAPING AS FINAL COVER ARE TO BE PROVIDED TOPSOIL PRIOR TO RE-SEEDING, SODDING OR PLANTING, A DEPTH OF 5.0 INCHES, FIRMED IN PLACE, IS REQUIRED, AS PER THE STANDARDS FOR TOPSOILING AND LAND GRADING, EFFECTIVE DECEMBER 2017.
- 12. ALL PLAN REVISIONS MUST BE SUBMITTED TO THE DISTRICT FOR PROPER REVIEW AND APPROVAL.
- 13. A CRUSHED STONE WHEEL CLEANING TRACKING-PAD IS TO BE INSTALLED AT ALL SITE EXITS USING 2 ½ -1" CRUSHED ANGULAR STONE (ASTM 2 OR 3) TO A MINIMUM LENGTH OF 50 FEET AND MINIMUM DEPTH OF 6". ALL DRIVEWAYS MUST BE PROVIDED WITH CRUSHED STONE UNTIL PAVING IS COMPLETE.
- 14. STEEP SLOPES INCURRING DISTURBANCE MAY REQUIRE ADDITIONAL STABILIZATION MEASURES. THESE "SPECIAL" MEASURES SHALL BE DESIGNED BY THE APPLICANT'S ENGINEER AND BE APPROVED BY THE SOIL CONSERVATION DISTRICT.
- THE HUDSON-ESSEX-PASSAIC SOIL CONSERVATION DISTRICT SHALL BE NOTIFIED, IN WRITING, FOR THE SALE OF ANY PORTION OF THE PROJECT OR FOR THE SALE OF INDIVIDUAL LOTS. NEW OWNERS' INFORMATION SHALL BE PROVIDED. ADDITIONAL MEASURES DEEMED NECESSARY BY DISTRICT OFFICIALS SHALL BE IMPLEMENTED AS CONDITIONS WARRANT.

Dust Control Notes

following methods should be considered for controlling dust:

Mulches - See Standard for Stabilization with Mulches Only (pg. 5-1)

<u>Vegetative Cover</u> - See Standard for Temporary Vegetative Cover (pg. 7-1), Permanent Vegetativ Cover for Soil Stabilization (pg. 4-1), and Permanent Stabilization with Sod (pg. 6-1)

Spray-On Adhesives - On mineral soils (not effective on muck soils). Keep traffic off these areas.

Table 16-1: Dust Control Materials

MATERIAL	WATER	TYPE OF	APPLY
MATERIAL	DILUTION	NOZZLE	GALLONS/ACRE
Anionic asphalt emulsion	7 :I	Coarse Spray	1200
Latex emulsion	12.5:1	Fine Spray	235
Resin in water	4:1	Fine Spray	300
Polyacrylamide (PAM) - spray on Polyacrylamide (PAM) - dry spray	May also be flocculat	used as an additi e and precipitate	ve to sediment basins to suspended colloids. andard (pg. 26-1)
Acidulated Soy Bean Soap Stick	None	Coarse Spray	1200

Tillage - To roughen surface and bring clods to the surface. This is a temporary emergence measure which should be used before soil blowing starts. Begin plowing on windward side of site Chisel-type plows spaced about 12 inches apart, and spring-toothed harrows are examples c equipment which may produce the desired effect.

Sprinkling - Site is sprinkled until the surface is wet.


or accumulation around plants.

Barriers - Solid board fences, snow fences, burlap fences, crate walls, bales of hay, and simila material can be used to control air currents and soil blowing.

Calcium Chloride - Shall be in the form of loose, dry granulates of flakes fine enough to fee through commonly used spreaders at a rate that will keep surface moist but not cause pollution (plant damage. If used on steeper slopes, then use other practices to prevent washing into stream

Stone - Cover surface with crushed stone or coarse gravel.

DUST CONTROL NOTES

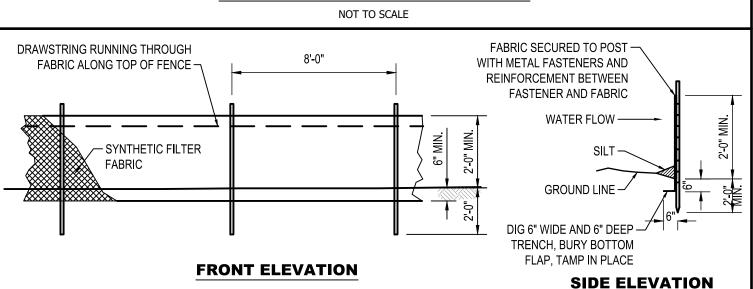

FILTER FENCE DETAIL

INLET PROTECTION STANDARDS

DEFINITION

A TEMPORARY BARRIER AND SETTLING FACILITY INSTALLED AT A STORM SEWER INLET.

PURPOSE

THE PURPOSE OF STORM SEWER INLET PROTECTION IS TO INTERCEPT. AND RETAIN SEDIMENT, THUS PREVENTING THE ENTRANCE OF SEDIMENT INTO THE STORM SEWER SYSTEM.

CONDITIONS WHERE PRACTICE APPLIES

- 1. CONTRIBUTING DRAINAGE AREA IS 3 ACRES OR LESS.
- 2. A STORM SEWER OR THE OUTLET CHANNEL OF A STORM SEWER NEEDS PROTECTION FROM SEDIMENT.
- 3. TRAFFIC WILL NOT DESTROY OR CAUSE CONSTANT MAINTENANCE OF THE STORM SEWER INLET PROTECTION.
- 4. A TRAFFIC HAZARD WILL NOT BE CREATED.
- 5. A FLOODING PROBLEM WILL NOT BE CREATED.

WATER QUALITY ENHANCEMENT

THE PRIMARY BENEFIT TO WATER QUALITY IS REMOVAL OF SEDIMENT FROM STORMWATER RUNOFF PRIOR TO ENTERING THE STORM SEWER SYSTEM. AS AN ADDED BENEFIT, OTHER FLOATABLE DEBRIS, SUCH AS VEGETATIVE MATTER AND LITTER MAY ALSO BE FILTERED OUT OF THE RUNOFF.


DESIGN CRITERIA

THE FOLLOWING APPLIES TO ALL METHODS OF STORM SEWER INLET PROTECTION:

- MUST SLOW THE STORM WATER, PROVIDE THE COARSE SEDIMENT PARTICLES A CHANCE TO SETTLE, AND PROVIDE AN AREA TO RETAIN THE PARTICLES THAT HAVE SETTLED.
- 2. IN ALL CASES, THE INLET PROTECTION SHOULD NOT COMPLETELY CLOSE OFF THE INLET.
- 3. THE PROTECTION DEVICE WILL BE DESIGNED TO CAPTURE OR FILTER RUNOFF FROM THE 1 YEAR, 24 HOUR STORM EVENT AND SHALL SAFELY CONVEY HIGHER FLOWS DIRECTLY INTO THE STORM SEWER SYSTEM.

OTHER METHODS THAT ACCOMPLISH THE PURPOSE OF STORM SEWER INLET PROTECTION MAY BE USED IF APPROVED BY THE SOIL CONSERVATION DISTRICT.


INSPECTIONS SHALL BE FREQUENT. MAINTENANCE, REPAIR, AND REPLACEMENT SHALL BE MADE PROMPTLY, AS NEEDED. THE BARRIER SHALL BE REMOVED WHEN THE AREA DRAINING TOWARD THE INLET HAS BEEN STABILIZED.

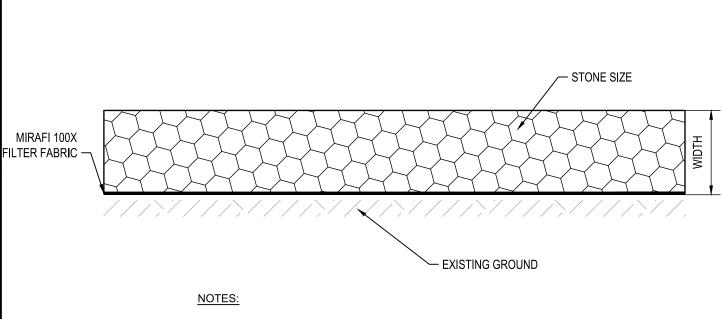

- 1. APPROPRIATE TRANSITION BETWEEN STABILIZED CONSTRUCTION. ENTRANCE AND PUBLIC R.O.W. MUST BE PROVIDED.
- 2. THE RATIO OF STONE SIZE TO WIDTH MUST BE 9:27.

STABILIZED CONSTRUCTION PAD

NOT TO SCALE

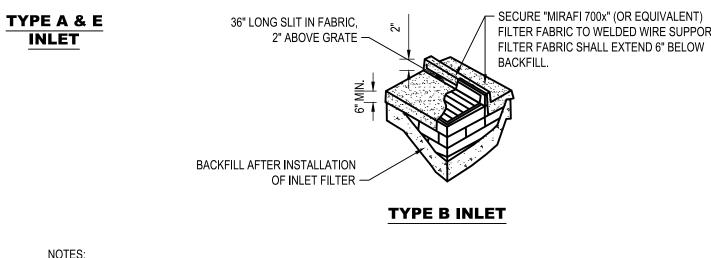

1. CONTRACTOR IS TO INSPECT INLET FILTER AFTER EVERY STORM, AND CLEAN OR REPLACE AS REQUIRED 2. CONTRACTOR IS TO REMOVE FABRIC AND MESH JUST PRIOR TO PAVING 3. FILTER FABRIC SHALL BE "MIRAFI 700X" TYPE OR APPROVED EQUAL 4. INLET FILTER SHALL FILTER RUNOFF FROM THE 1 YEAR 24 HOUR STORM EVENT AND SHALL SAFELY CONVEY HIGHER FLOWS DIRECTLY INTO STORM SEWER SYSTEM.

WIRE MESH WITH 1/2" OPENINGS SHALL

EXTEND 6" MIN. & SIDES

GRAVEL FILTER BERM


- 12" x 12" OPENING IN FABRIC

2" HIGH x 12" WIDE $rac{3}{4}$ " CLEAN

BE PLACED OVER FRAME & GRATE AND

INLET FILTER & PROTECTION

NOT TO SCALE

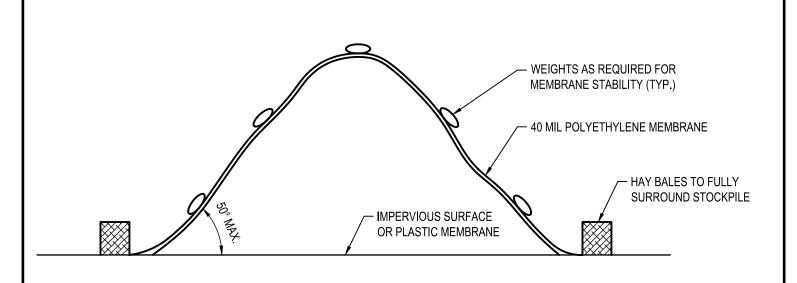


1. FOR NON-CONTAMINATED SOIL, SURROUND STOCKPILE WITH SILT FENCE.

SOIL STOCKPILE


NOT TO SCALE

STAKES / REBAR

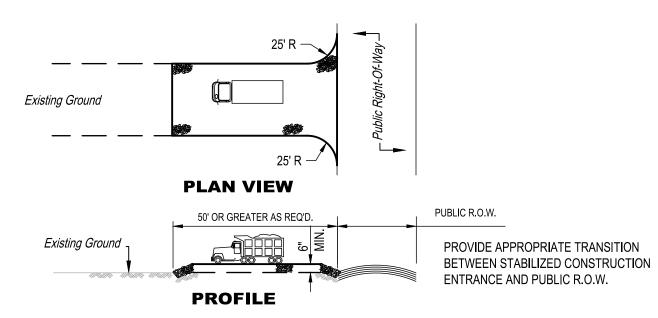

- PLACE STABILIZED CONSTRUCTION ENTRANCE AT LOCATION(S) AS SHOWN ON THE SOIL EROSION AND SEDIMENT CONTROL PLAN.
- STONE SIZE SHALL BE ASTM C-33, SIZE NO.2 OR 3, CRUSHED STONE THE THICKNESS OF THE STABILIZED CONSTRUCTION ENTRANCE SHALL NOT BE LESS THAN 6".
- THE WIDTH AT THE EXIST. PAVEMENT SHALL NOT BE LESS THAN THE FULL WIDTH OF POINTS OF INGRESS AND EGRESS. THE STAB. CONST. ENT. SHALL BE MAINTAINED IN A CONDITION WHICH WILL PREVENT TRACKING OR FLOWING OF SEDIMENT ONTO THE
- R.O.W./PAVEMENT. THIS REQUIRES PERIODIC TOP DRESSING WITH ADDITIONAL STONE OR ADDITIONAL LENGTH AS CONDITIONS DEMAND AND REPAIR AND/OR CLEANOUT OF ANY MEASURE USED TO TRAP SEDIMENT.
- ALL SEDIMENT SPILLED, DROPPED, WASHED, OR TRACKED ONTO THE PUBLIC ROADWAY MUST BE REMOVED IMMEDIATELY.
- APPROPRIATE TRANSITION BETWEEN STAB. CONST. ENT. & PUBLIC R.O.W. MUST BE PROVIDED. THE RATIO OF STONE SIZE TO WIDTH MUST BE 9:27.
 - PERCENT SLOPE OF ROADWAY FINED GRAINED SOILS ENTIRE SURFACE STABILIZED WITH FABC BASE COURS


STABILIZED CONSTRUCTION ACCESS

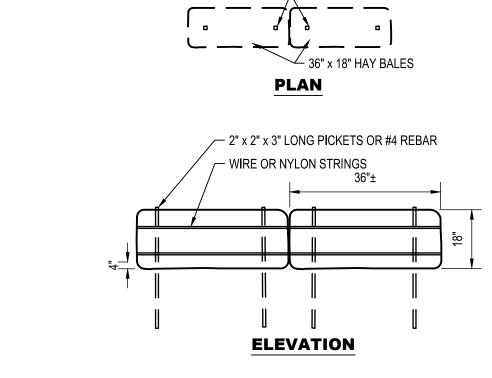

- 1. RING BARRIER TO REMAIN IN PLACE UNTIL SITE IS STABILIZED
- 2. ALL BALES SHALL BE EITHER WIRE BOUND OR NYLON STRING TIED 3. ALL BALES SHALL BE PLACED TIGHTLY ABUTTING ADJACENT BALES
- 4. EACH BALE SHALL BE EMBEDDED 4" IN THE GROUND BALES SHALL BE ANCHORED WITH 2" x 2" x 3' STAKES OR #4 REBAR DRIVEN THROUGH THE BALES A MINIMUM OF 18" INTO THE GROUND. THE FIRST STAKE IN EACH BALE SHALL BE DRIVEN TOWARD THE PLACED BALE TO FORCE BALES TOGETHER.

HAY BALE

NOT TO SCALE

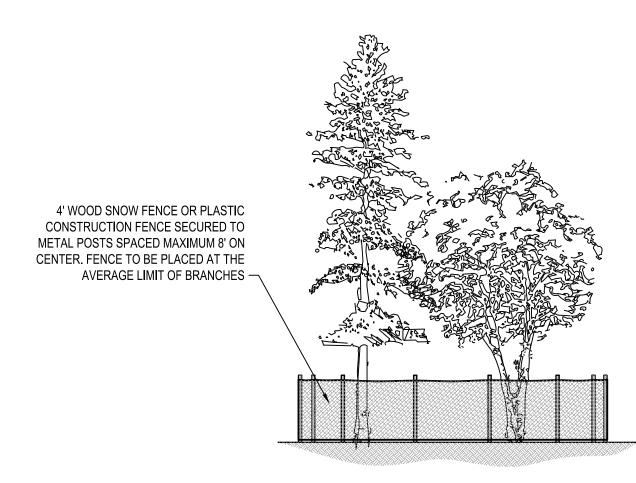

1. CONSTRUCTION EQUIPMENT OF ANY KIND IS TO BE PROHIBITED FROM DRIVING AND/OR PARKING UNDER TREES. THE STOCKPILE OF CONSTRUCTION MATERIAL SHALL BE PROHIBITED FROM BEING STORED UNDER

TREE PROTECTION

NOT TO SCALE

SEEDING SPECIFICATIONS

TEMPORARY SEEDING

TEMPORARY VEGETATIVE COVER SHALL CONSIST OF PERENNIAL RYEGRASS APPLIED UNIFORMLY AT A RATE OF 1.0 POUND PER 1,000 SQ. FT. (40 lbs/Ac.), IN ACCORDANCE WITH TABLE 7-2, PAGE 7-3. LIMESTONE (PULVERIZED DOLOMITIC EQUIVALENT TO 50 PERCENT CALCIUM PLUS MAGNESIUM OXIDES) SHALL BE APPLIED AT THE RATE OF 45 lbs/1,000 SQ. FT. (1 TON/Ac.) IN ACCORDANCE WITH TABLE 7-1, PAGE 7.2. FERTILIZER (10-20-10 OR EQUIVALENT) AT THE RATE OF 11 lbs/1,000 SQ. FT. (500 lbs./Ac.) OR EQUIVALENT WITH 50% WATER INSOLUBLE NITROGEN, IN ACCORDANCE WITH PARAGRAPH 2A, PAGE 7-1.

MULCHING IS REQUIRED ON ALL SEEDING AND SHALL BE ACCOMPLISHED AS FOLLOWS:

- MULCH MATERIALS SHOULD BE UNROTTED SALT HAY, HAY, OR SMALL GRAIN STRAW AT A RATE OF 1-1/2 TO 2 TONS PER ACRE, OR 70 TO 90 POUNDS PER 1,000 SQUARE FOOT. MULCH BLOWERS SHOULD NOT GRIND OR CHOP THE MATERIAL.
- SPREAD UNIFORMLY BY HAND OR MECHANICALLY SO THAT APPROXIMATELY 85 PERCENT OF THE SOIL SURFACE WILL BE COVERED. FOR UNIFORM DISTRIBUTION OF HAND SPREAD MULCH, DIVIDE AREA INTO APPROXIMATELY 1,000 SQUARE FOOT SECTIONS AND DISTRIBUTE 70 TO 90 POUNDS WITHIN EACH SECTION.
- 3. MULCH ANCHORING SHALL BE ACCOMPLISHED USING EITHER PEG AND TWINE, MULCH NETTING, MULCH-ANCHORING COULTER TOOL OR LIQUID MULCH-BINDERS, PER THE ACCOMPANYING "STABILIZATION WITH MULCH ONLY" SPECIFICATION. * OPTIMUM SEEDING DATES: 3/1 - 5/15 AND 8/15 - 10/1

PERMANENT SEEDING

- TOPSOIL TO BE PLACED TO A DEPTH OF 4 INCHES ON EXPOSED SOILS UPON COMPLETION OF FINAL GRADING.
- SEED IS TO BE UNIFORMLY APPLIED TO THE NORMAL DEPTH OF 1/4 INCH TO 1/2 INCH (EXCEPT HYDRO SEEDING). ZONE 6b SEED MIXTURE 17. AS SHOWN ON PAGE 4-12 IN THE SOIL EROSION STANDARDS. THE SEEDING RATE SHALL BE:

CLLB MIXTORE IT, NO CHOWN CITTAGE I	IZ IIV THE GOIL ERGOIOTY G	171110711100. 11
SEED MIXTURE	PLANTING F	RATE
	LBS PER	LBS PER
	ACRE	1,000 SF
HARD FESCUE	120	2.7
CREEPING FESCUE	30	0.7
PERENIAL RYEGRASS	10	0.25

- * OPTIMAL SEEDING DATES: 3/1 4/30 AND 8/15 10/15
- 3. MULCHING WILL BE ACCOMPLISHED PER THE BELOW TEMPORARY SEEDING SPECIFICATION.
- *MAY BE PLANTED THROUGHOUT SUMMER IF SOIL MOISTURE IS ADEQUATE OR SOIL CAN BE IRRIGATED.

SOIL PREPARATION

SUITABLE EQUIPMENT WILL BE USED TO PREPARE A REASONABLE, UNIFORM, FINE SEED BED TO A MINIMUM DEPTH OF 4

APPLY GROUND LIMESTONE AND FERTILIZER ACCORDING TO SOIL TEST RECOMMENDATIONS. FERTILIZER SHALL BE APPLIED AT THE RATE OF 500 POUNDS PER ACRE OR 11 POUNDS PER 1,000 SQUARE FEET USING 10-20-10 OR EQUIVALENT WITH 50% WATER INSOLUBLE NITROGEN UNLESS A SOIL TEST INDICATES OTHERWISE. LIME SHALL BE PULVERIZED DOLOMITIC LIMESTONE. CALCIUM CARBONATE IS THE EQUIVALENT AND STANDARD FOR MEASURING THE ABILITY OF LIMING MATERIALS TO NEUTRALIZE SOIL ACIDITY AND SUPPLY CALCIUM AND MAGNESIUM TO GRASSES AND LEGUMES. THE FOLLOWING TABLE IS A GENERAL GUIDELINE FOR LIMESTONE APPLICATION RATES:

SOIL TEXTURE	TONS/ACRE	LBS./1000 SQ. FT.
CLAY, CLAY LOAM, & HIGHLY ORGANIC SOIL	3	135
SANDY LOAM, LOAM, SILT LOAM	2	90
LOAMY SAND, SAND	1	45

WORK LIME AND FERTILIZER INTO THE TOPSOIL AS NEARLY AS PRACTICAL TO A DEPTH OF 4 INCHES WITH A DISC, SPRINGTOOTH HARROW, OR OTHER SUITABLE EQUIPMENT

0 8

YNDHURST PARK AVENUE. PO BOX 426

FINAL

A PRODUCT OF

NEGLIA GROUP

EVERETT PARK IMPROVEMENTS

BLOCK 707 - LOT 10 TOWNSHIP OF VERONA COUNTY OF ESSEX STATE OF NEW JERSEY

ANTHONY KURUS, PE, PP

PROFESSIONAL ENGINEER
N.J. LICENSE NO. 24GE04644500 PROFESSIONAL PLANNER
N.J. LICENSE NO. 33LI00614500


MATEO F. LUZURIAGA, PE PROFESSIONAL ENGINEER N.J. LICENSE NO. 24GE06029800

SESC DETAILS

DRAWN BY: M.F.L. SCALE: N.T.S. DESIGNED BY: M.F.L. CHECKED BY: A.K DATE: NOVEMBER 2024

CERTIFICATE OF AUTHORIZATION (N.J.S.A. 45:8-56) 24GA27927000

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CURB & SIDEWALK CONSTRUCTION AT MAINTAIN AT LEAST ONE LANE OF TRAFFIC — **CURB RETURNS** CURB & SIDEWALK APROACH LEFT CONSTRUCTION AT TRAFFIC DRUMS/BARRICADES ——— **CURB RETURNS** DEPART LEFT CONSTRUCTION AREA (TYP) — **CURB & SIDEWALK** NO PARKING IS PERMITTED **CONSTRUCTION AT CURB & SIDEWALK** ADJACENT TO ANY CURB AND **CURB RETURNS** CONSTRUCTION AT SIDEWALK CONSTRUCTION -**CURB & SIDEWALK** APROACH RIGHT MID BLOCK CONSTRUCTION AT LEFT & RIGHT CURB RETURNS TRAFFIC CONTROL FOR CURB & SIDEWALK CONSTRUCTION

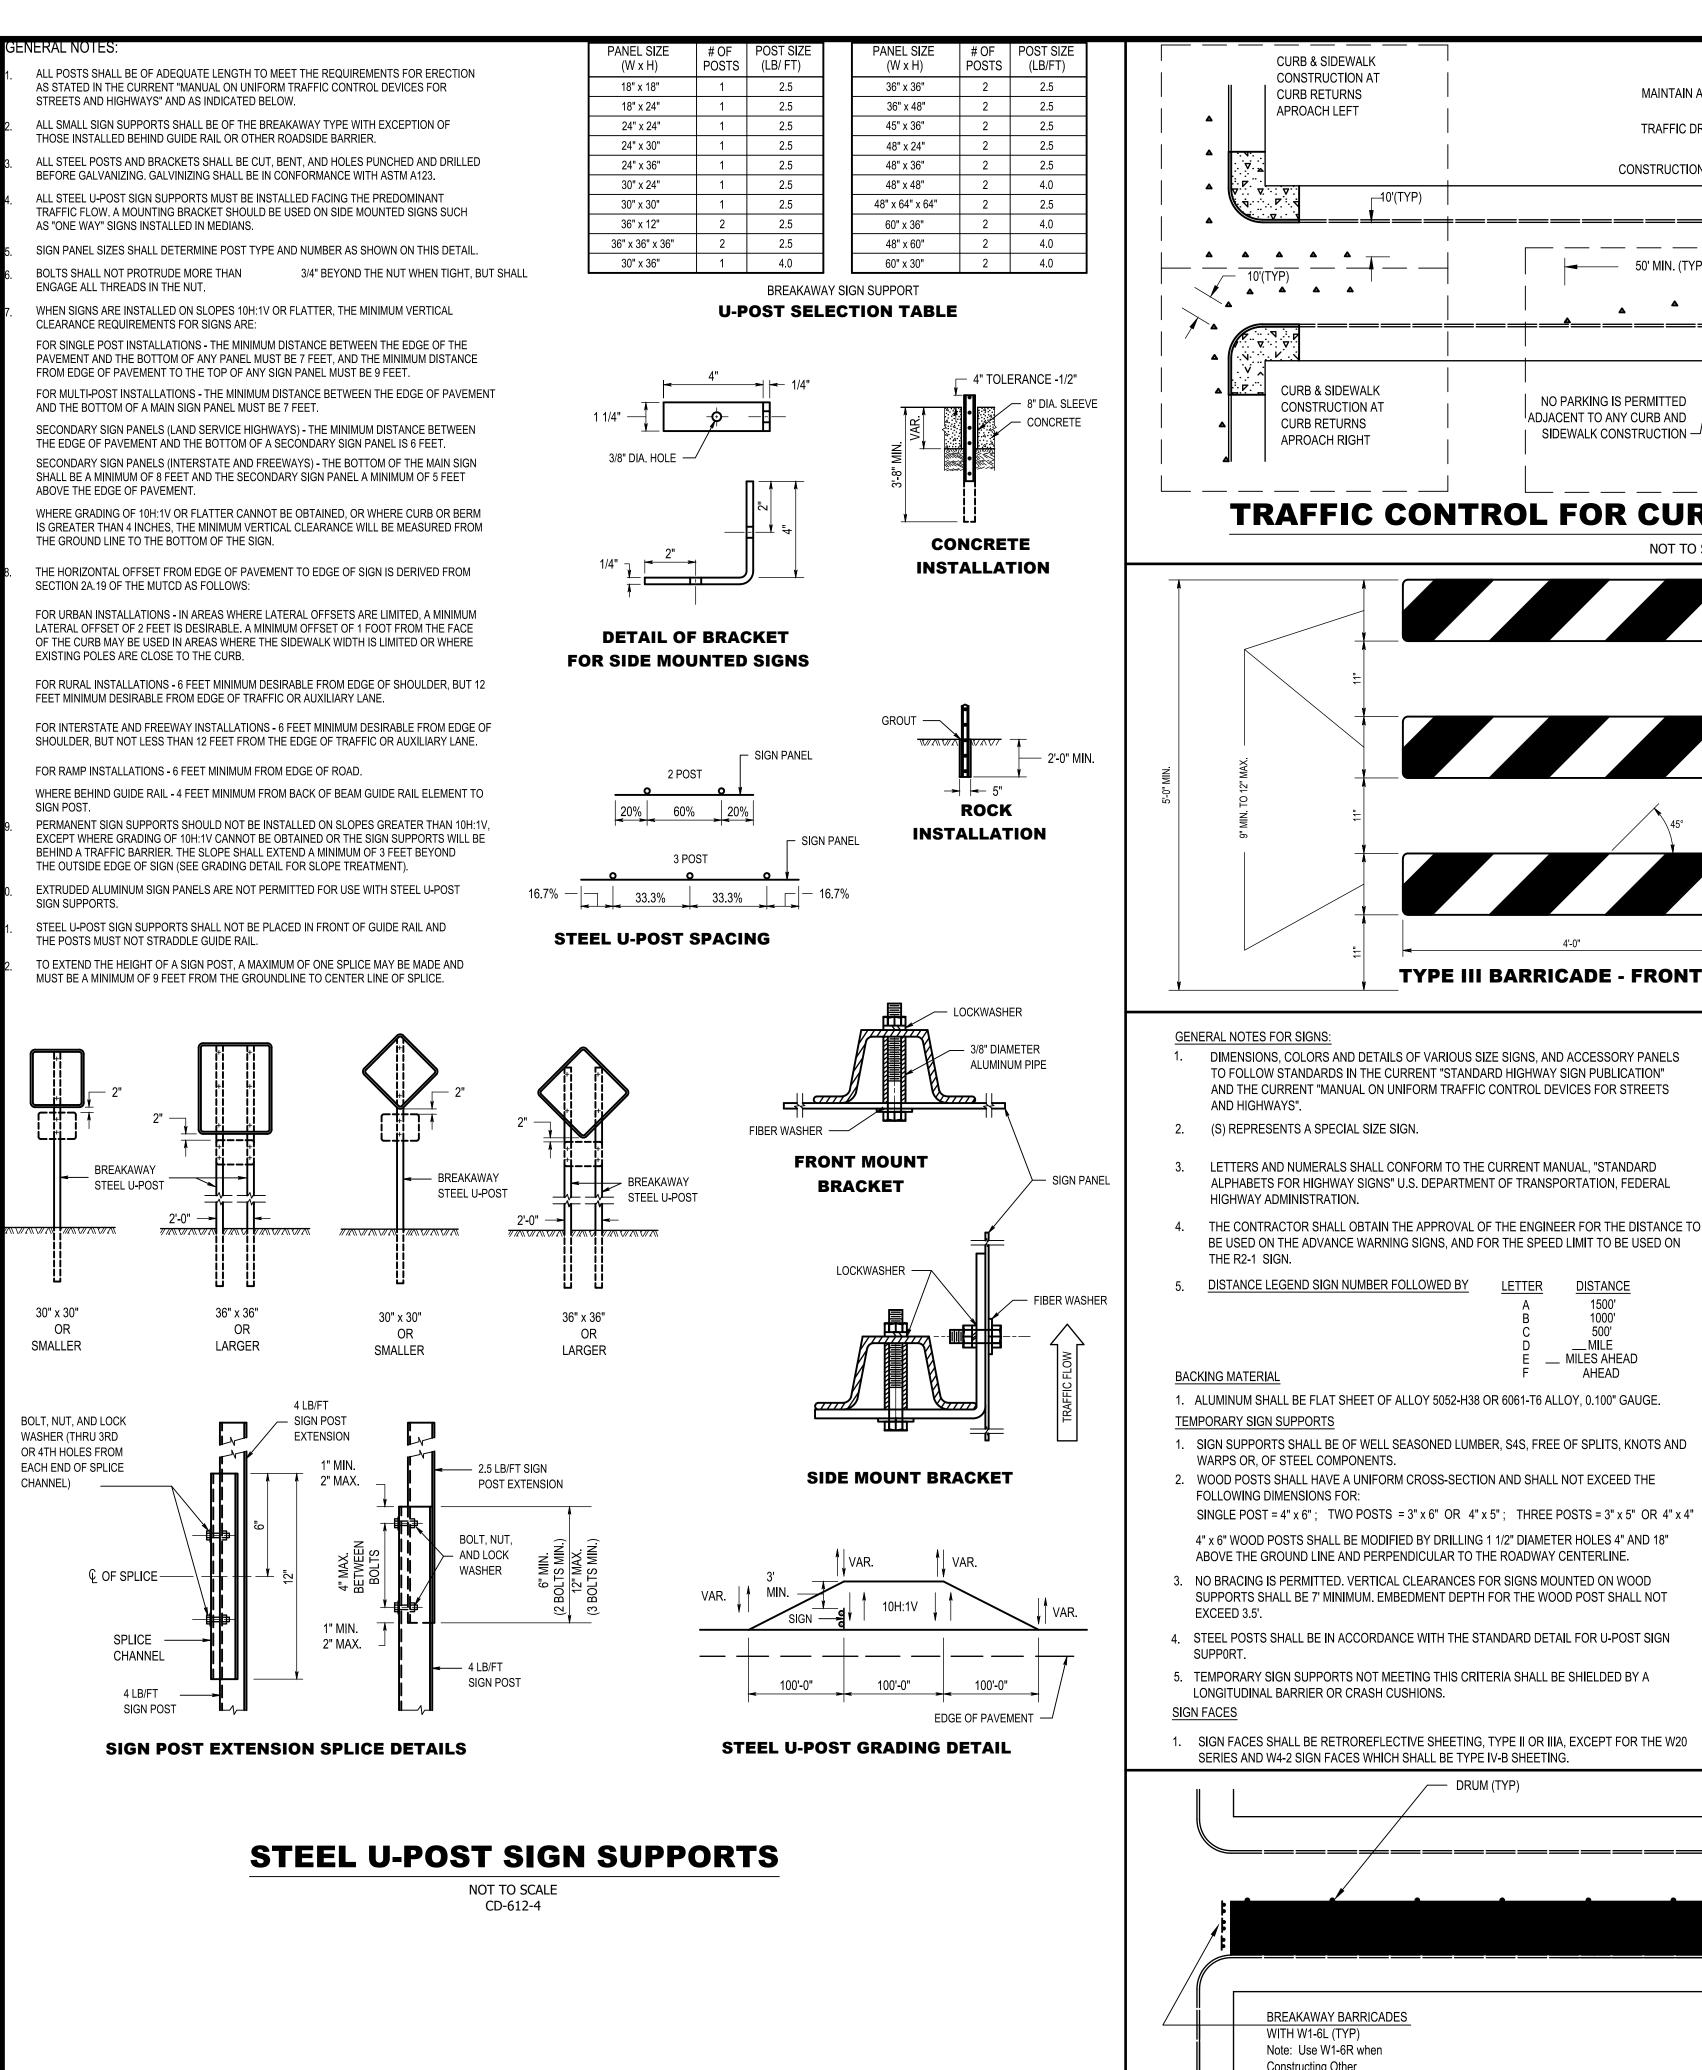TYPE III BARRICADE - FRONT VIEW

BE USED ON THE ADVANCE WARNING SIGNS, AND FOR THE SPEED LIMIT TO BE USED ON

AND HIGHWAYS".

HIGHWAY ADMINISTRATION.

- 1. THE 9" MIN. x 48", OR 12" MAX. x 48" BARRICADE RAILS SHALL BE FABRICATED FROM 0.125" MAX. PLASTIC SHEETING AND SHALL BE ATTACHED, 4 PER RAIL, WITH 1 INCH NO. 14 PAN HEAD METAL SCREWS OR PLASTIC RIVETS. ALL CORNERS SHALL BE ROUNDED.
- 2. ORANGE AND SILVER (WHITE) STRIPES SHALL BE RETROREFLECTIVE SHEETING, ASTM D 4956 TYPE III, AS SHOWN FOR CONSTRUCTION SIGNS. ALTERNATE ORANGE AND SILVER (WHITE) STRIPES 6" WIDE SLOPING DOWNWARD AT AN ANGLE OF 45 DEGREES IN THE DIRECTION TRAFFIC IS TO PASS.
- 3. IF NECESSARY, THE SANDBAGS SHALL BE FABRICATED AND PLACED ACCORDING TO THE MANUFACTURE'S RECOMMENDATION.
- 4. THE FRAMING FOR BARRICADE PANELS SHALL BE NCHRP-350 CRASHED TESTED AND FHWA APPROVED.

BREAKAWAY BARRICADES

CD-159-1.3



M4 - 9L (LEFT)

M4 - 9R (RIGHT)

(16 S.F.)

CLOSED R9 - 9 LETTERS AND NUMERALS SHALL CONFORM TO THE CURRENT MANUAL, "STANDARD 24" x 12" (2 S.F.) ALPHABETS FOR HIGHWAY SIGNS" U.S. DEPARTMENT OF TRANSPORTATION, FEDERAL **DETOUR**

24" x 12" (2 S.F.) **DETOUR** M4 - 9X (STRAIGHT) M4 - 11

30" x 24"

DETOUR

M4 - 10L (LEFT) M4 - 10R (RIGHT)

48" x 18" (6 S.F.) (5 S.F.) 30" x 24" (5 S.F.)

PREPARED 48" x 48"

48" x 48" (16 S.F.) (16 S.F.) (16 S.F.) GROOVED PAVEMENT W20 - 1A W8 - 9a 48" x 48" 48" x 48" 48" x 48"

ROAD CLOSED THRU TRAFFIC 60" x 30" (12.5 S.F.) END ROAD WORK

G20 - 2A

48" x 24" (8 S.F.)

TO STOP

(16 S.F.)

(L OR R) W1-6

48" x 24" (8 S.F.)

CONSTRUCTION SIGNS

NOT TO SCALE

(16 S.F.)

BREAKAWAY BARRICADES WITH W1-6L (TYP) Note: Use W1-6R when Constructing Other Side of Street

1500'


1000'

_ MILES AHEAD

AHEAD

TRAFFIC CONTROL FOR MILLING AND OVERLAY

NOT TO SCALE

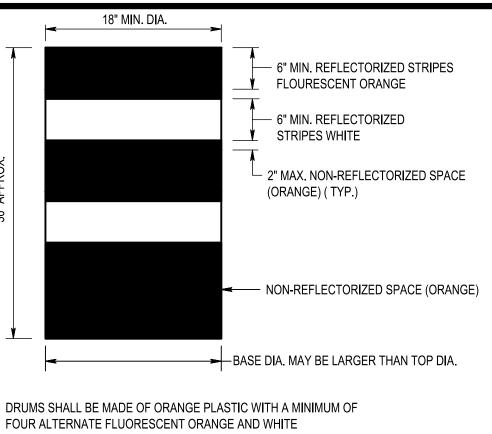

RETROREFLECTIVE STRIPES. IF THERE ARE NON-REFLECTORIZED SPACES BETWEEN THE STRIPES, THEY SHALL BE NO MORE THAN 2" WIDE. RETROREFLECTIVE SHEETING FOR STRIPES SHALL CONFORM WITH ASTM D 4956 TYPE VII OR VIII WITH S2 REQUIREMENTS.

THE TOP OF THE DRUM SHALL NOT BE OPEN. DRUMS SHALL BE CONSTRUCTED TO INHIBIT ROLLING IF KNOCKED OVER.

THE REFLECTORIZED AREA OF DRUMS SHALL BE ROUND EXCEPT THAT OTHER SHAPES. WHICH PROVIDE THE SAME VISIBILITY AS AN 18 INCH DIAMETER ROUND DRUM REGARDLESS OF ORIENTATION, MAY BE USED.

WHEN BALLAST IS REQUIRED BY THE R.E., SAND SHALL BE USED. THE MAXIMUM WEIGHT OF THE BALLAST SHALL BE 50 LBS. AND BE LOCATED APPROXIMATELY AT GROUND LEVEL.

DRUMS

ALTERNATE TYPES OF BALLAST SHALL BE APPROVED BY THE R.E..

NOT TO SCALE CD-159-1.1 1 3/4" MIN. O.D. - 3" TO 4" SPACE FOR HANDLING. 6" SILVER (WHITE) RETROREFLECTIVE SHEETING, ASTM D-4956 TYPE II - 2" SPACE 4" SILVER (WHITE) RETROREFLECTIVE SHEETING, ASTM D-4956 TYPE I PLASTIC OR RUBBER, MIN. WEIGHT 7 LBS. → 7 1/2" MIN. O.D.

EVERETT PARK 1. TRAFFIC CONES SHALL BE PREDOMINATELY ORANGE IN COLOR. **IMPROVEMENTS**

BLOCK 707 - LOT 10 **TRAFFIC CONES** TOWNSHIP OF VERONA COUNTY OF ESSEX

GENERAL NOTES MAINTENANCE AND PROTECTION OF TRAFFIC

CD-159-1.2

2. BASES MAY BE OF BREAKAWAY BALLASTED TYPE.

APPROVAL OF THE ENGINEER.

3. MINOR MANUFACTURER'S VARIATIONS MAY BE ACCEPTABLE UPON

1. All devices and procedures for the maintenance and protection of traffic shall be in accordance with the "Manual on Uniform Traffic Control Devices" for streets and highways. The contractor shall plan and carry out his work to provide for the convenient and safe passage of all vehicular and pedestrian traffic.

NOTES:

- 2. Contractor to develop detailed maintenance and protection of traffic plan for review by the engineer prior to construction. 3. The contractor shall follow the recommended traffic control procedures. If the contractor desires to change the procedure, he shall present his changes in writing to the engineer for review There may be utility relocations, adjustments and improvements which are necessitated by the proposed construction. The contractor shall coordinate his work with each of the utility companies located within the project limits.
- 4. The contractor is responsible for providing maintenance and protection of traffic throughout the duration of construction. The costs for the individual devices used to maintain and protect traffic shall be included in the lump sum price bid for maintenance and protection of traffic. No separate payments will be made for relocating
- The contractor will not be permitted to close down the entire street. The contractor shall provide means of access at all times for pedestrians and vehicular traffic at all the devices as required, or as directed by The municipality, during the course of construction. private driveways and occupied buildings affected by the work of this contract. During construction, in the vicinity of a driveway, the access width at the driveway
- 6. The contractor shall maintain at least one lane of traffic at all times. entrance shall be plainly marked by lights, barricades or
- other such devices approved by the municipality.
- During construction, all roads shall be properly maintained to accommodate emergency vehicles at all times.
- All barricades shall be Type III breakaway barricades.
- Fill material for escape ramps shall be on-site material. All costs for storing, placing, moving and removing fillet material shall be included in the price bid for the various items in the proposal.

CONSTRUCTION

DETAILS I

YNDHURST PARK AVENUE, PO BOX 426

A PRODUCT OF

NEGLIA GROUP

STATE OF NEW JERSEY

ANTHONY KURUS, PE, PP

PROFESSIONAL ENGINEER
N.J. LICENSE NO. 24GE04644500
PROFESSIONAL PLANNER
N.J. LICENSE NO. 33LI00614500


MATEO F. LUZURIAGA, PE


PROFESSIONAL ENGINEER


N.J. LICENSE NO. 24GE06029800

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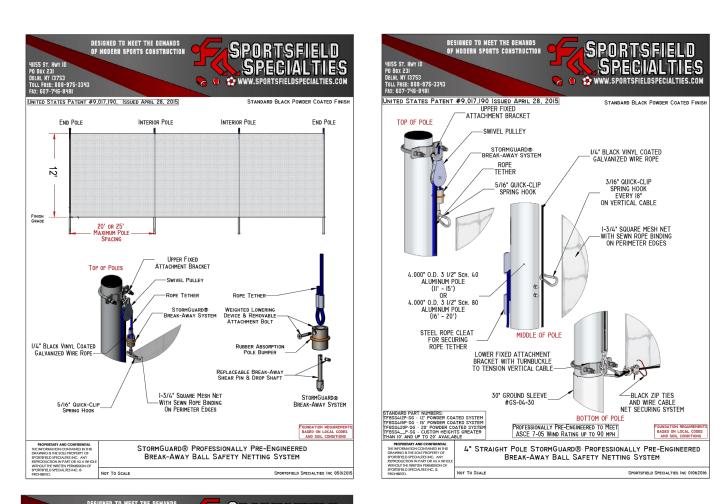
DRAWN BY: M.F.L. SCALE: N.T.S. CHECKED BY: A.K. DESIGNED BY: M.F.L. 10.00 DATE: NOVEMBER 2024




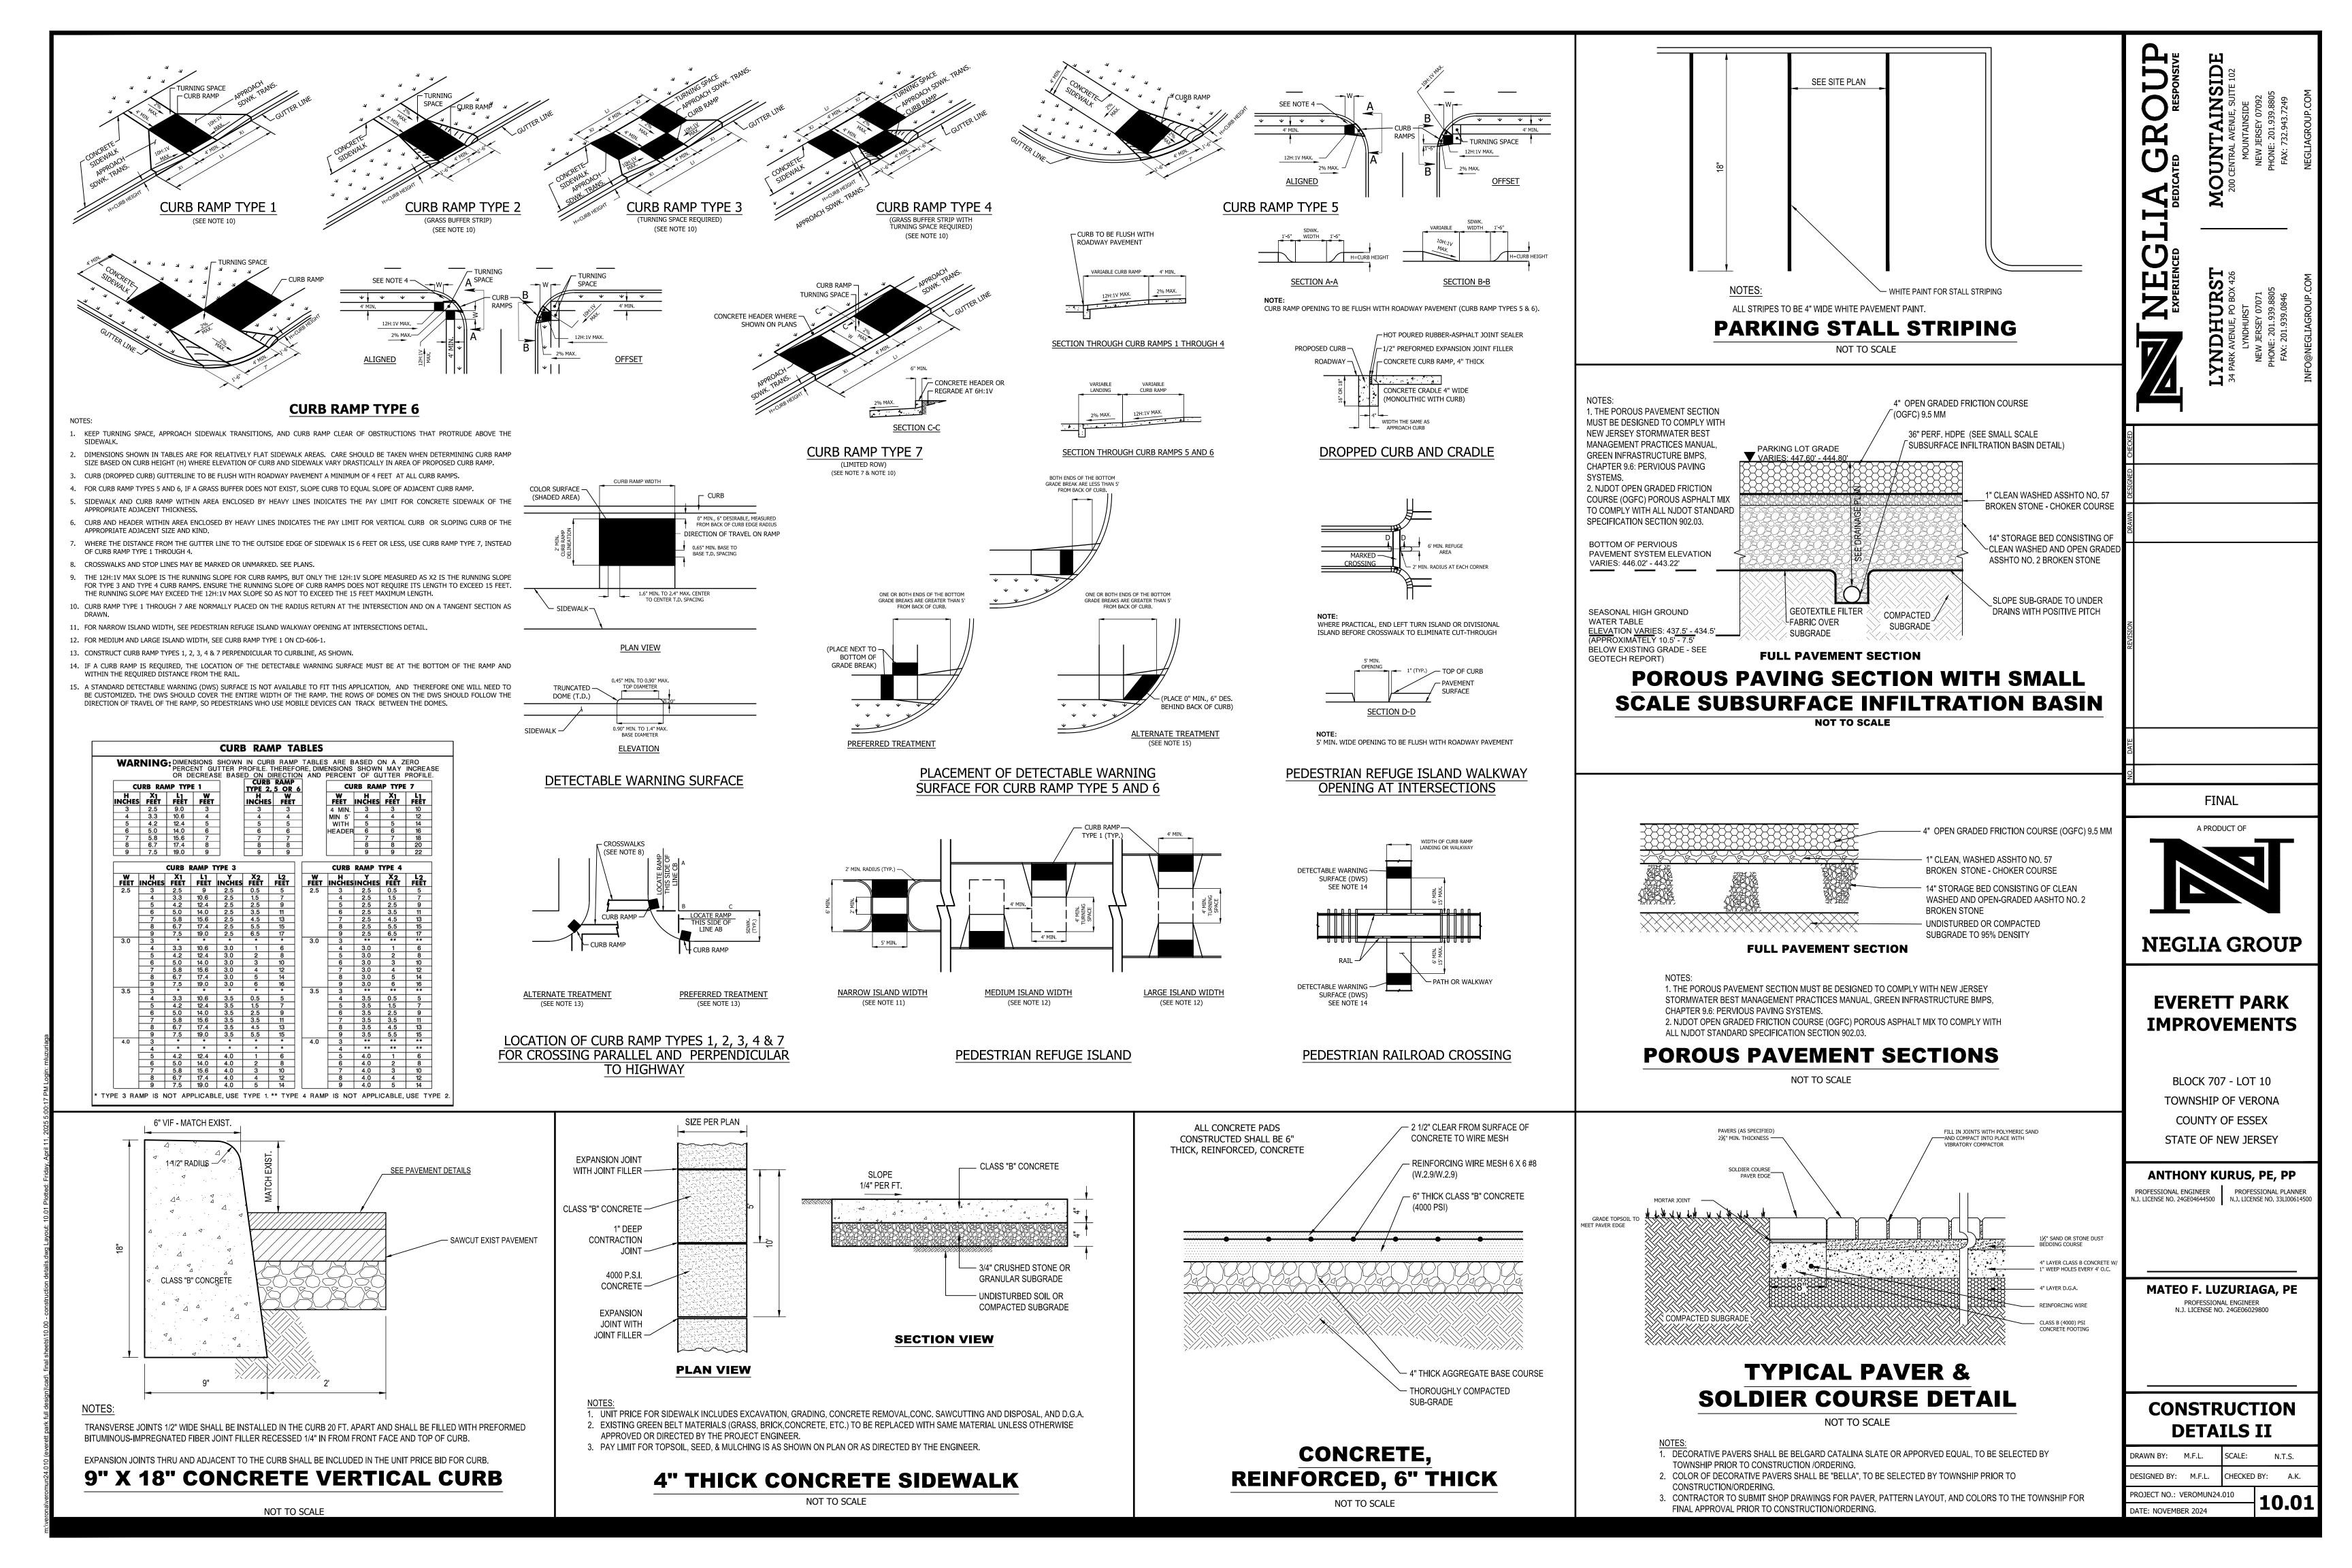

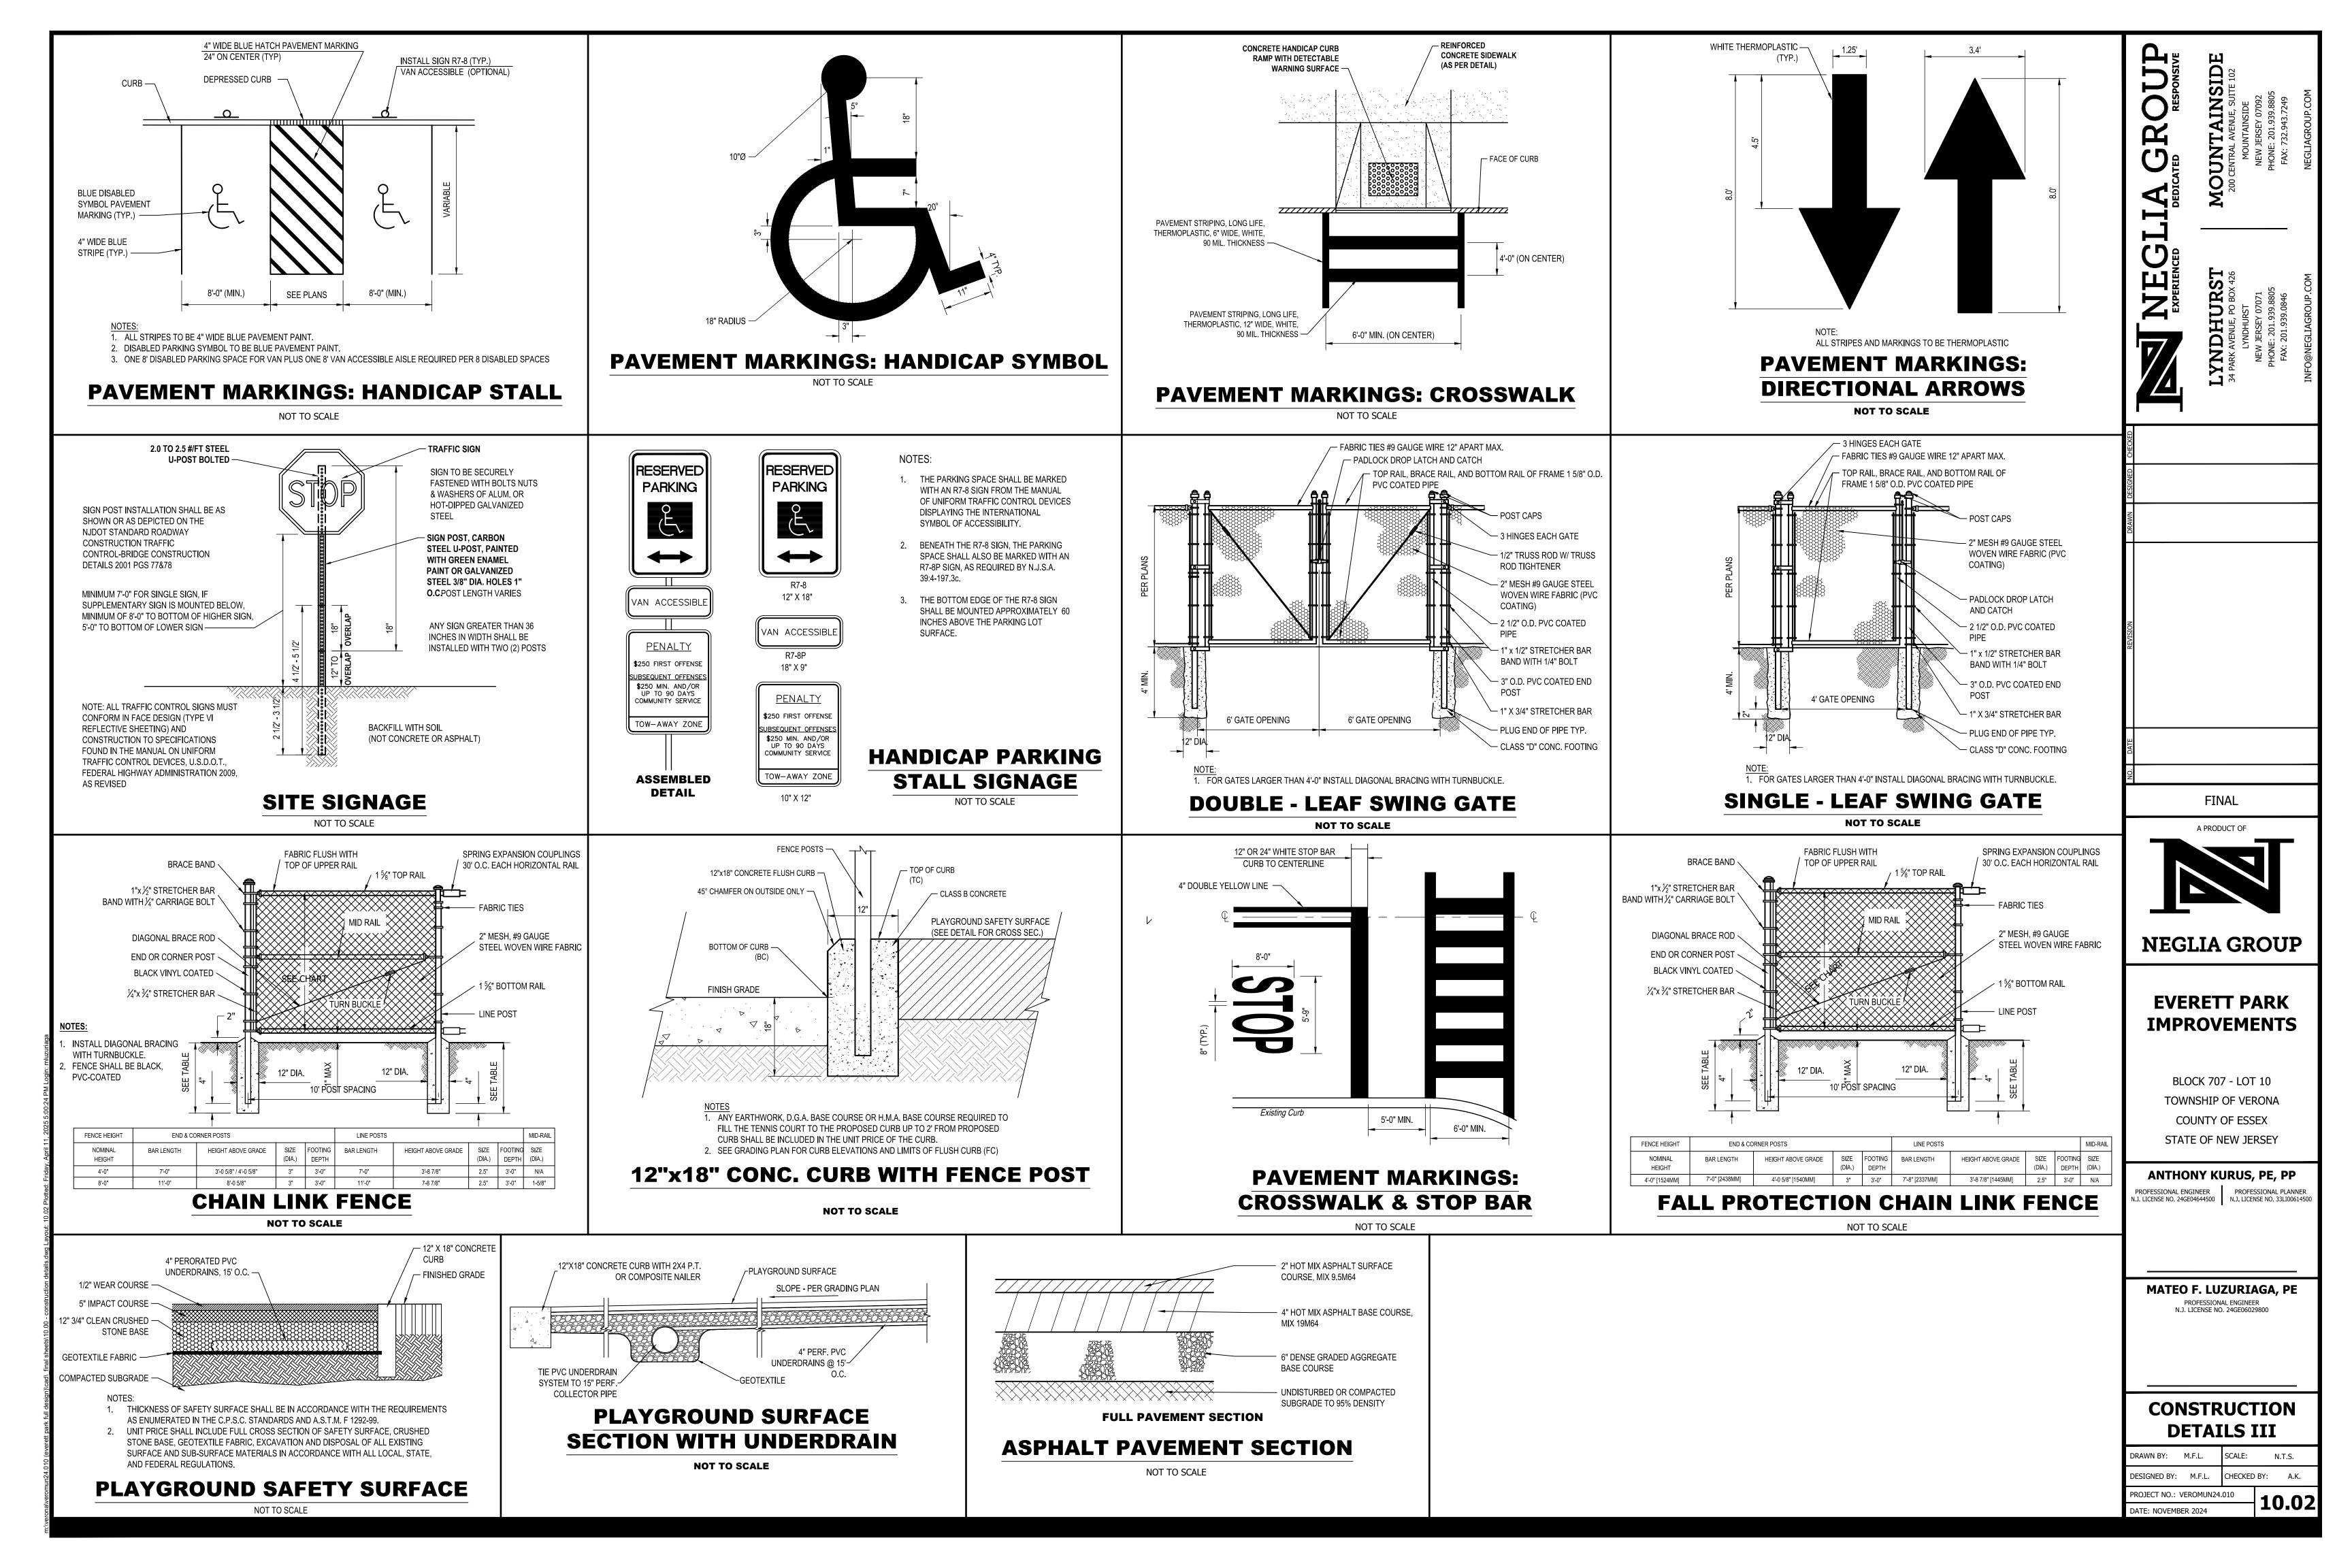

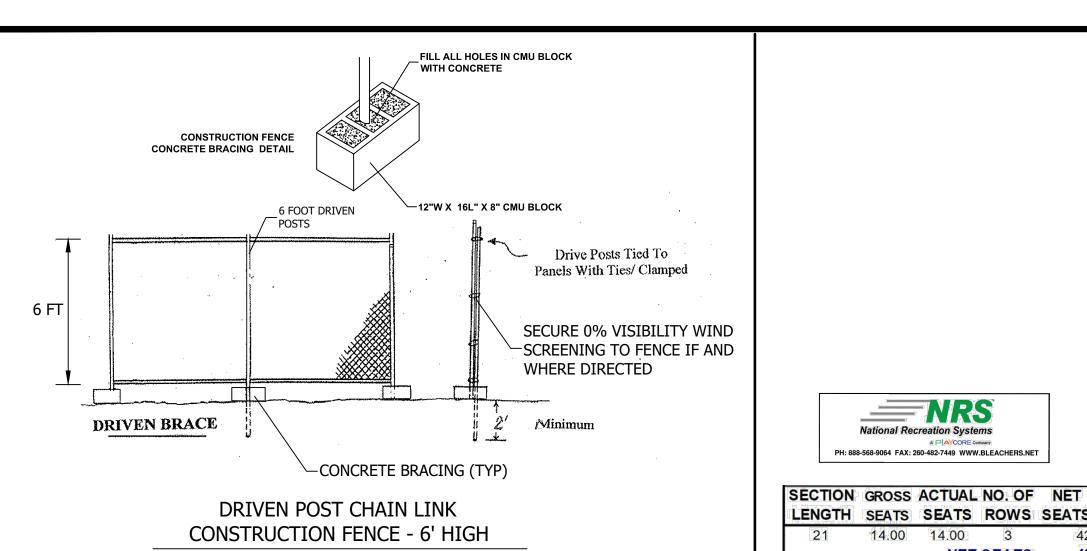- NOT TO SCALE
- 1. TEMPORARY CONSTRUCTION FENCE SHALL BE 6' HIGH WITH DRIVEN POSTS AS SHOWN OR
- FENCE SHALL BE INSTALLED WITH 0% VISIBILTY WIND SCREENING AS SHOWN OR APPROVED
- CONCRETE BRACING SHALL BE AS SHOWN OR APPROVED EQUAL
- SHOP DRAWINGS SHALL BE PROVIDED PRIOR TO CONSTRUCTION. SECURE GATED ACCESS SHALL BE PROVIDED.
- 5. LOCATION OF FENCING IS APPROXIMATE AND SHALL BE APPROVED BY TOWNSHIP AND ENGINEER



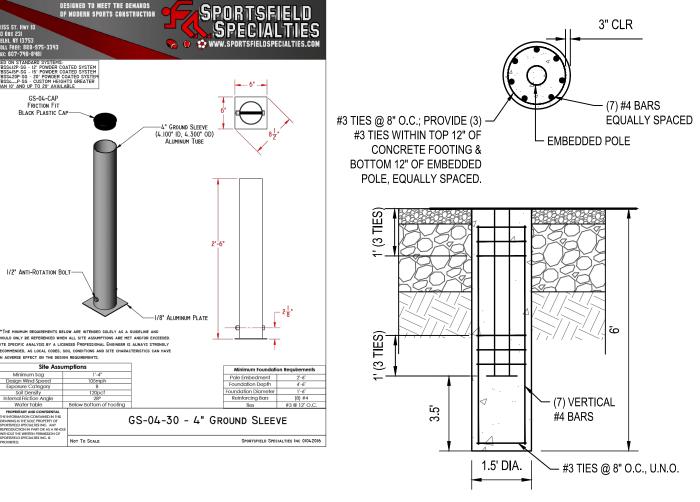


- 1. NETTING SYSTEM SHALL BE MODEL #TFBSS420P-SG-20' POWDER COATED SYSTEM AS MANUFACTURED BY:
- SPORTSFIELD SPECIALTIES, DELHI, NEW YORK, 13753, OR APPROVED EQUAL. 2. SEE CHAIN-LINK FENCE HEIGHTS ON FENCING PLAN FOR ONE COMPLETE SYSTEM.
- 3. CONCRETE FOOTING SHALL MEET 28-DAY STRENGTH OF 4,000 PSI.


ATHLETIC FIELD NETTING SYSTEM

NOT TO SCALE


BLEACHER TOP VIEW

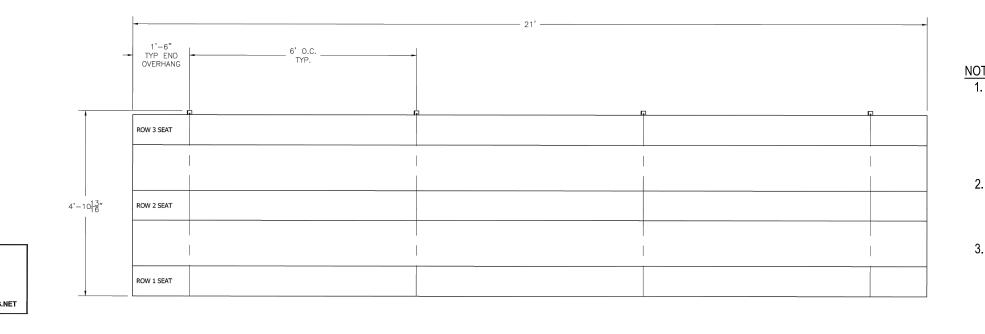

BLEACHERS (21' LONG, 3 ROWS) DETAILS

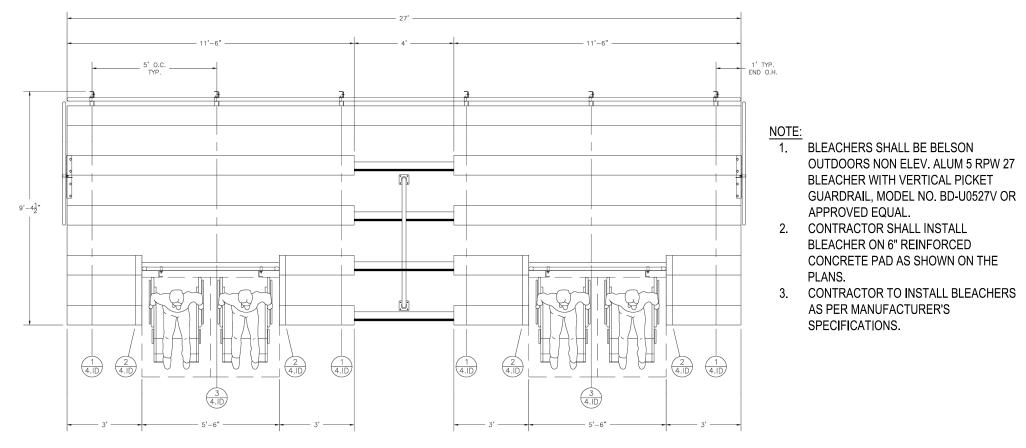

ADA ACCESSIBLE BLEACHERS (27' LONG, 5 ROWS) DETAILS

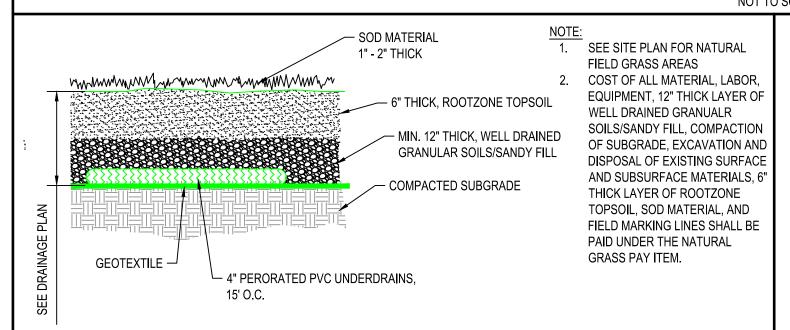

NRS

National Recreation Systems

14.00 14.00

TOTAL NET SEATING CAPACITY

(BASED ON 18" PER SEAT)

SECTION GROSS ACTUAL NO. OF NET

LENGTH SEATS SEATS ROWS SEATS

2.00

7.00

2.00

WHEELCHAIR SPACES

TOTAL NET SEATING CAPACITY

NET SEATS

2.00

7.67


2.00

11.5

WHEELCHAIR SPACES


NET SEATS

NATURAL GRASS FIELD SECTION WITH UNDERDRAINS

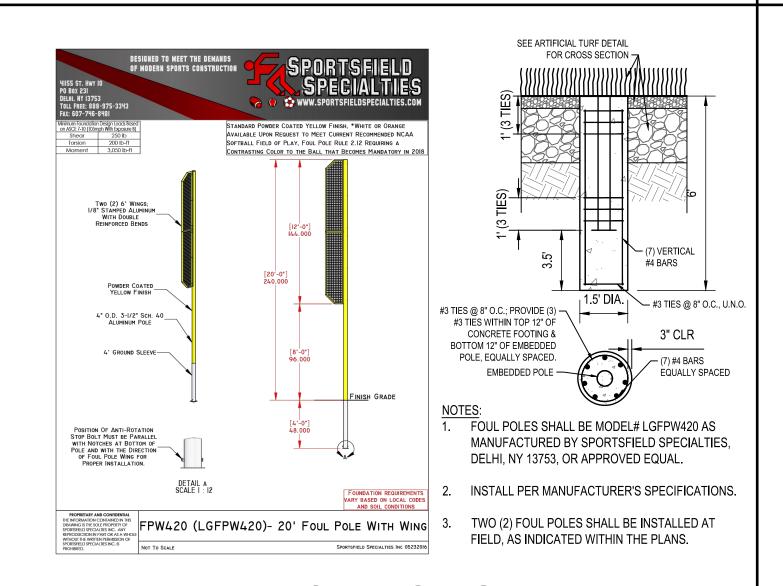

FOUL POLES

NOT TO SCALE

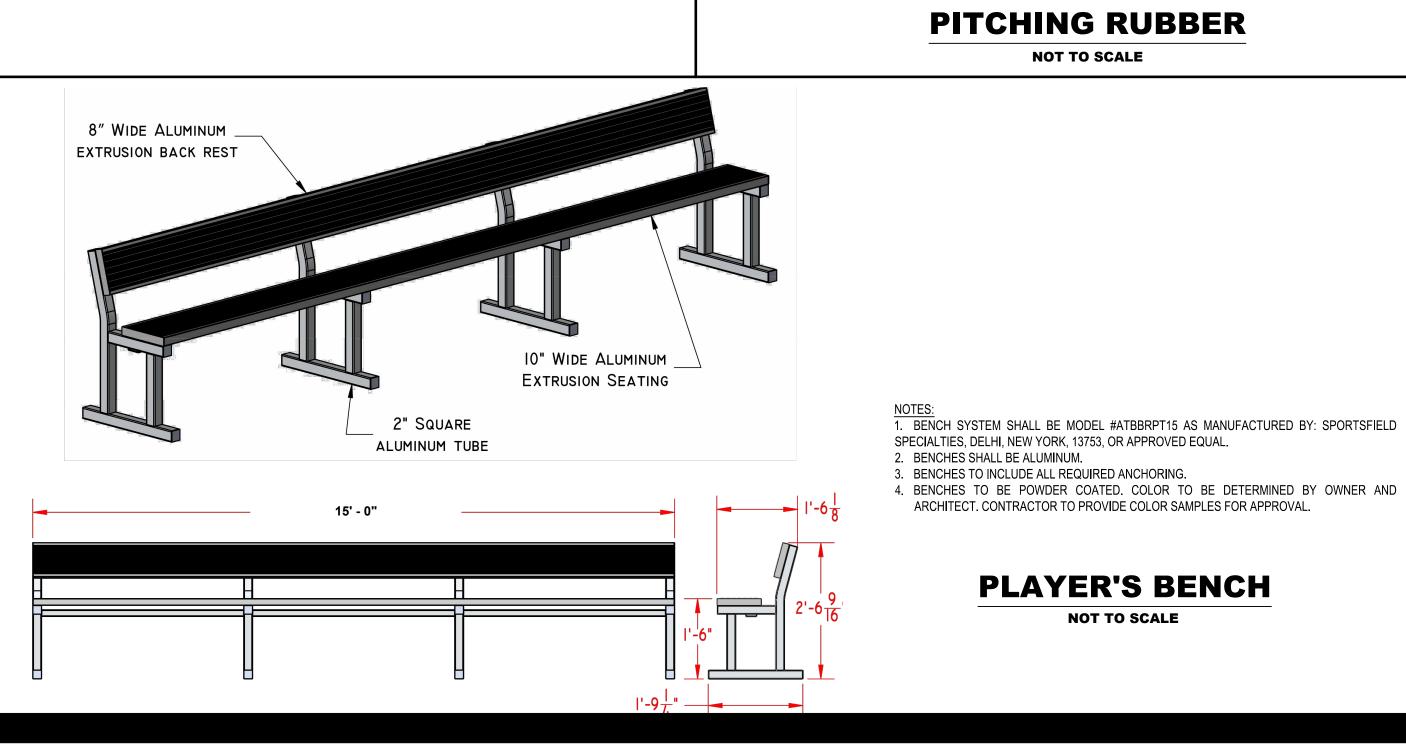

BLEACHERS SHALL BE NATIONAL RECREATION SYSTEM NON

ELEVATED 3 ROW X 21'

BLEACHER, MODEL NO. NB0321APRF OR APPROVED

THE PLANS.

CONTRACTOR SHALL INSTALL


CONTRACTOR TO INSTALL

BLEACHERS AS PER

MANUFACTURER'S

SPECIFICATIONS.


BLEACHER ON 6" REINFORCED CONCRETE PAD AS SHOWN ON

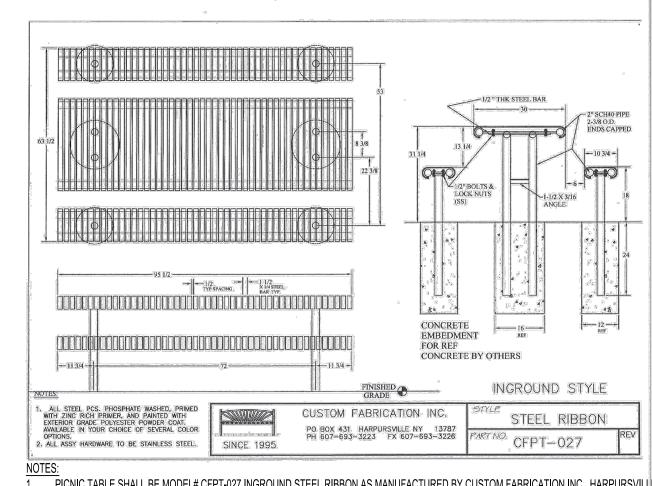

CONCRETE FOOTINGS SHALL BE CLASS B CONCRETE. COST CONCRETE FOOTING SHALL BE INCLUDED IN THE UNIT PRICE FOR THE PICNIC TABLE

STANDARD PICNIC TABLE DETAIL


NOT TO SCALE

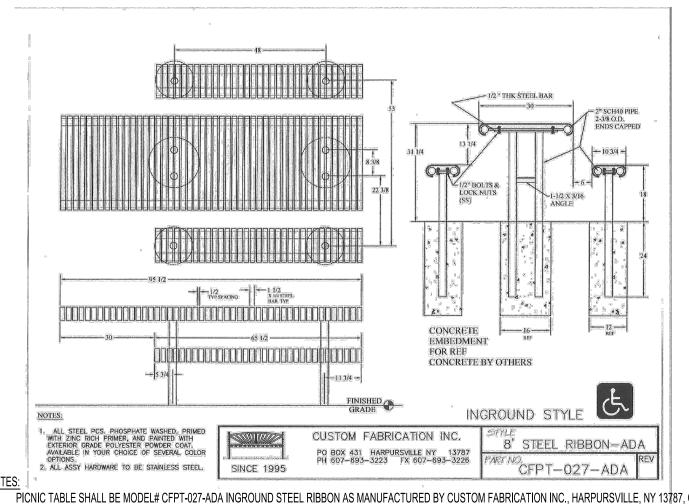

CONCRETE FOOTINGS SHALL BE CLASS B CONCRETE. COST CONCRETE FOOTING SHALL BE INCLUDED IN THE UNIT PRICE FOR THE PICNIC TABLE. COLOR SHALL BE PINE GREEN AND SHOP DRAWINGS ARE TO BE SUBMITTED TO ENGINEER FOR REVIEW AND APPROVAL PRIOR TO CONSTRUCTION.

ADA PICNIC TABLE DETAIL

NOT TO SCALE

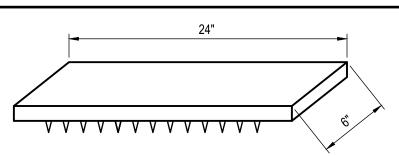

PITCHING RUBBER MODEL TO BE SELECTED PRIOR TO INSTALLTION

PITCHING RUBBER

NOT TO SCALE

1. BENCH SYSTEM SHALL BE MODEL #ATBBRPT15 AS MANUFACTURED BY: SPORTSFIELD

ARCHITECT. CONTRACTOR TO PROVIDE COLOR SAMPLES FOR APPROVAL.

PLAYER'S BENCH

NOT TO SCALE

SPECIALTIES, DELHI, NEW YORK, 13753, OR APPROVED EQUAL.

COUNTY OF ESSEX STATE OF NEW JERSEY

ANTHONY KURUS, PE, PP

FINAL

A PRODUCT OF

NEGLIA GROUP

EVERETT PARK

IMPROVEMENTS

BLOCK 707 - LOT 10

TOWNSHIP OF VERONA

MOUNTAINSIDE 200 CENTRAL AVENUE, SUITE 102

LYNDHURST
34 PARK AVENUE, PO BOX 426

HZ Z

PROFESSIONAL ENGINEER
N.J. LICENSE NO. 24GE04644500
PROFESSIONAL PLANNER
N.J. LICENSE NO. 33L10061450


MATEO F. LUZURIAGA, PE PROFESSIONAL ENGINEER N.J. LICENSE NO. 24GE06029800


CONSTRUCTION

DRAWN BY: M.F.L. SCALE: N.T.S. DESIGNED BY: M.F.L. CHECKED BY: A.K. PROJECT NO.: VEROMUN24.010

DETAILS IV

DATE: NOVEMBER 2024

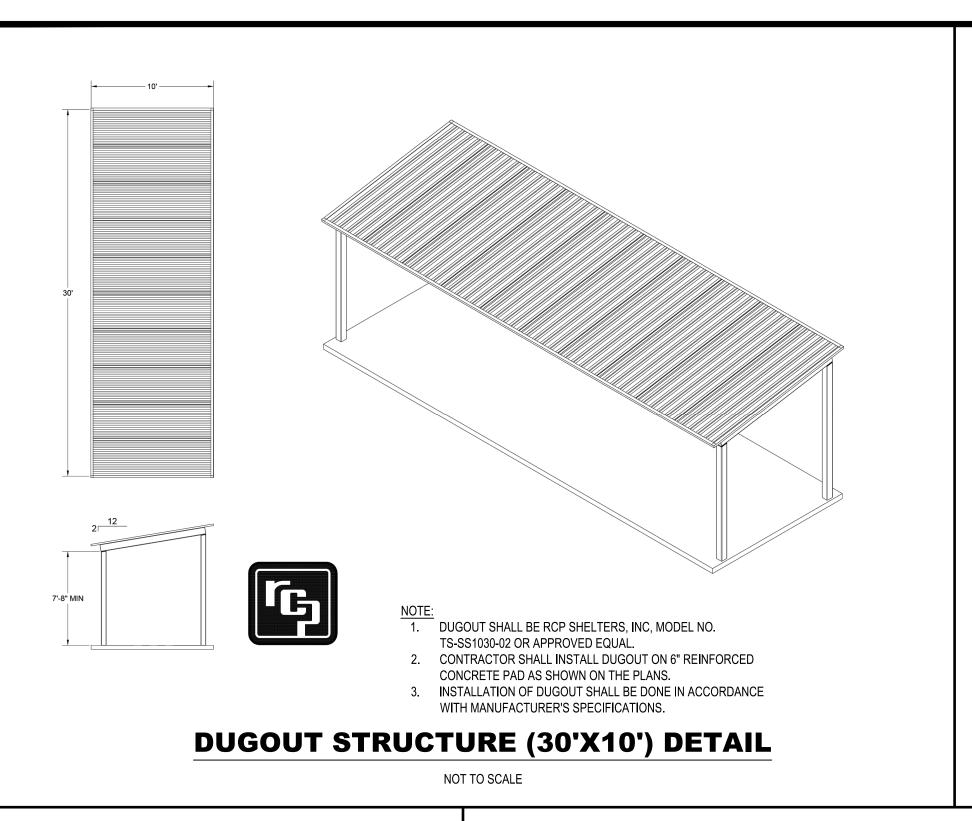

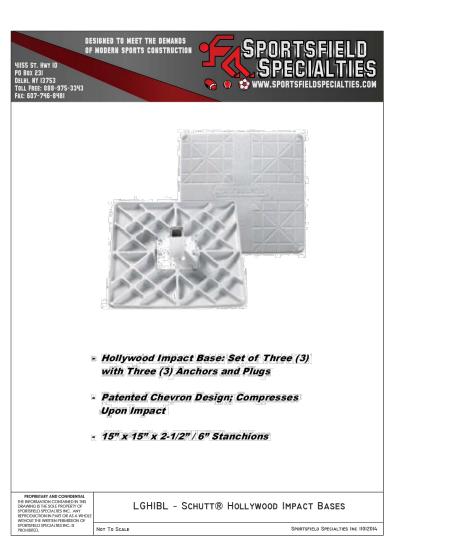

· Official Size Hollywood MLB® Universal Pro Style Home Plate with Seven Inch (7") Stanchion with

and Five (5) Zinc-Plated Mounting Spikes

· Permanent or Removable Installations

· High Durability Molded Rubber Construction

UNIVERSAL PRO STYLE HOME PLATE

• 1½" Thick


• 18 lb. Shipping Weight

INSTALL PER MANUFACTURER'S SPECIFICATIONS.

HOMEPLATE

- HOMEPLATES SHALL BE MODEL# LGSHP-UM SCHUTT HOLLYWOOD UNIVERSAL 1. BASES SHALL BE MODEL# LGHIBL - SCHUTT HOLLYWOOD IMPACT BASES PRO STYLE HOMEPLATE AS MANUFACTURED BY SPORTSFIELD SPECIALTIES, AS MANUFACTURED BY SPORTSFIELD SPECIALTIES, DELHI, NY, 13753, OR DELHI, NY, 13753, OR APPROVED EQUAL. APPROVED EQUAL.
 - 2. INSTALL PER MANUFACTURER'S SPECIFICATIONS.
 - 3. THE BASEBALL FIELD SHALL BE EQUIPPED WITH THREE (3) BASES COMPLIANT WITH NATIONAL LITTLE LEAGUE REQUIREMENTS.

BASES

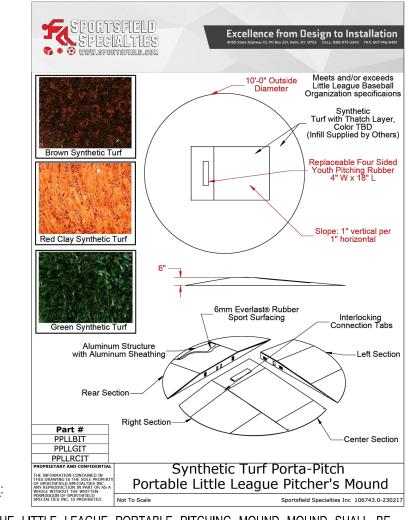

 $-\frac{1}{4}$ " Cable between center end

PLAN VIEW

POSTS TO SUPPORT 2" NYLON


-8' HIGH X 4' WIDE MAIN


GATE LOCATION

(SEE SITE PLAN FOR LOCATION OF GATES)

- 1. THE LITTLE LEAGUE PORTABLE PITCHING MOUND MOUND SHALL BE MODEL# PPLLGIT - SYNTHETIC TURF PORTAPITCH PORTABLE LITTLE LEAGUE PITCHER'S MOUND AS MANUFACTURED BY SPORTSFIELD SPECIALTIES, DELHI, NY, 13753, OR APPROVED EQUAL.
- 2. INSTALL PER MANUFACTURER'S SPECIFICATIONS.
- 3. THE COLOR OF THE PITCHING MOUND SHALL BE BROWN AND SHOP DRAWINGS SHALL BE PROVIDED TO TOWNSHIP AND ENGINEER FOR FINAL APPROVAL PRIOR TO CONSTRUCTION.

LITTLE LEAGUE PORTABLE **PITCHING MOUND**

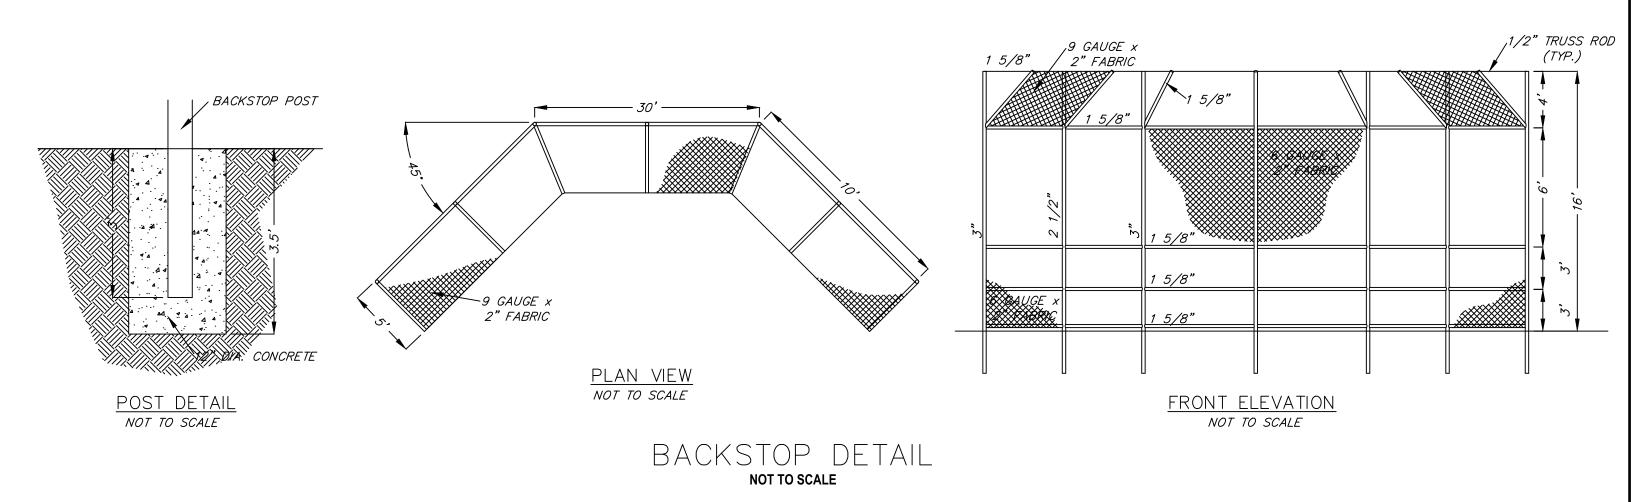

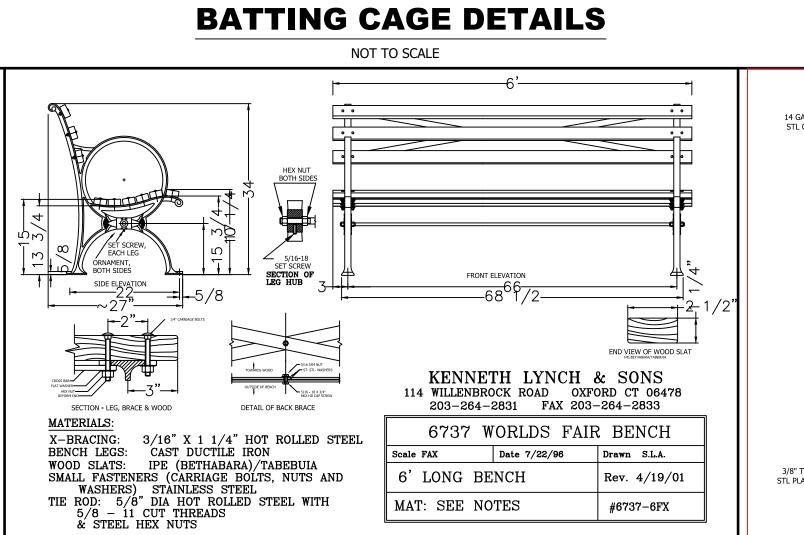

 $\sqrt{\frac{1}{4}}$ " CABLE BETWEEN CENTER END

POSTS TO SUPPORT 2" NYLON

(CENTER END POSTS TO BE 10'

1. HOMEPLATES SHALL BE MODEL# LGSHP-UM - SCHUTT HOLLYWOOD UNIVERSAL PRO STYLE HOMEPLATE AS MANUFACTURED BY SPORTSFIELD SPECIALTIES, DELHI, NY, 13753, OR APPROVED EQUAL

BLACK VINYL COATED CHAIN LINK-

FENCE WITH BLACK POWDER

COATED POSTS

~2" NETTING SYSTEM TO BE PROVIDED

PROTECT PLAYERS FROM BALL

FENCE POSTS @ 10' C-C

WITHIN THE INTERIOR FENCE LIMITS TO


DEFLECTIONS ON TOP AND ALL SIDES OF

1. 6' PARK BENCH SHALL BE AS SHOWN OR EQUAL TO BE APPROVED BY TOWNSHIP & ENGINEER.

- 2. COLOR OF FRAME TO BE BLACK AND WOOD SLATS COLOR TO BE CEDAR. FINAL COLOR SELECTION TO BE APPROVED BY
- TOWNSHIP PRIOR TO PURCHASING.
- 3. PARK BENCH SHALL BE INSTALLED WITH PERMANENT MOUNTING HARDWARE ACCORDING TO MANUFACTURER'S SPECIFICATION. 4. SEE SITE PLAN FOR LOCATIONS.

PARK BENCH

NOT TO SCALE

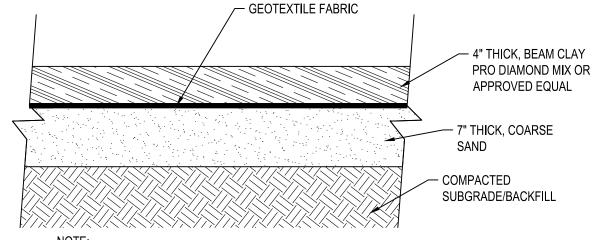


SEE SITE PLAN FOR AREAS WITH CLAY SURFACE

- CLAY SURFACE SHALL BE A MINIMUM OF 4" THICK CLAY SURFACE SHALL BE BEAM CLAY PRO DIAMOND MIX OR APPROVED EQUAL
- BY TOWNSHIP AND ENGINEER. SHOP DRAWINGS TO PROVIDED.
- 4. COLOR OF CLAY SURFACE SHALL BE RED. FINAL COLOR SELECTION SHALL BE APPROVED BY TOWNSHIP AND ENGINEER PRIOR TO PURCHASING.
- 5. COST OF ALL MATERIAL, LABOR, EQUIPMENT, 7" THICK LAYER OF COARSE SAND, EXCAVATION AND DISPOSAL OF EXISTING SURFACE AND SUBSURFACE MATERIALS, 4" THICK CLAY, CLAY INFIELD CONDITIONER, FIELD MARKING LINES, SHALL BE PAID UNDER THE CLAY INFIELD/ON DECK SKIN AREAS COMPLETE PAY

CLAY SURFACE SECTION

NOT TO SCALE

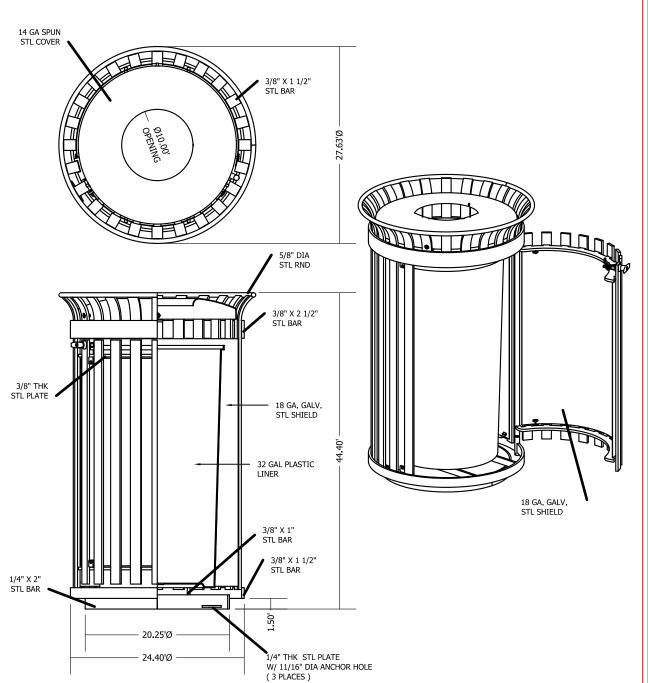

¹/₄" CABLE BETWEEN CENTER END

POSTS TO SUPPORT 2" NYLON

(CENTER END POSTS TO BE 10'

TURF SURFACE

NETTING

—CONCRETE FOOTINGS, TYP.

~2" NYLON NETTING TO EXTEND

COMPLETELY TO THE GROUND

ELEVATION VIEW

TRASH AND RECYCLE RECEPTACLES

438-32SH

W/ CVB-20-FTO

NOT TO SCALE

1.) ALL STL. MEMBERS COATED W/ ZINC RICH EPOXY THEN FINISHED

W/ POLYESTER POWDER COATING.

DuMar, inc.

2.) 1/2" X 3 3/4" EXPANSION ANCHOR BOLTS PROVIDED.

1. TRASH & RECYCLE RECEPTACLE SHALL BE AS SHOW OR APPROVED EQUAL BY TOWNSHIP & ENGINEER.

DATE REV.: 11/09/20

- 2. TRASH RECEPTACLE AND RECYCLE RECEPTACLE COLORS SHALL BE BLACK OR APPROVED BY TOWNSHIP & ENGINEER. 3. RECYCLE RECEPTACLE SHALL BE RETROFITTED WITH DUMOR INC., RC-RECYCLED LID AS SHOW OR APPROVED EQUAL. COLOR TO BE
- SELECTED BY TOWNSHIP & ENGINEER.
- 4. TRASH AND RECYCLE RECEPTACLE SHALL BE INSTALLED WITH PERMANENT MOUNTING HARDWARE ACCORDING TO MANUFACTURER'S
- SPECIFICATION 5. SEE SITE PLAN FOR LOCATIONS. TOWNSHIP TO CONFIRM FINAL LOCATIONS PRIOR TO INSTALLATION.

MATEO F. LUZURIAGA, PE

PROFESSIONAL ENGINEER N.J. LICENSE NO. 24GE06029800

A PRODUCT OF

NEGLIA GROUP

EVERETT PARK

IMPROVEMENTS

BLOCK 707 - LOT 10

TOWNSHIP OF VERONA

COUNTY OF ESSEX

STATE OF NEW JERSEY

ANTHONY KURUS, PE, PP


PROFESSIONAL ENGINEER
N.J. LICENSE NO. 24GE04644500


PROFESSIONAL PLANNER
N.J. LICENSE NO. 33LI00614500


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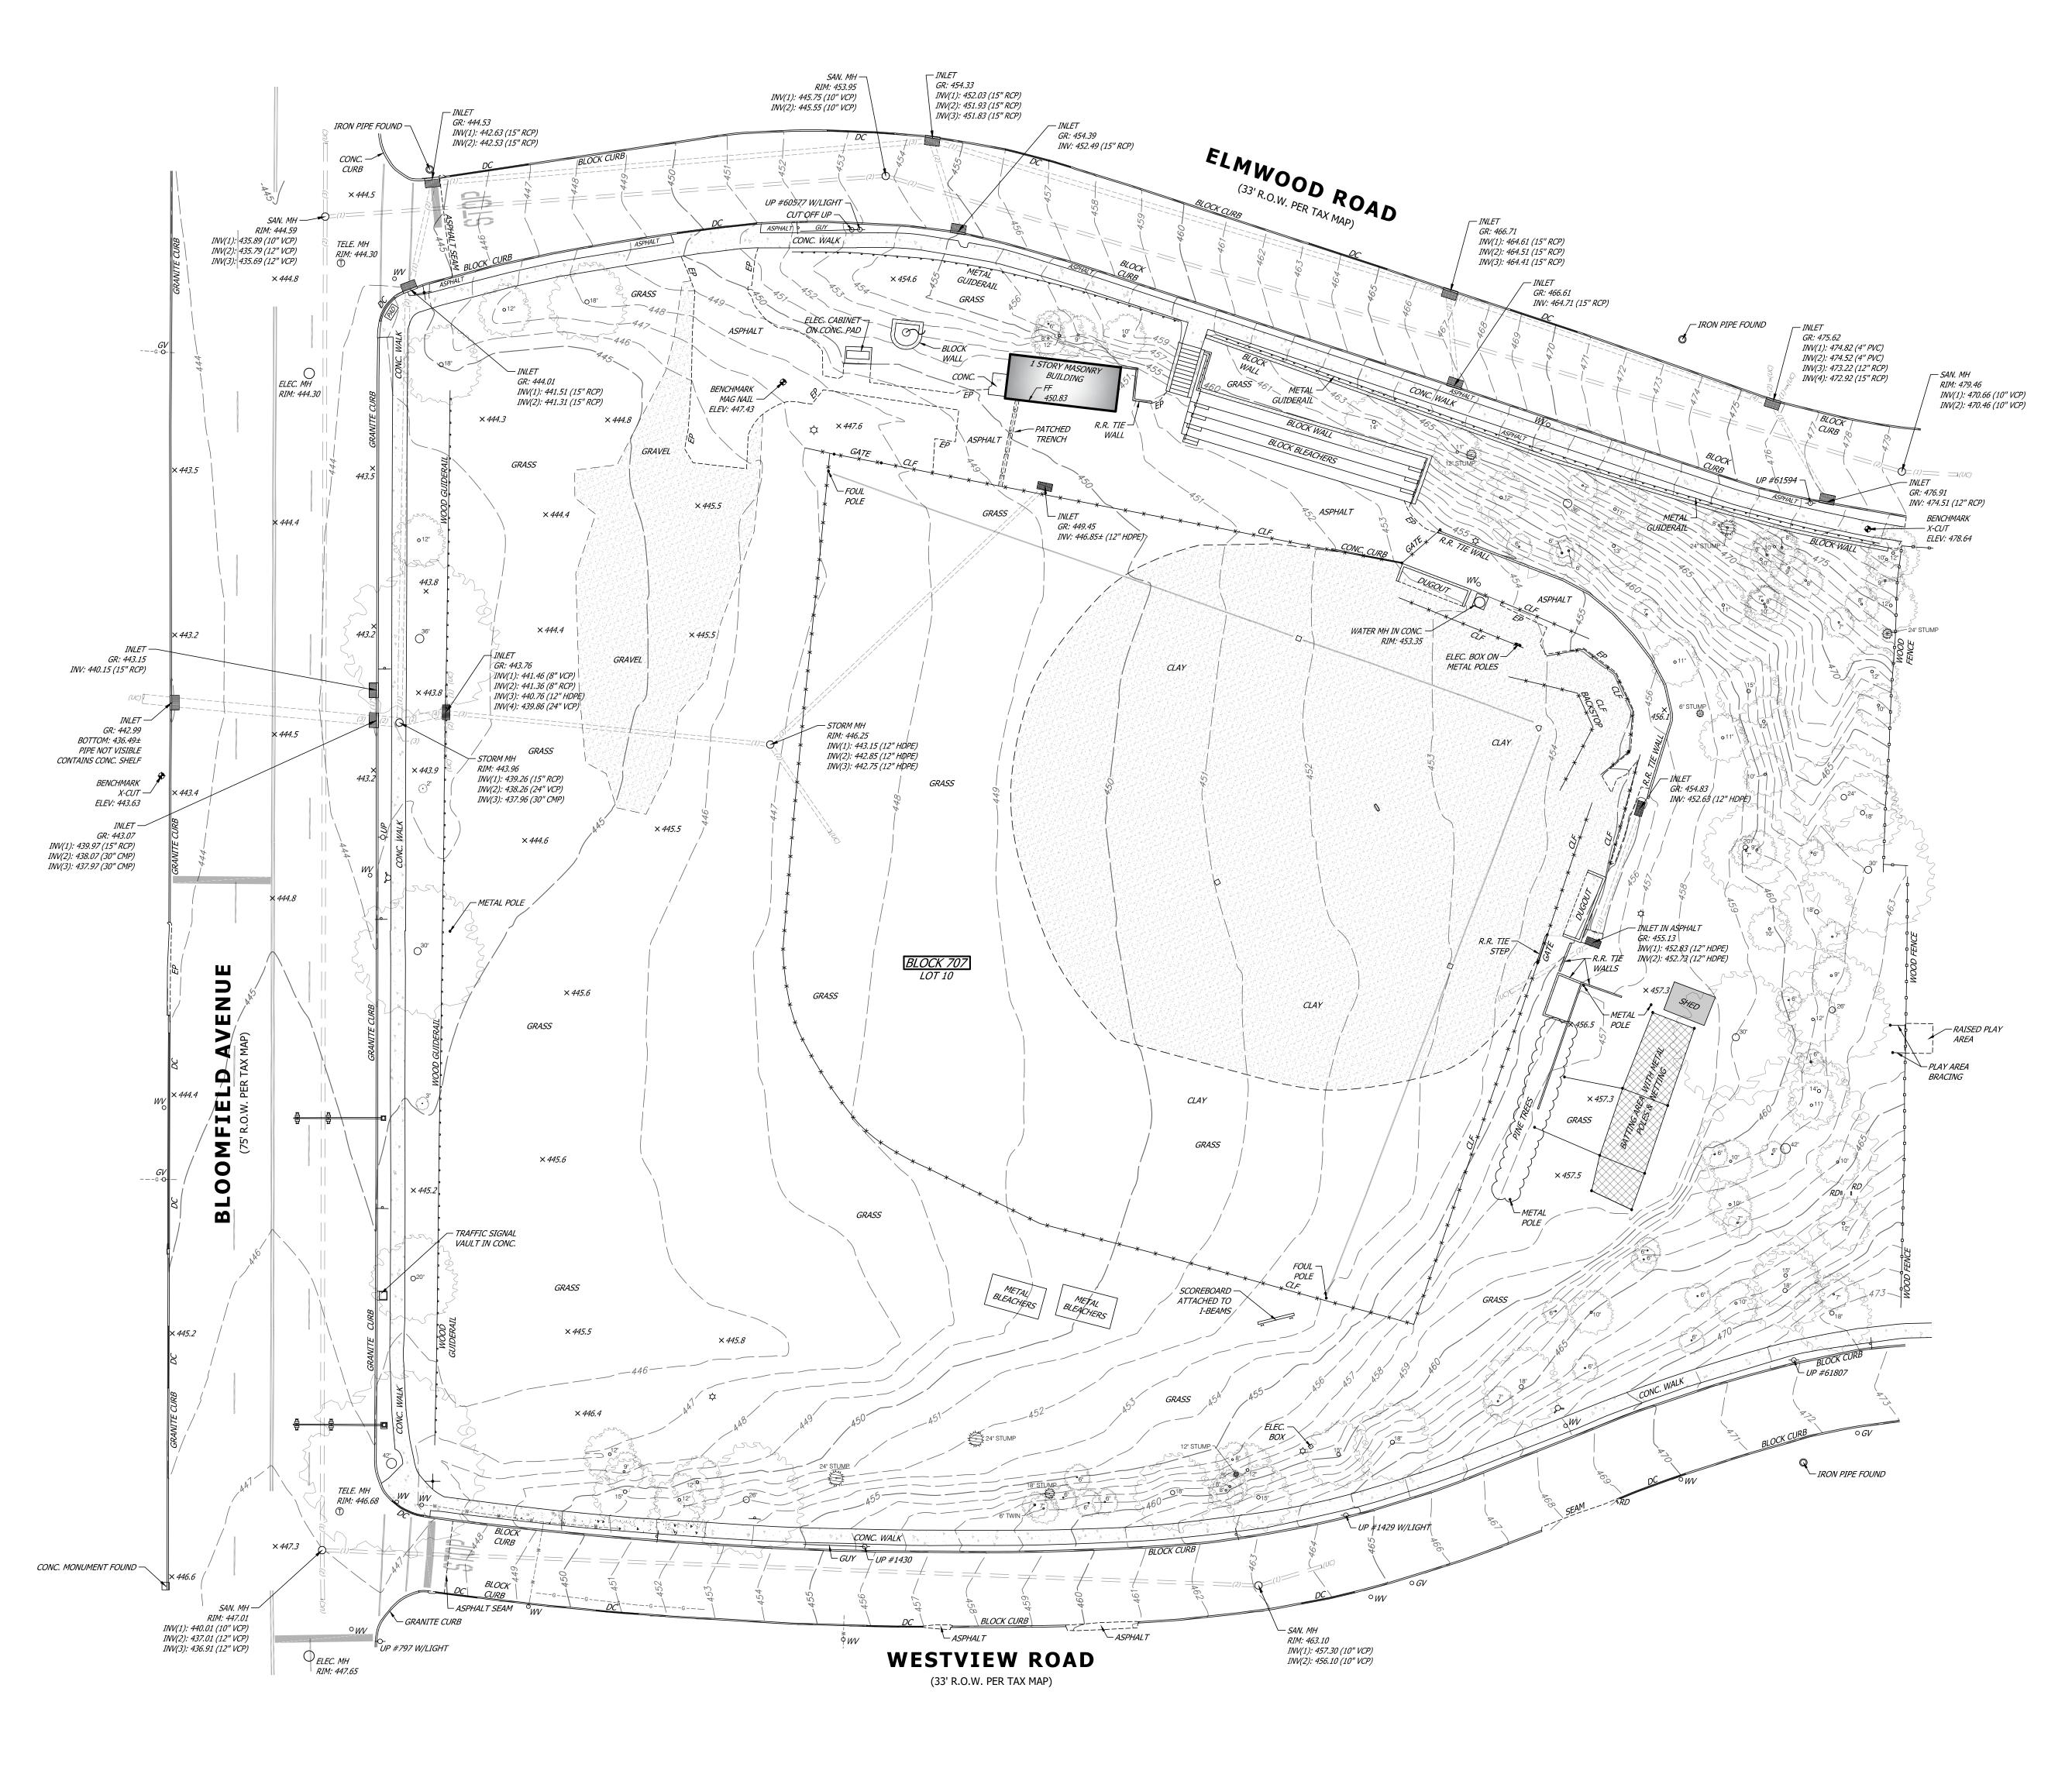
CONSTRUCTION DETAILS V

DATE: NOVEMBER 2024		10.	U4	
PROJECT NO.: VEROMUN24.	.010	10	04	
DESIGNED BY: M.F.L.	CHECKED	BY:	A.K.	
DRAWN BY: M.F.L.	SCALE:	N.T.	S.	



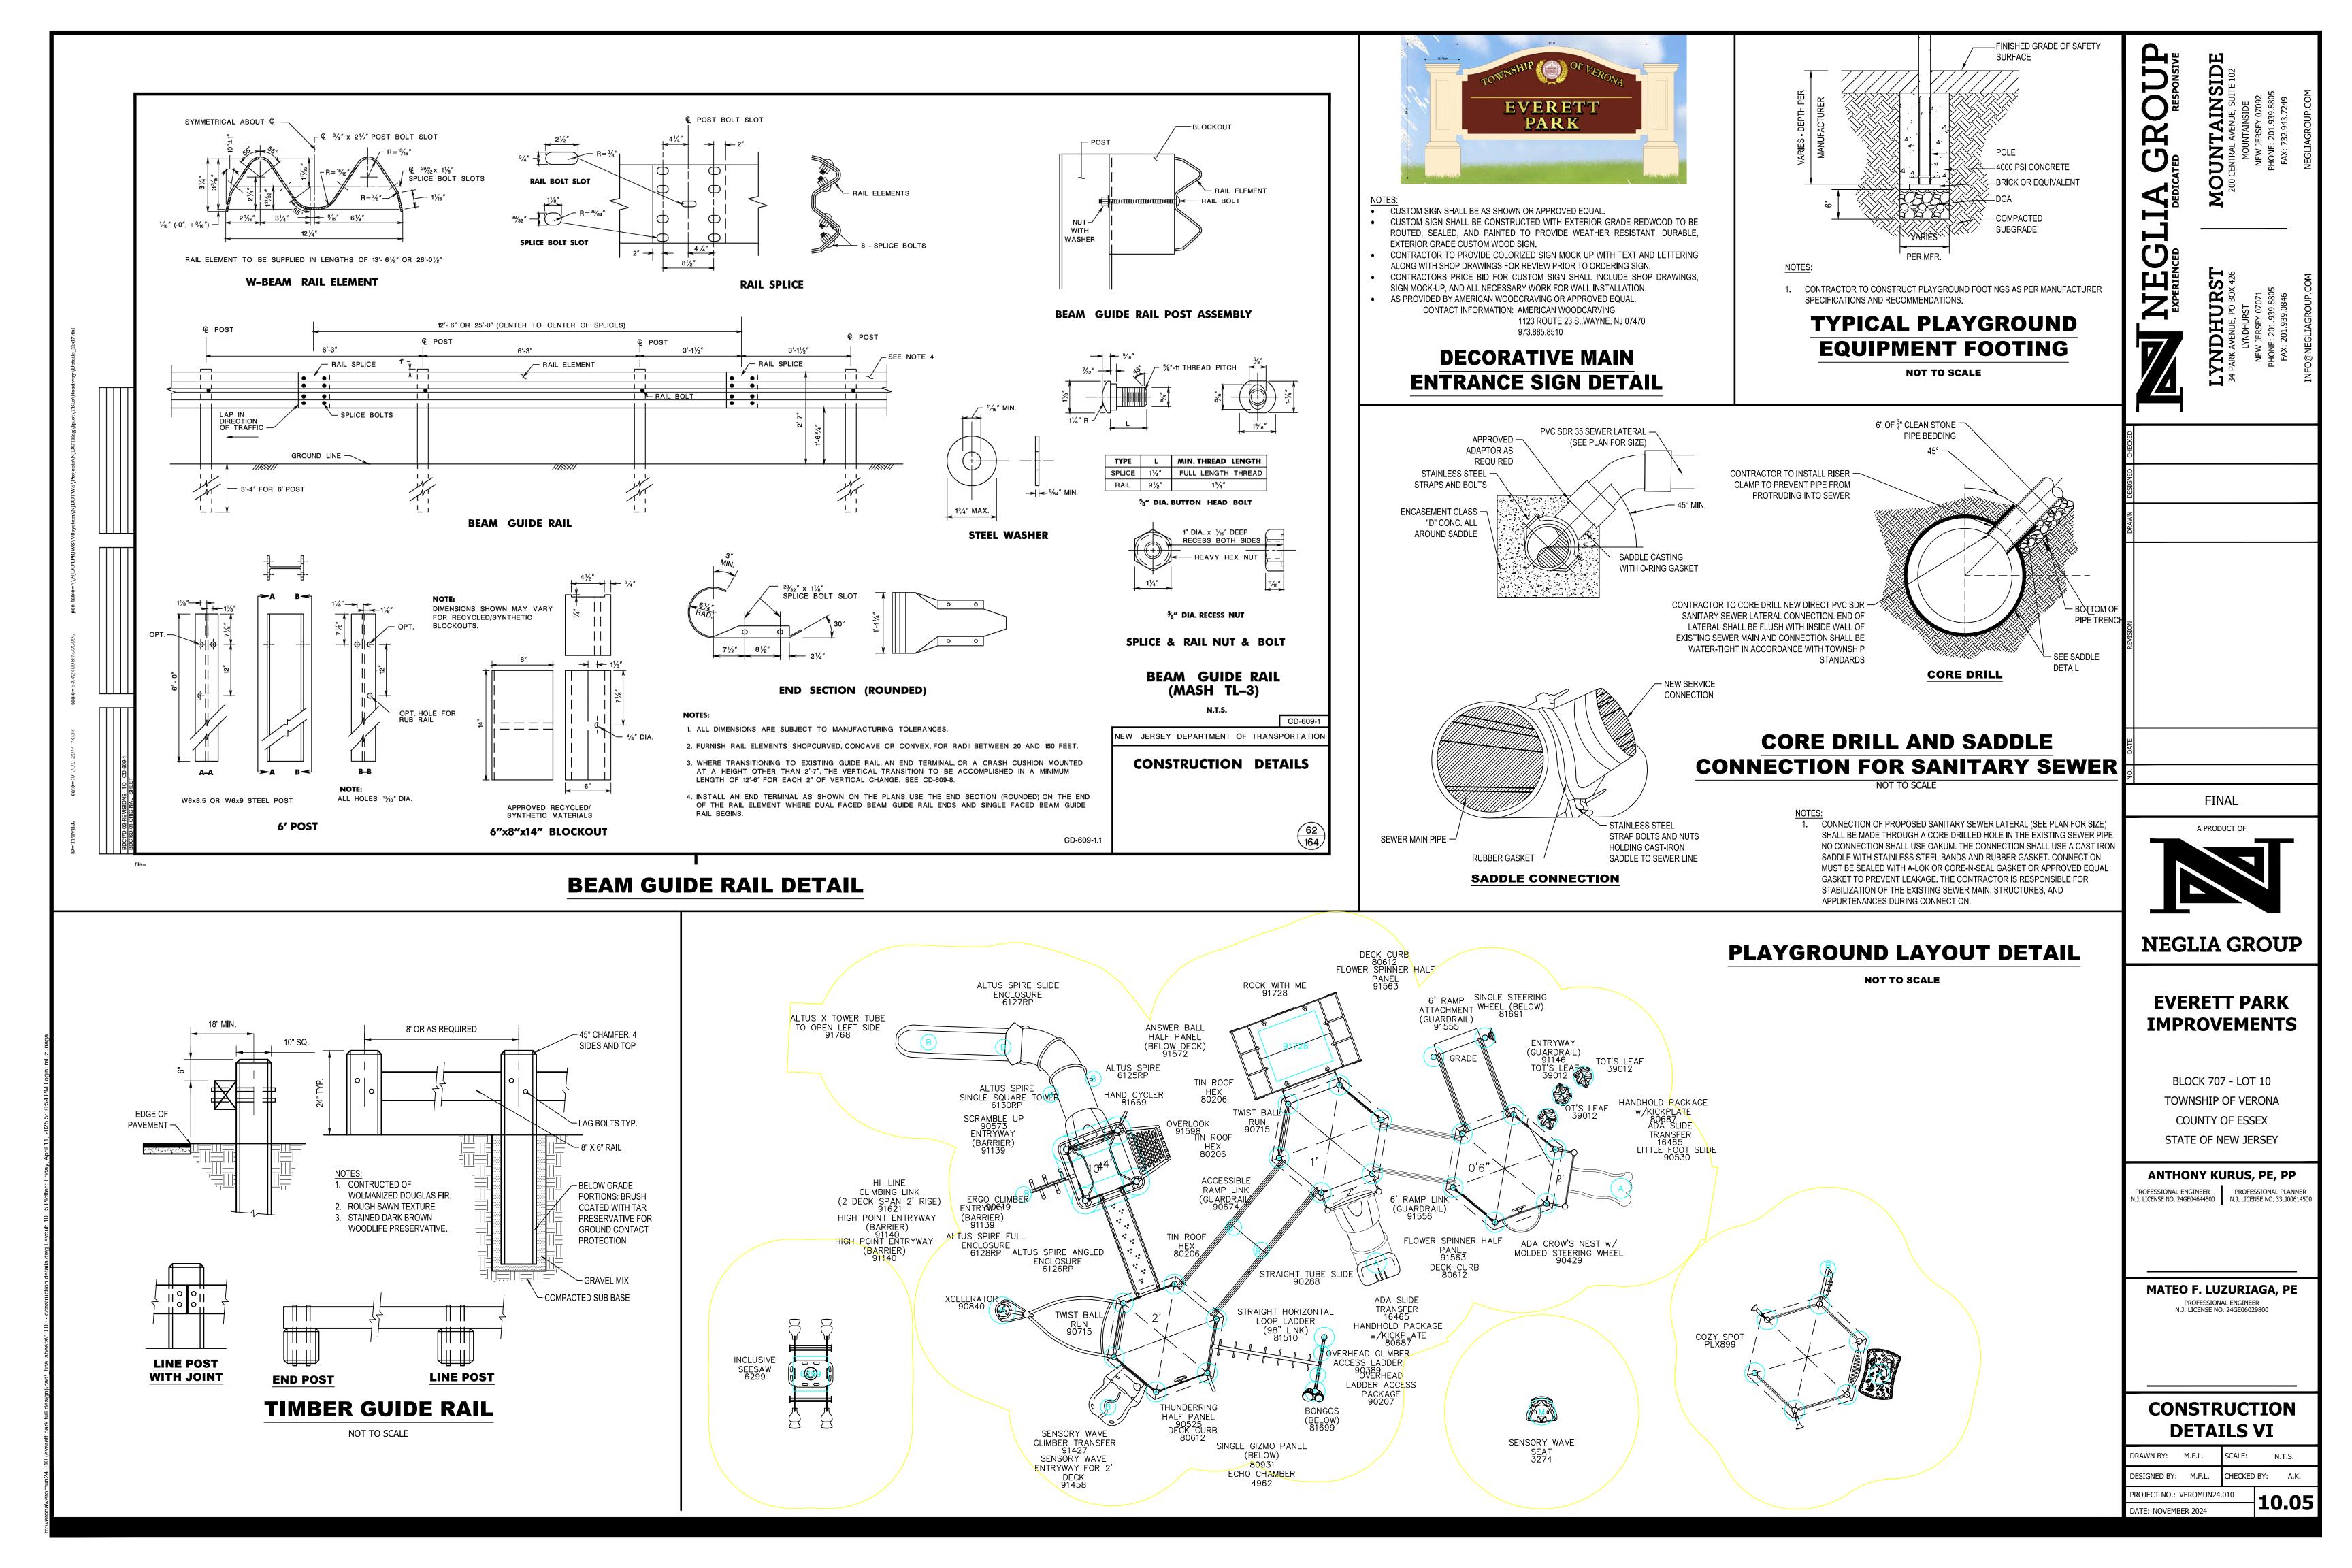

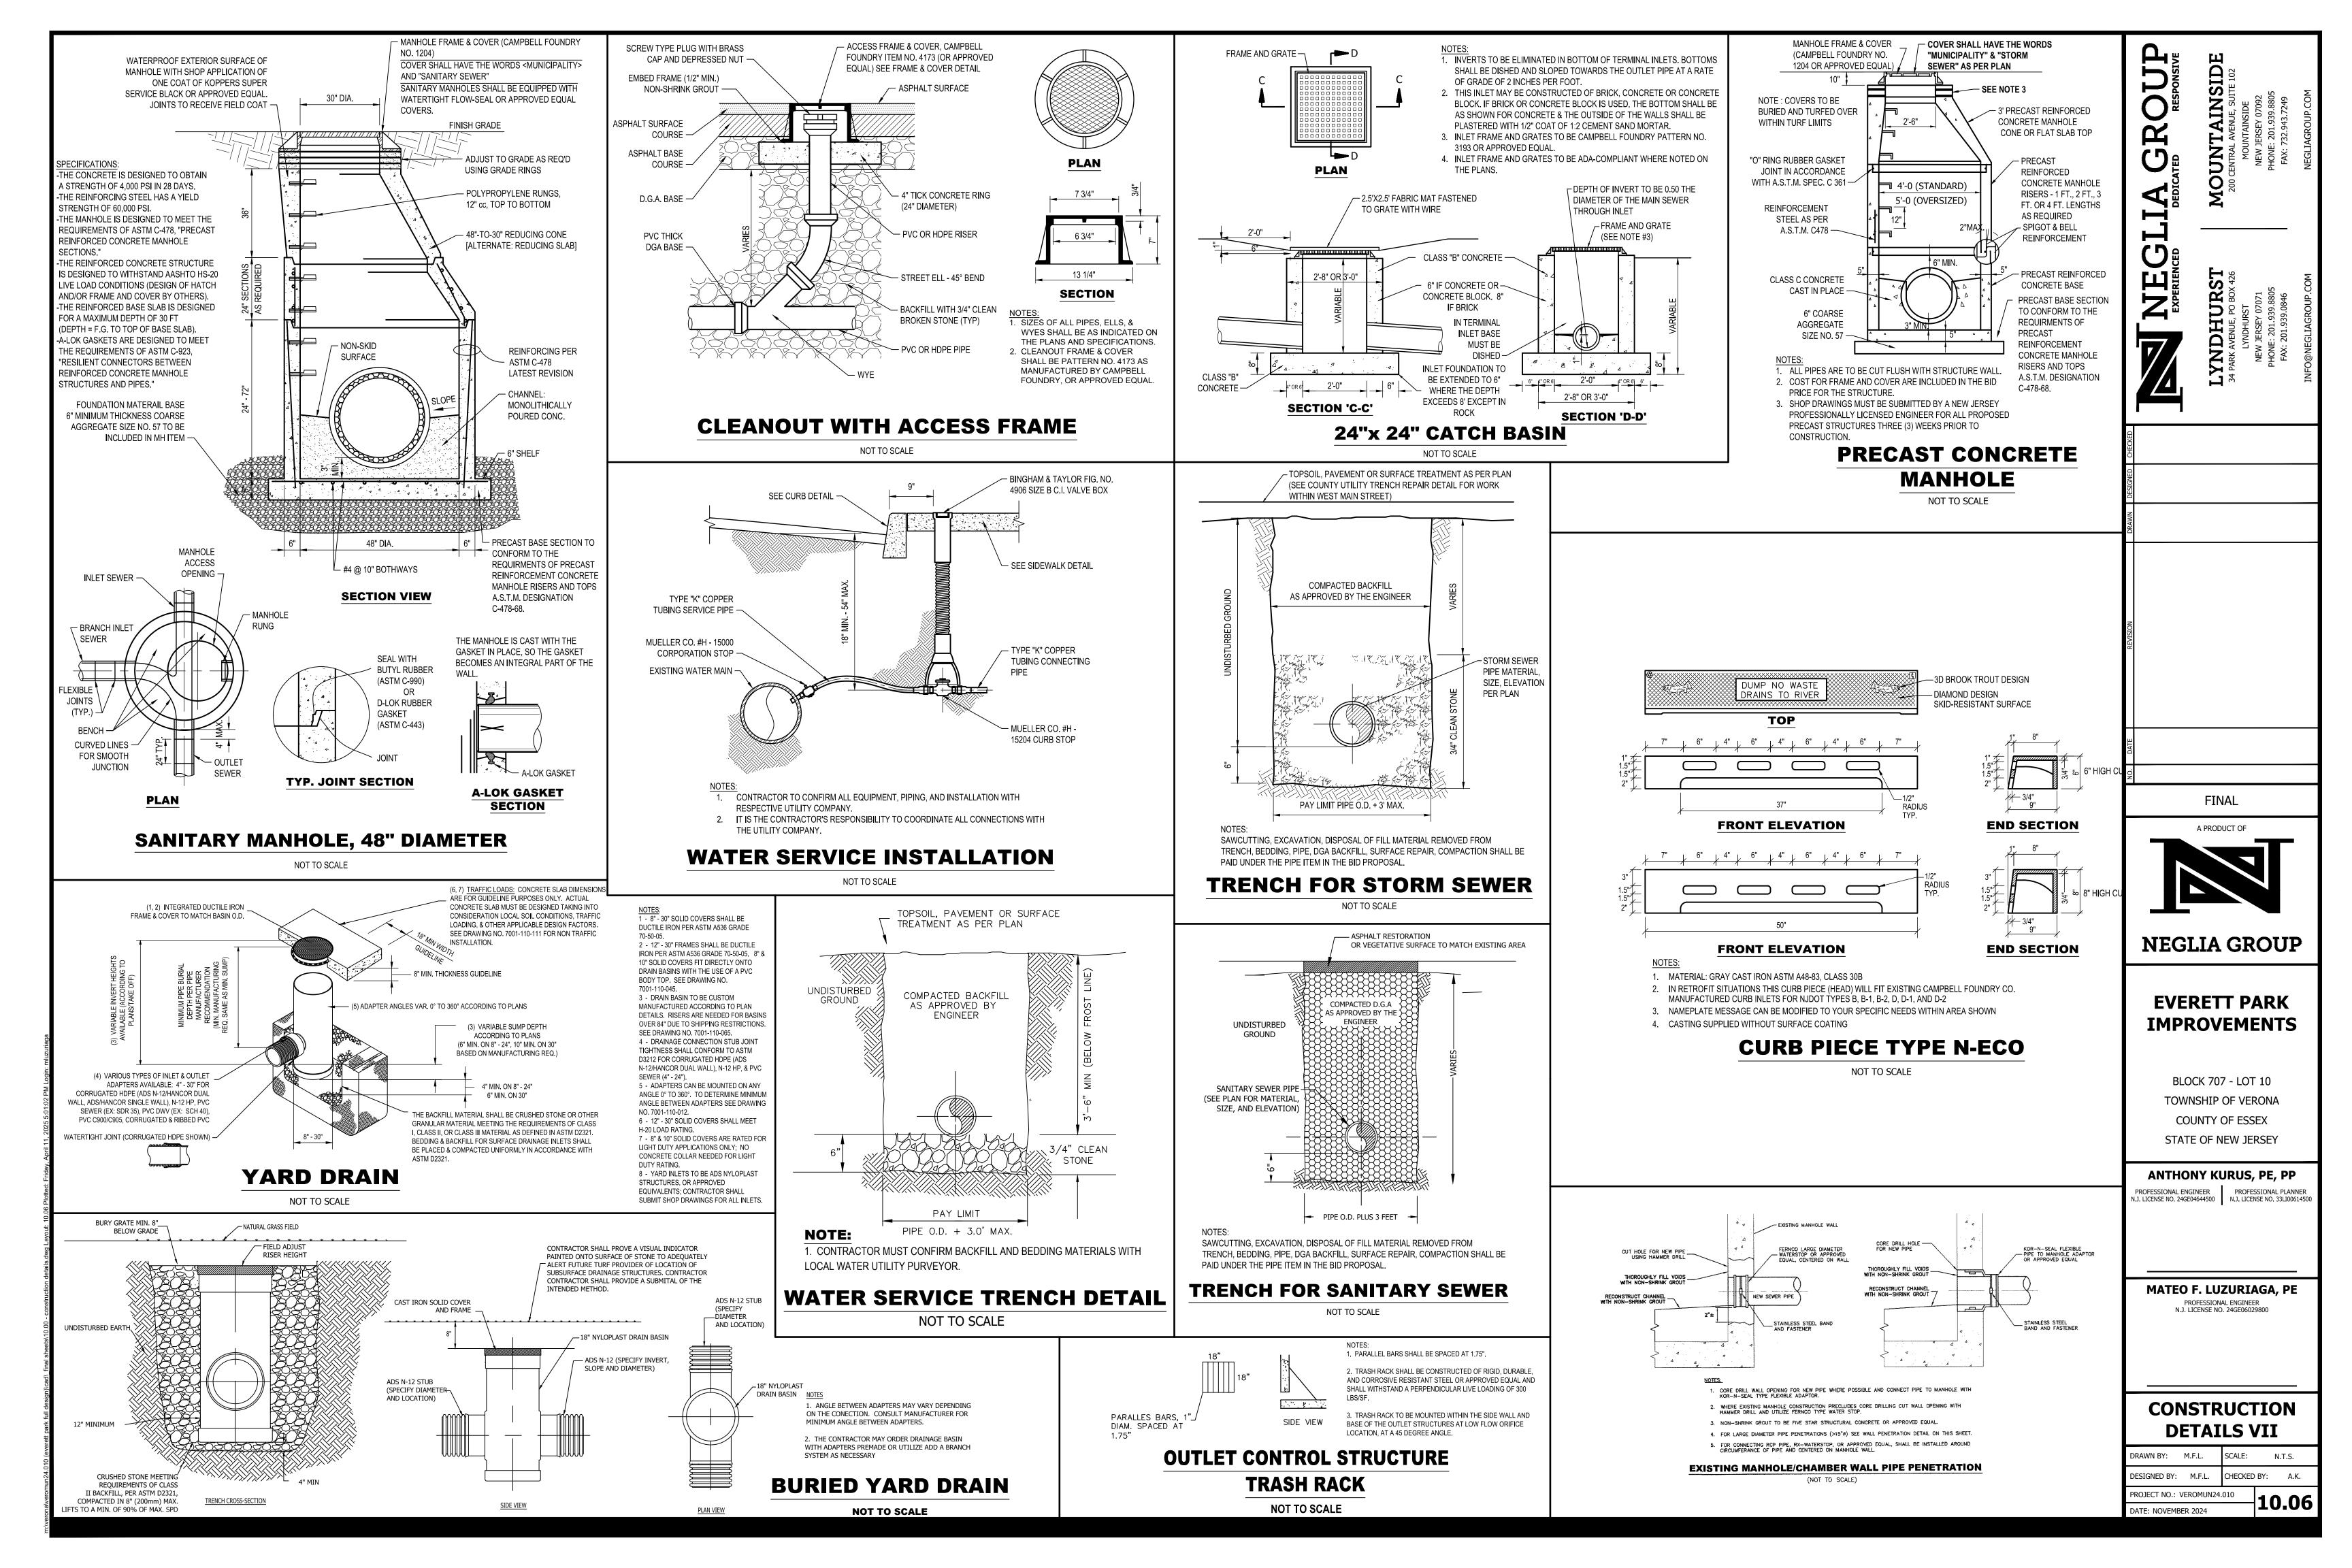

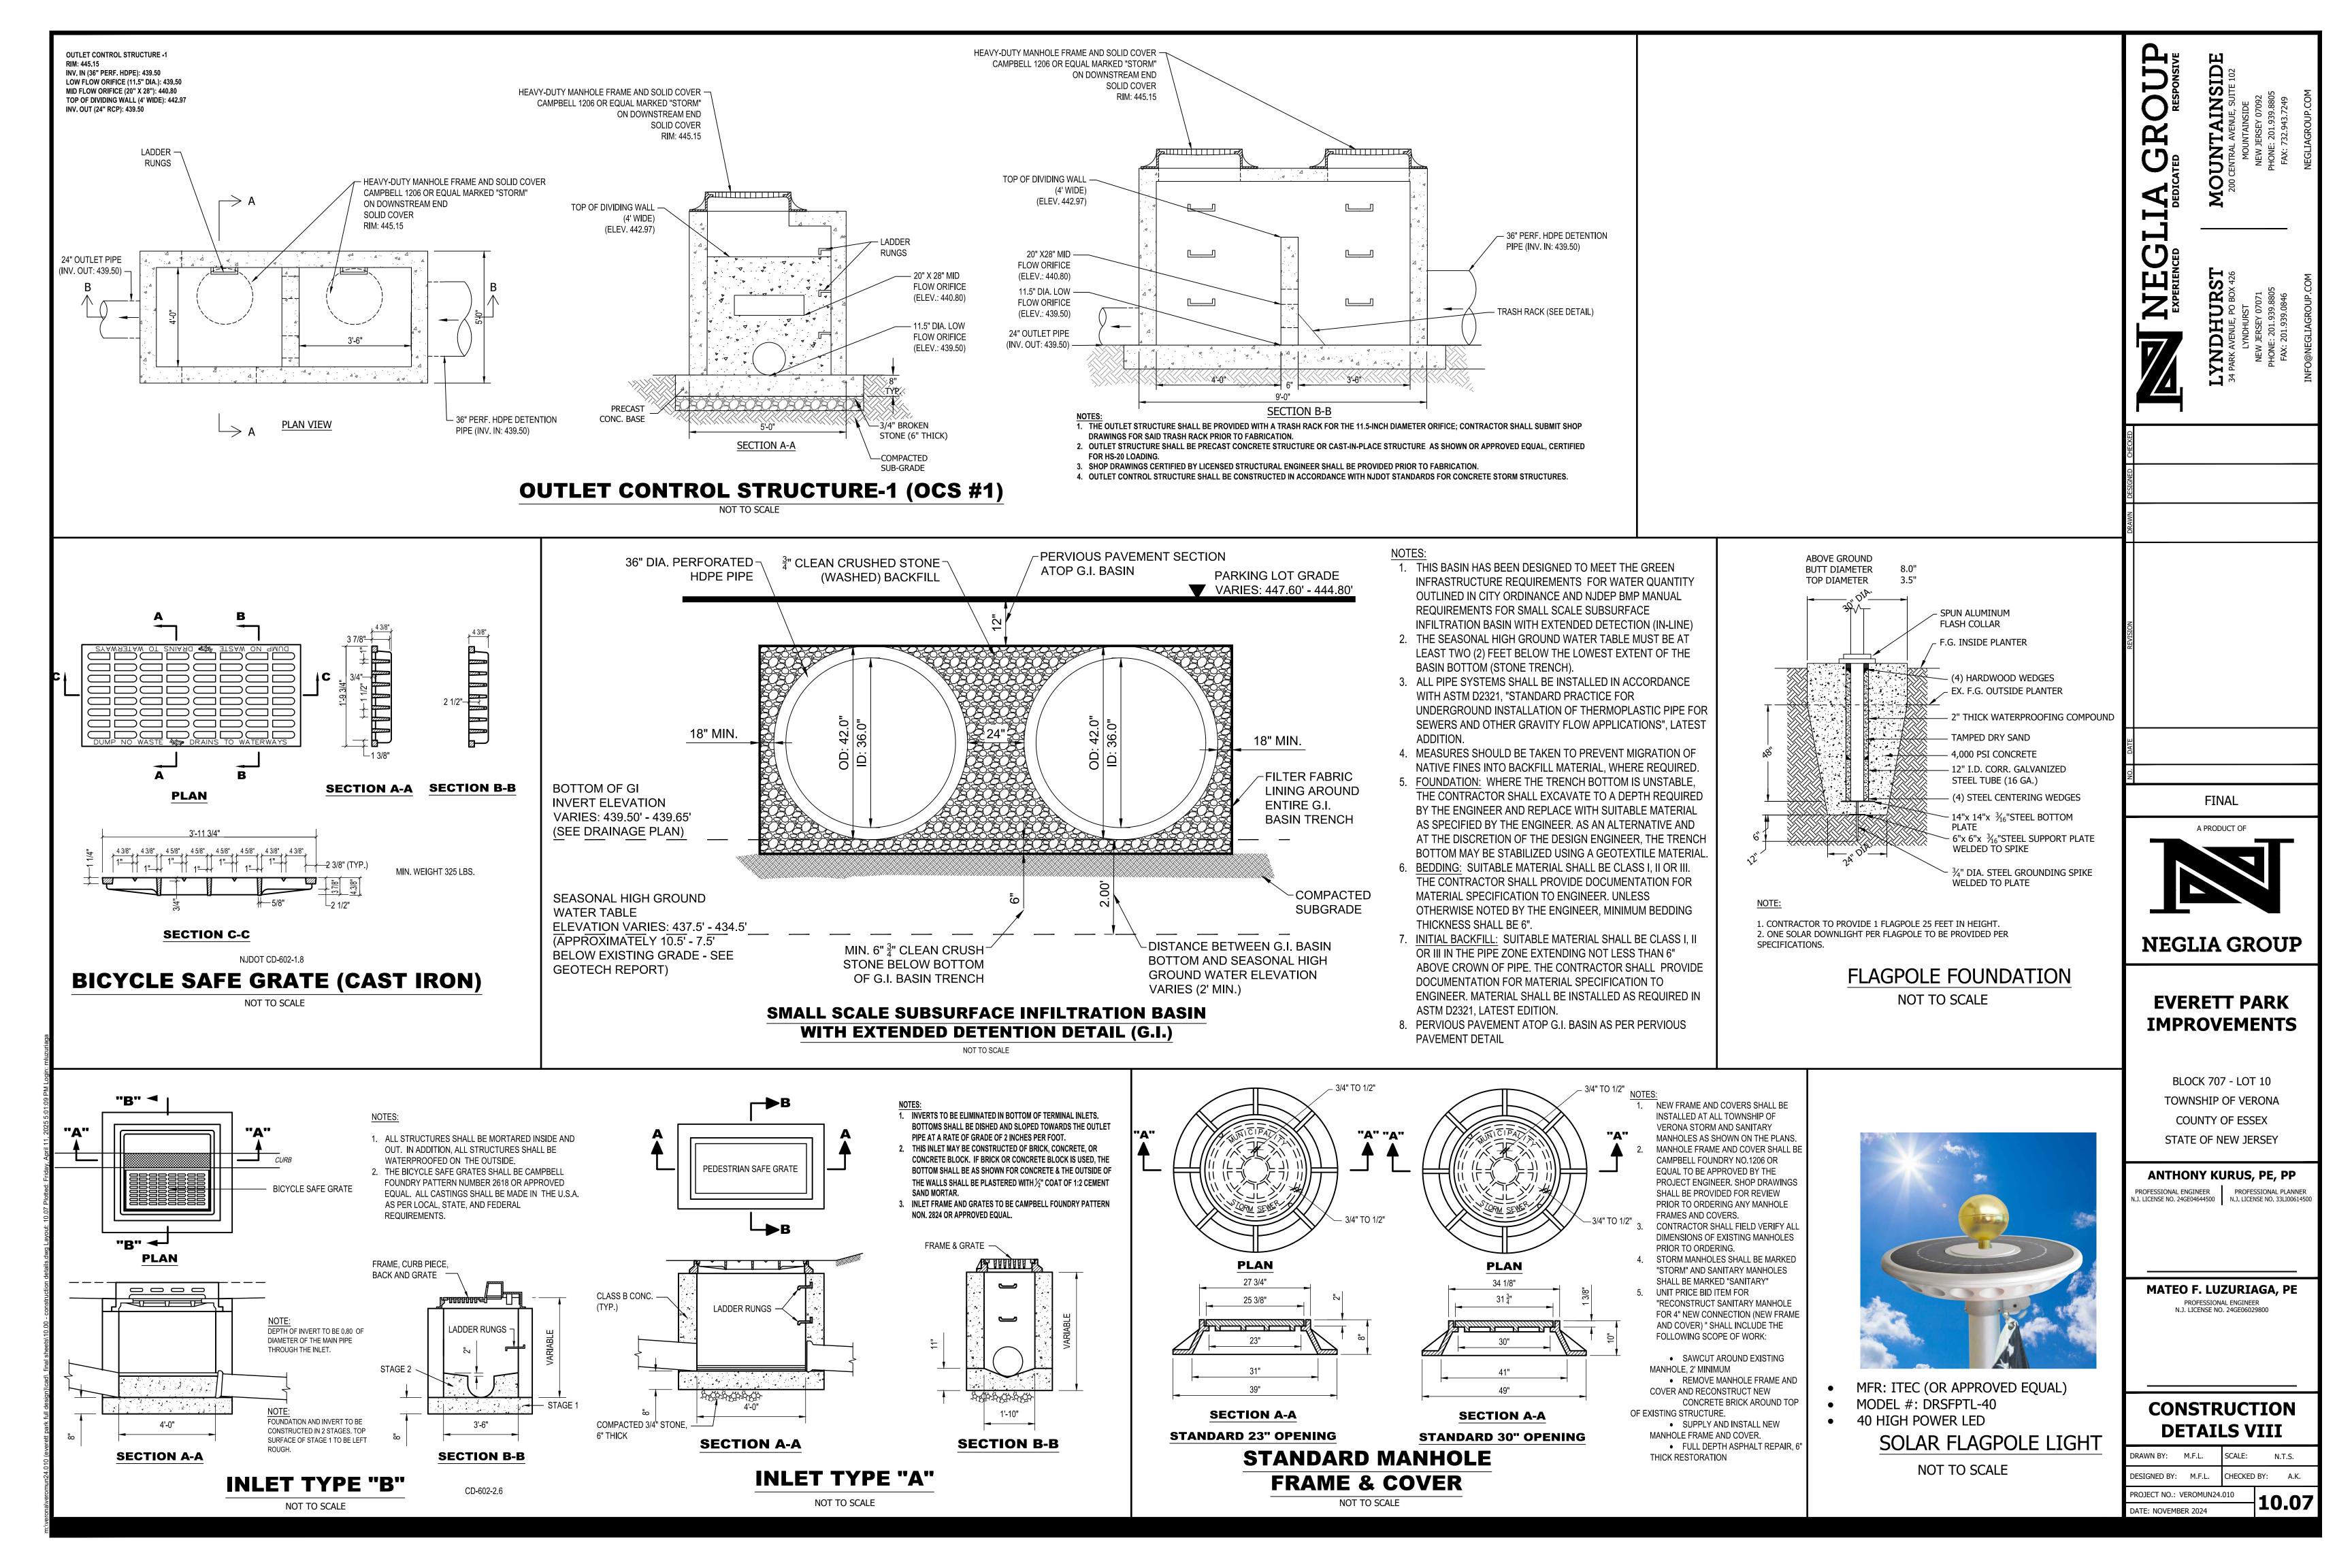

S84°33'E (D) DEED CALL UTILITY POLE LIGHT POLE WATER VALVE ROOF DRAIN GAS VALVE DEPRESSED CURB CLEAN-OUT EDGE OF PAVEMENT UNKNOWN VALVE LANDSCAPED AREA CHAIN LINK FENCE FIRE HYDRANT FF(S) FINISHED FLOOR(SILL) HANDICAPPED SPACE SANITARY SEWER LINE _____ STORM SEWER LINE

NEW JERSEY CERTIFICATION:

PLAN LEGEND:

I CERTIFY THAT I AM A PROFESSIONAL LAND SURVEYOR, LICENSED TO PRACTICE IN THE STATE OF NEW JERSEY, AND THAT THIS MAP OR PLAN IS A RESULT OF A FIELD SURVEY COMPLETED ON MAY 10, 2023, UNDER MY DIRECT SUPERVISION IN ACCORDANCE WITH THE RULES AND REGULATIONS PROMULGATED BY THE STATE BOARD OF ENGINEERS AND LAND SURVEYORS. I DECLARE THAT TO THE BEST OF MY KNOWLEDGE AND BELIEF, THE INFORMATION SHOWN HEREON CORRECTLY REPRESENTS THE CONDITIONS FOUND AT, AND AS OF THE DATE OF THE FIELD SURVEY, EXCEPT SUCH IMPROVEMENTS OR EASEMENTS, IF ANY, BELOW THE SURFACE AND NOT VISIBLE.

SURVEY NOTES:

1. UNDERGROUND UTILITIES IF DEPICTED ARE BASED ON VISIBLE EVIDENCE. THE LACK OF UTILITY INFORMATION DOES NOT DENY THE EXISTENCE OF SAME. PRIOR TO ANY DESIGN OR CONSTRUCTION, THE PROPER UTILITY AGENCIES MUST BE CONTACTED TO VERIFY THE PRESENCE OR ABSENCE OF UTILITIES.

---T----TELEPHONE MARKOUT

ELECTRIC METER

---w---- WATER MARKOUT

DENY THE EXISTENCE OF SAME. SITE REVIEW AND DELINEATION BY A QUALIFIED PROFESSIONAL IS REQUIRED TO VERIFY THE PRESENCE OR ABSENCE OF WETLANDS.

3. TOXIC WASTES ARE NOT DEPICTED. THE LACK OF TOXIC WASTE INFORMATION DOES

2. WETLANDS ARE NOT DEPICTED. THE LACK OF WETLANDS INFORMATION DOES NOT

- NOT DENY THE EXISTENCE OF SAME. SITE REVIEW FOR THE SAME SHOULD BE PURSUED AND APART FROM THIS SURVEY.

 4. FEMA DATA EFFECTIVE DOCUMENTS: IN ACCORDANCE WITH A CERTAIN MAP
- ENTITLED "NATIONAL FLOOD INSURANCE PROGRAM, FIRM, ESSEX COUNTY, NEW JERSEY (ALL JURISDICTIONS), PANEL 103 OF 200, MAP NUMBER 34013C0103F", WITH AN EFFECTIVE DATE OF JUNE 4,2007, THE SUBJECT PARCEL LIES FULLY WITHIN ZONE X, AN AREA DETERMINED TO BE OUTSIDE THE 0.2% CHANCE FLOODPLAIN.
- 5. FENCES & WALLS HAVE BEEN LOCATED AT THE BOTTOM OF THE STRUCTURE, AT THE TIME OF FIELD SURVEY.6. THE MERIDIAN OF THIS SURVEY IS BASED ON THE NEW JERSEY PLANE COORDINATE
- SYSTEM NAD83(2011) AS ESTABLISHED USING GPS METHODS AND THE SMARTNET NETWORK.
- 7. ELEVATIONS SHOWN ARE BASED ON THE NORTH AMERICAN VERTICAL DATUM OF 1988(NAVD88) AS ESTABLISHED USING GPS METHODS AND THE SMARTNET NETWORK.

REFERENCES:

1. LOT AND BLOCK NUMBERS SHOWN HEREON REFER TO THE TOWNSHIP OF TAX MAP SHEET NO. 2 & 7 DATED JANUARY 1, 2008.

CERTIFICATE OF AUTHORIZATION (N.J.S.A. 45:8-56) 24GA27927000

DRAWN DESIGNED CHECKED
PJP GAV
PJP GAV

REVISIONS

12-18-2023 UPDATE DRAINAGE SYSTEM.

10-16-2024 UPDATED SANITARY SYSTEM ALONG BLOOMFIELD AVENUE.

GARY A. VEENSTRA, P.L.S.
PROFESSIONAL LAND SURVEYOR
N.J. LICENSE NO. 24GS03721300

NEGLIA ENGINEERING ASSOCIATES
34 PARK AVENUE
TEL: 201-939-8805

A PROJECT OF
A PROJ

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MICHAEL J. NEGLIA, P.E., P.L.S., P.P.

PROFESSIONAL ENGINEER
N.J. LICENSE NO. 38604

PROFESSIONAL LAND SURVEYOR
N.J. LICENSE NO. 38604

PROFESSIONAL PLANNER
N.J. LICENSE NO. 38100569800

TOPOGRAPHIC SURVEY
EVERETT PARK
BLOCK 707 LOT 10
TOWNSHIP OF VERONA
ESSEX COUNTY
NEW JERSEY

DRAWN BY: P.J.P.

DESIGNED BY:

SCALE:

1"=20'


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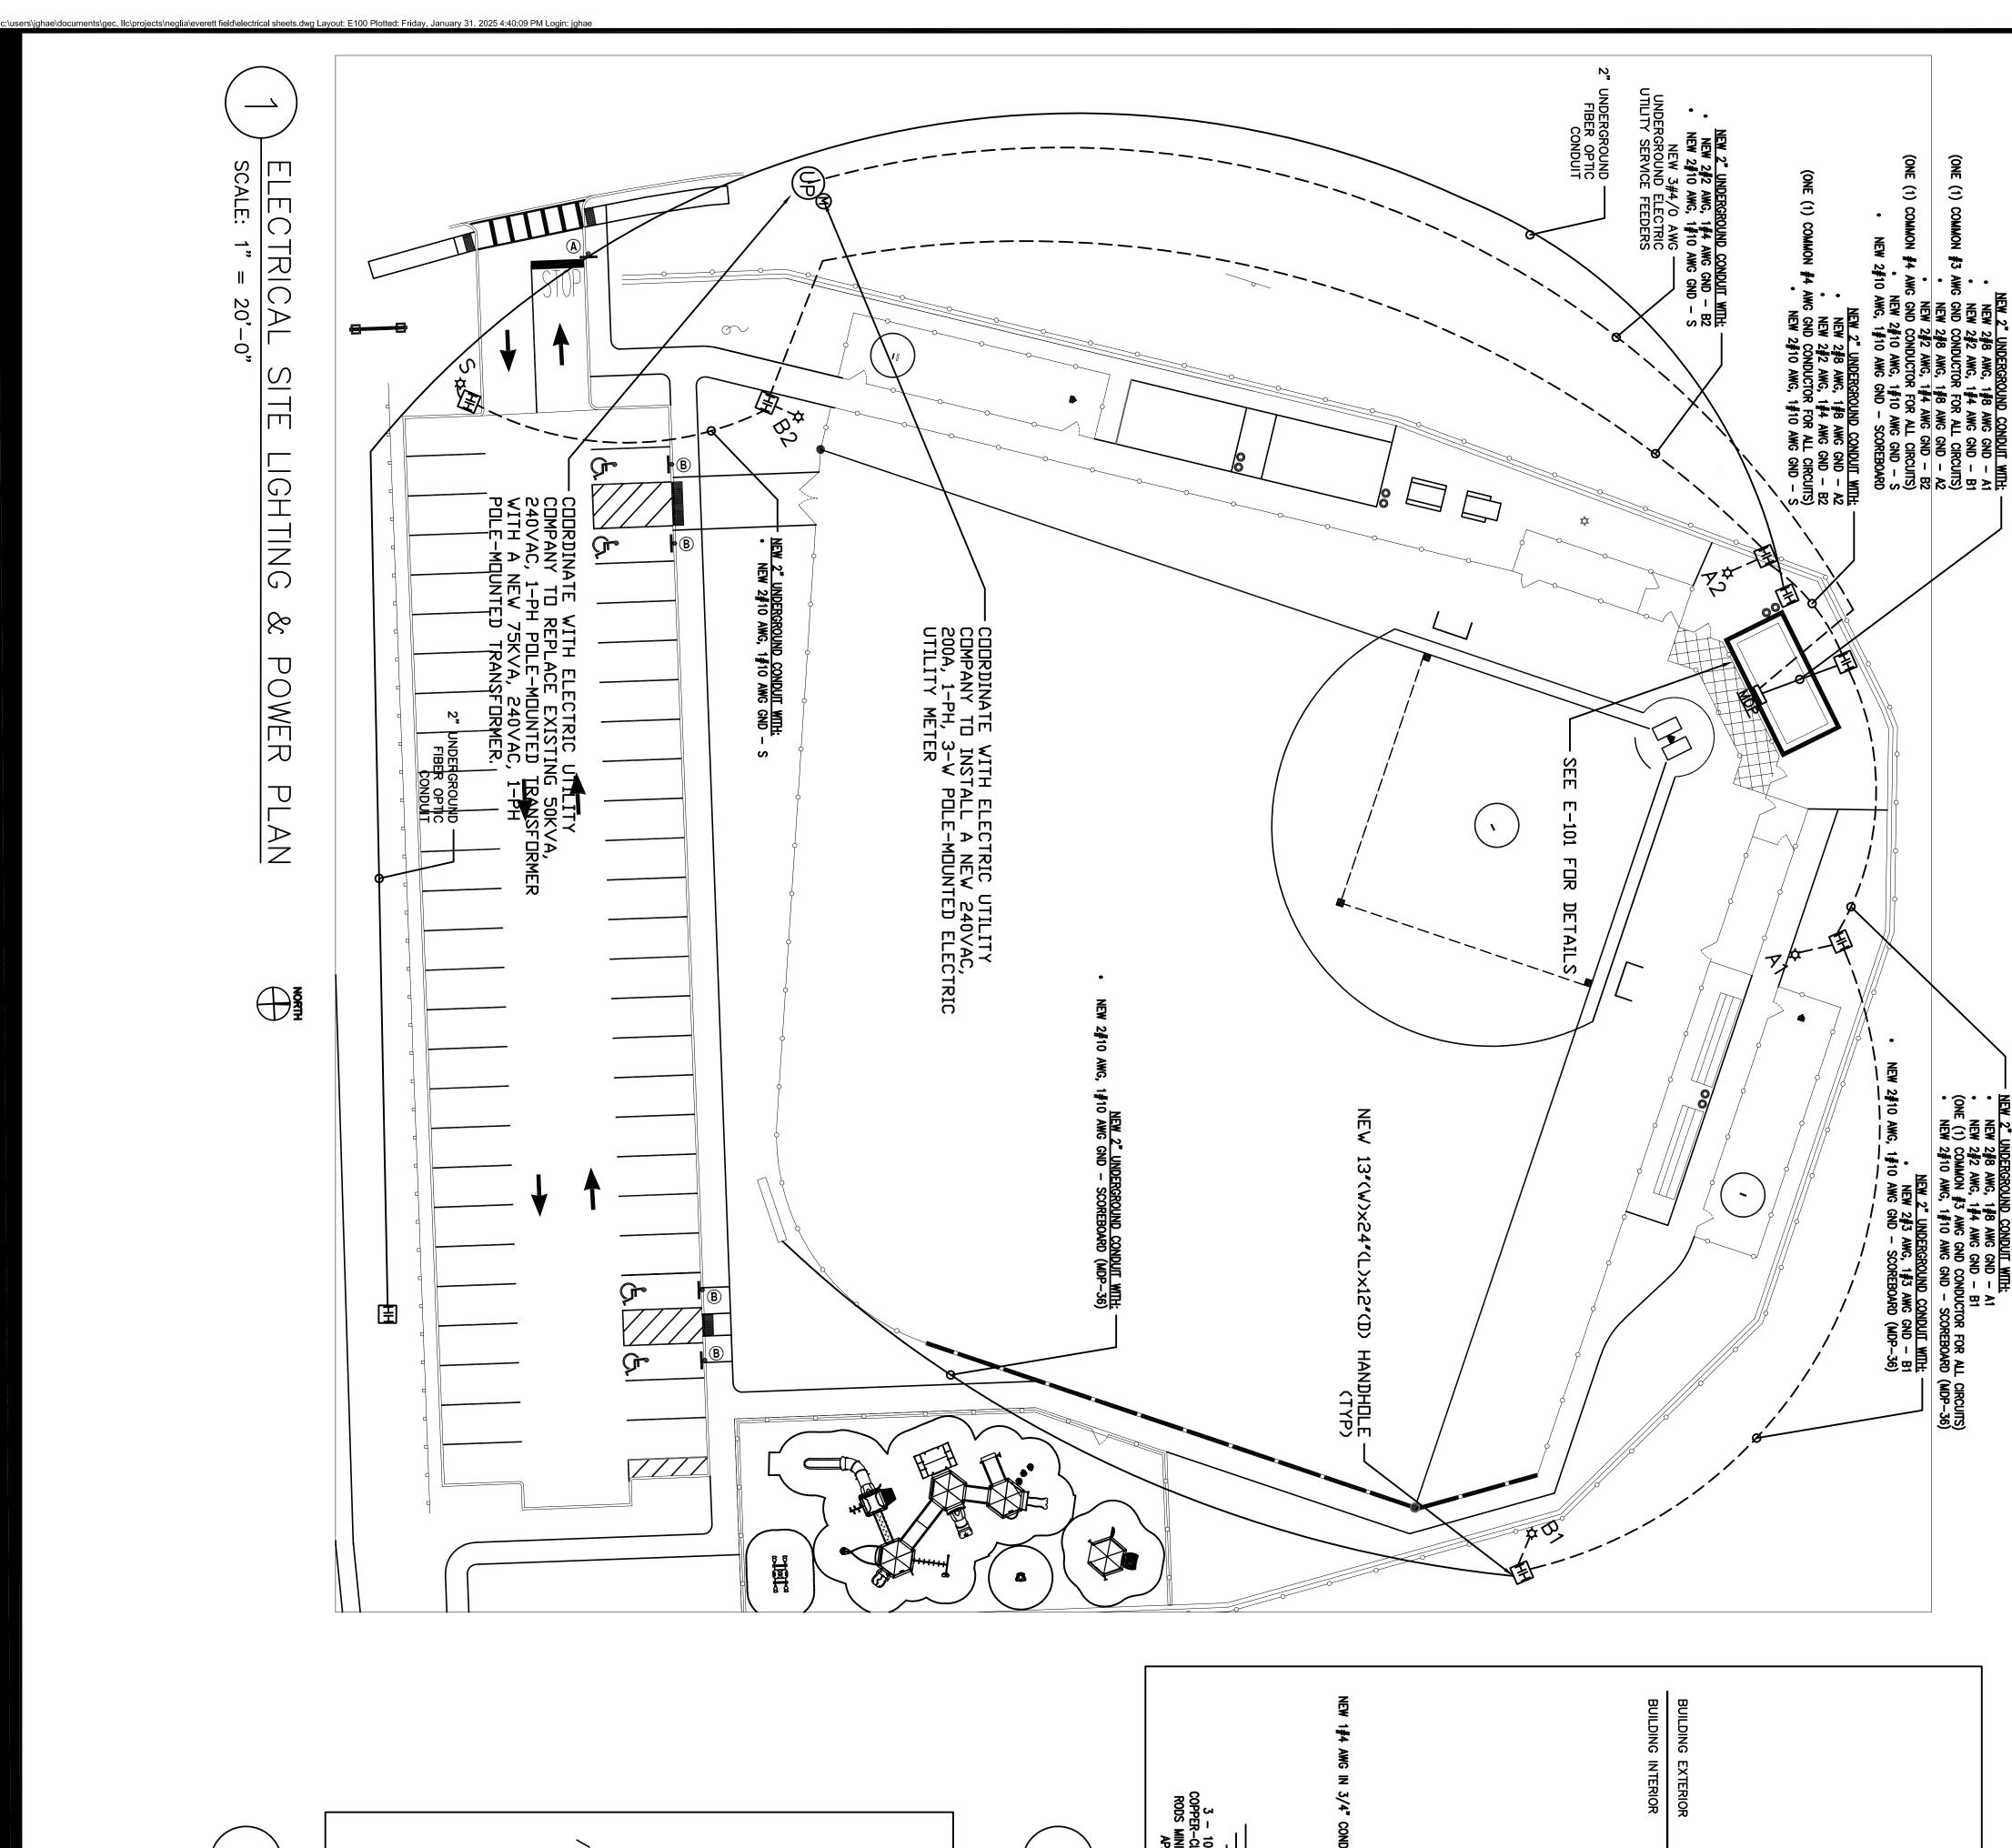
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SHEET NO.:

VEROMUN23.010

DATE: JUNE 6, 2023





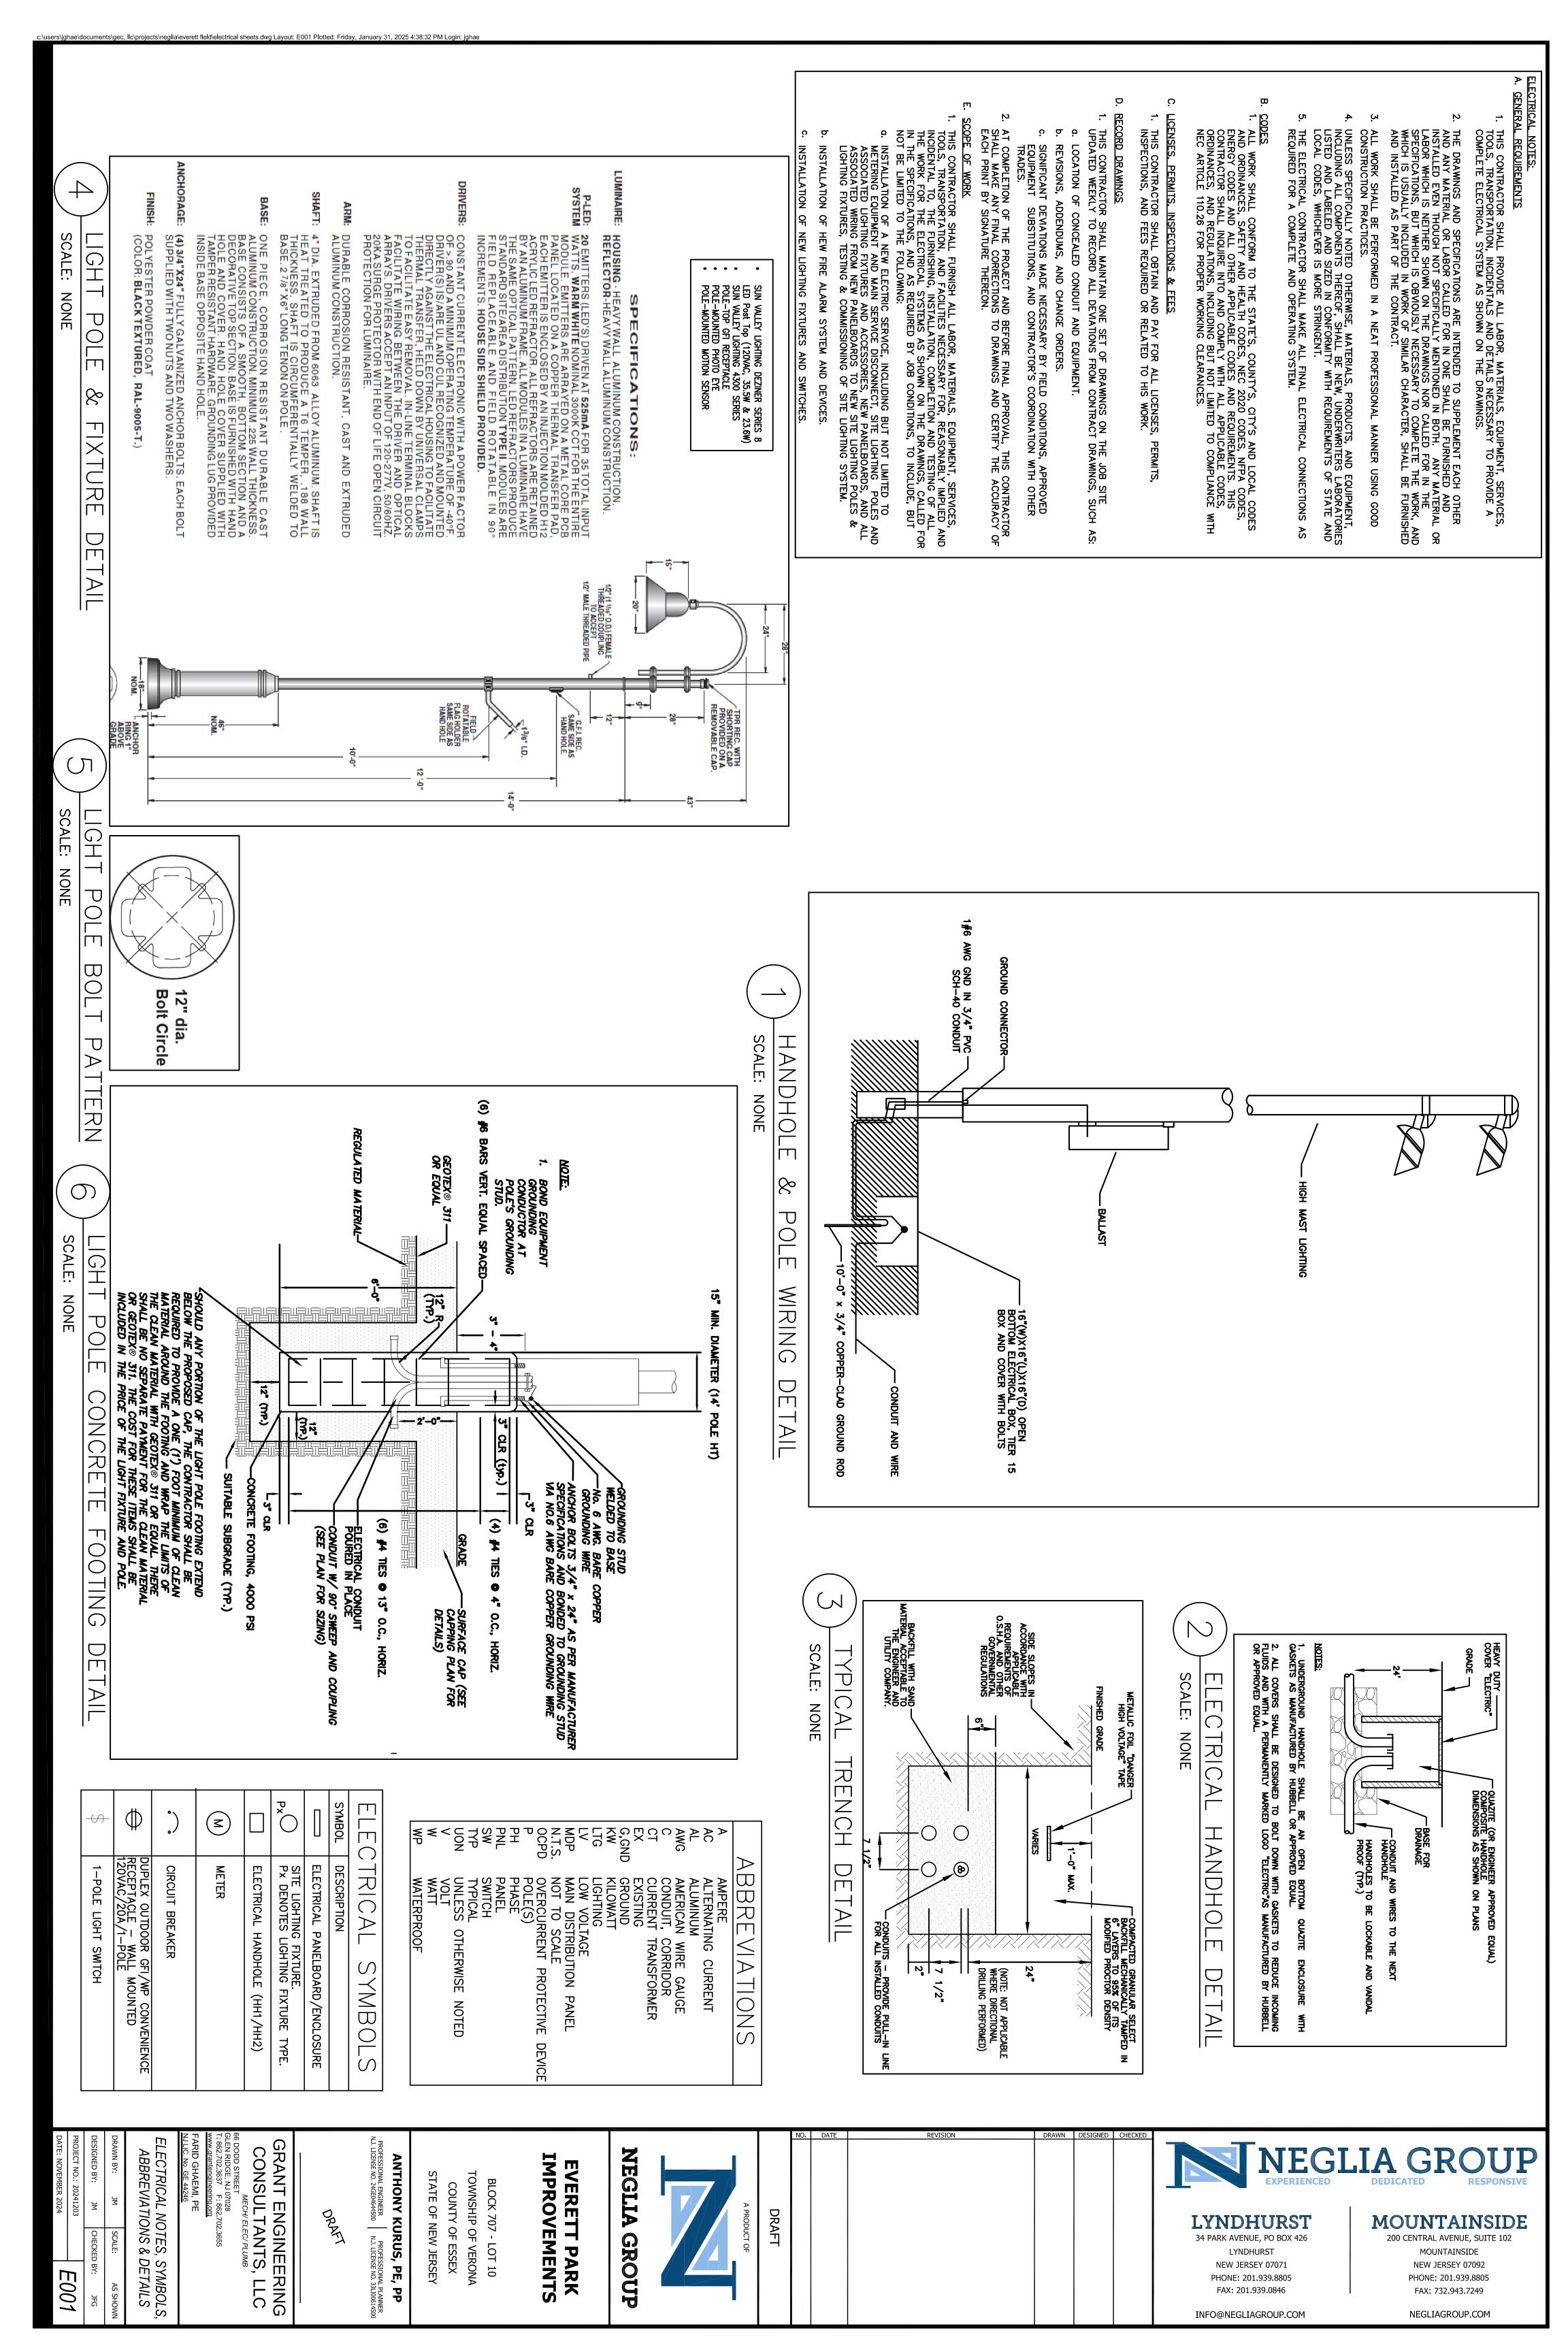

SCALE:

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20'

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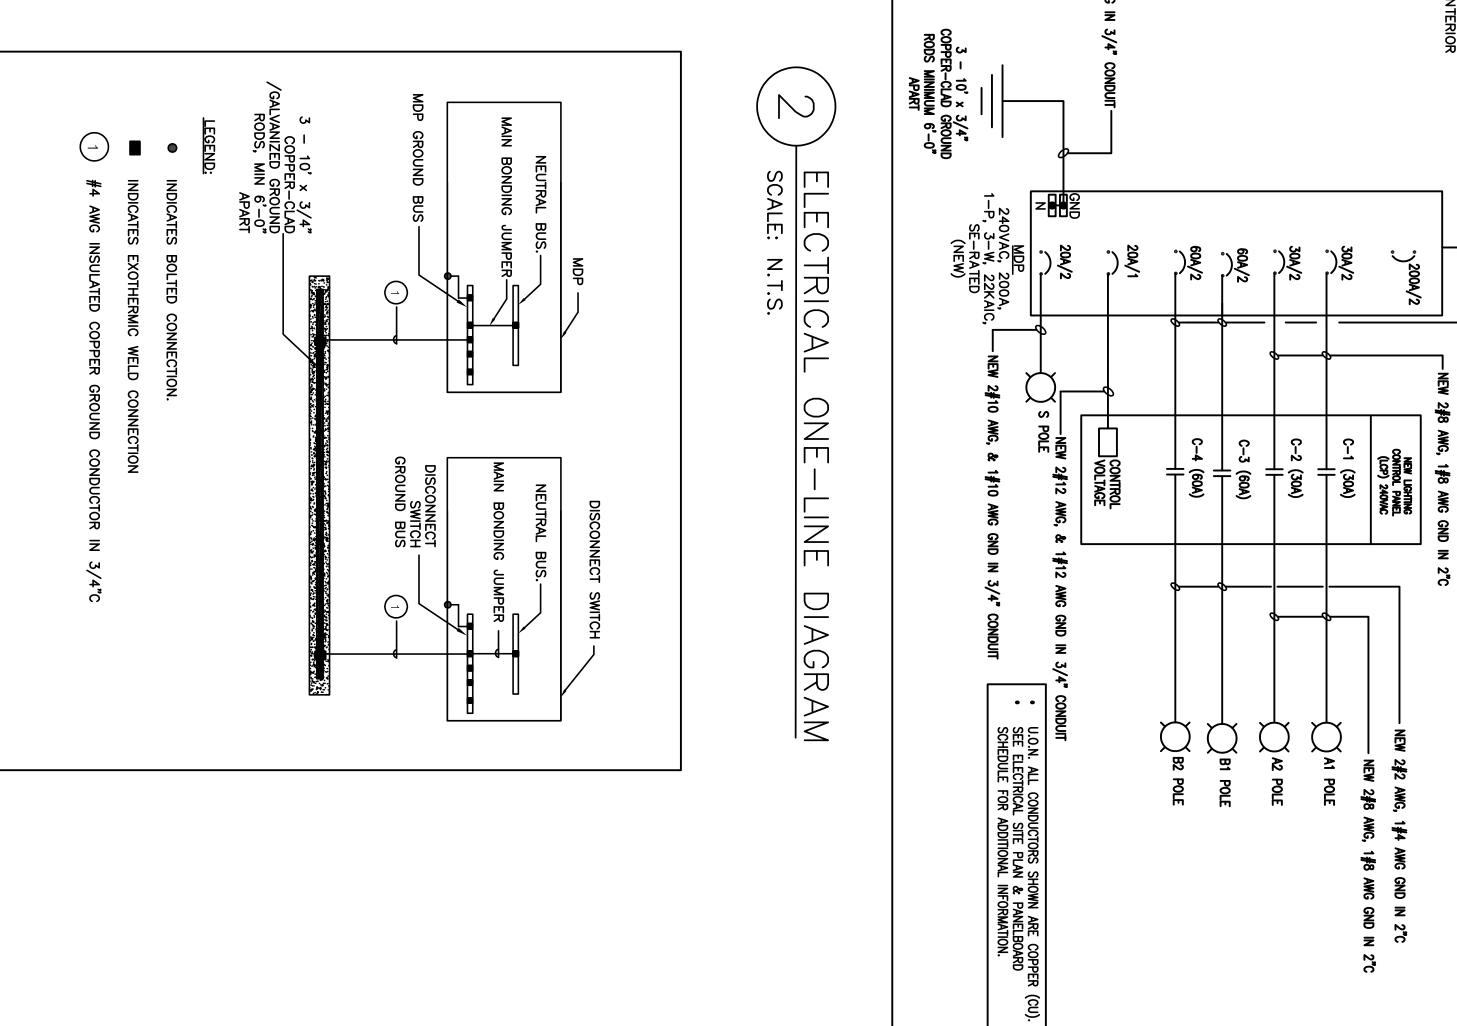
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REVISION



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NEW 240VAC, 200A, 1-PH, 3-W ELECTRIC

POLE-MTD METER

NEW 2#2 AWG, 1#4 AWG GND IN 2°C

34 PARK AVENUE, PO BOX 426 LYNDHURST NEW JERSEY 07071 PHONE: 201.939.8805 FAX: 201.939.0846

LYNDHURST

INFO@NEGLIAGROUP.COM

MOUNTAINSIDE 200 CENTRAL AVENUE, SUITE 102 MOUNTAINSIDE NEW JERSEY 07092 PHONE: 201.939.8805 FAX: 732.943.7249

NEGLIAGROUP.COM

NEW OVERHEAD ELECTRIC UTILITY SERVICE 240/120VAC, 200A, 1-PHASE, 3-WIRE

NEW 3#4/0 AWG UNDERGROUND ELECTRIC UTILITY SERVICE FEEDERS

ANTHONY KURUS, PE, PP BLOCK 707 - LOT 10 TOWNSHIP OF VERONA STATE OF NEW JERSEY COUNTY OF ESSEX

NEGLIA GROUP

A PRODUCT OF

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EVERETT PARK IMPROVEMENTS

DRAFT

GRANT ENGINEERING
CONSULTANTS, LLC

66 DODD STREET
GLEN RIDGE, NJ 07028
T: 862.702.3637 F: 862.702.3655

www.grantengineering.org
FARID GHAEMI, PE
NJLIC. No. GE 44246

ELECTRICAL SITE LIGHTING &
POWER PLAN, ONE-LINE
DIAGRAM & DETAILS


THE SCALE:

AS SHOWN

THE SCALE:

AS SHOWN

E100

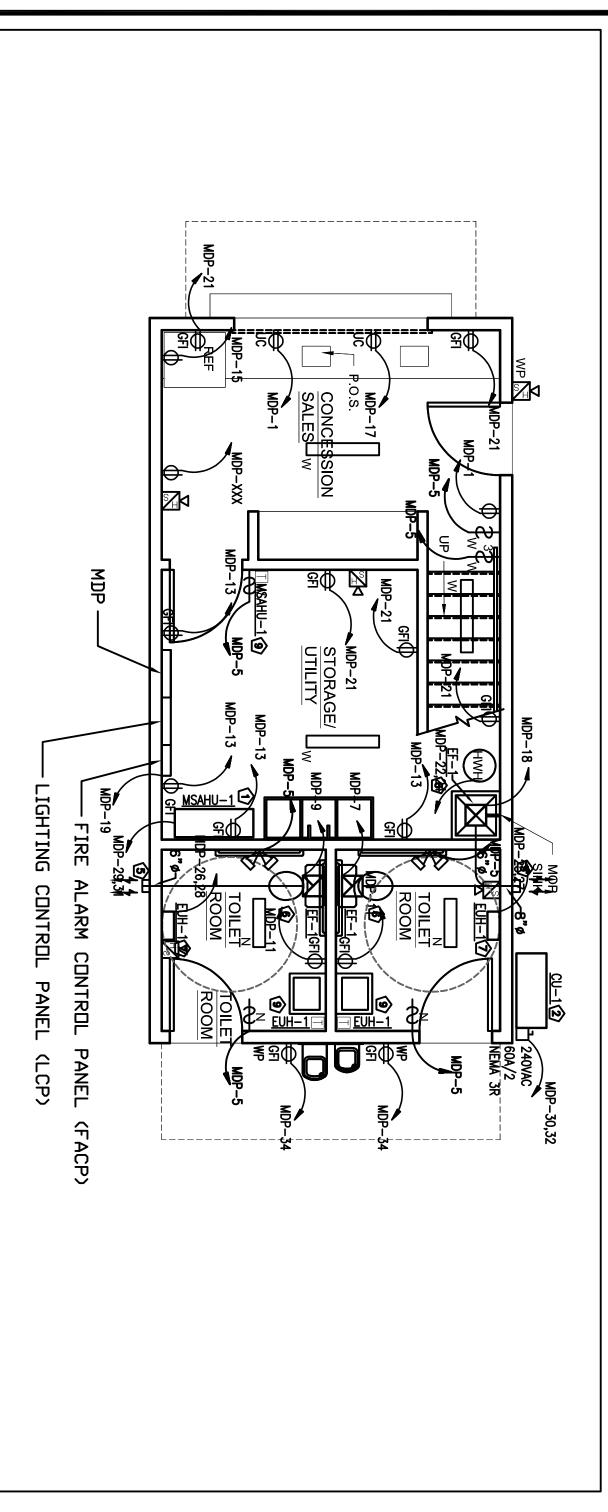

MSAHU-2 8 P. 14X8 **(** 23 14X8 ≷Π SR-1 4700FM 12" 6

NEGLIA GROUP
EXPERIENCED DEDICATED RESPONSIVE

MOUNTAINSIDE

200 CENTRAL AVENUE, SUITE 102

MOUNTAINSIDE

NEW JERSEY 07092

PHONE: 201.939.8805

FAX: 732.943.7249

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LYNDHURST

34 PARK AVENUE, PO BOX 426

LYNDHURST

NEW JERSEY 07071

PHONE: 201.939.8805

FAX: 201.939.0846

INFO@NEGLIAGROUP.COM

SCALE: CONCI 1/4" \bigcirc SION O, \Box DING \bigcirc $\neg \neg$ 00R OWER **GHTING** 8 FIRE ARM

SCALE:

1/4"

1'-0"

CONCESSION

BUILDING

2ND

FLOOR

OWER


LIGHTING


8

FIRE

ARM

DRAWN DESIGNED CHECKED

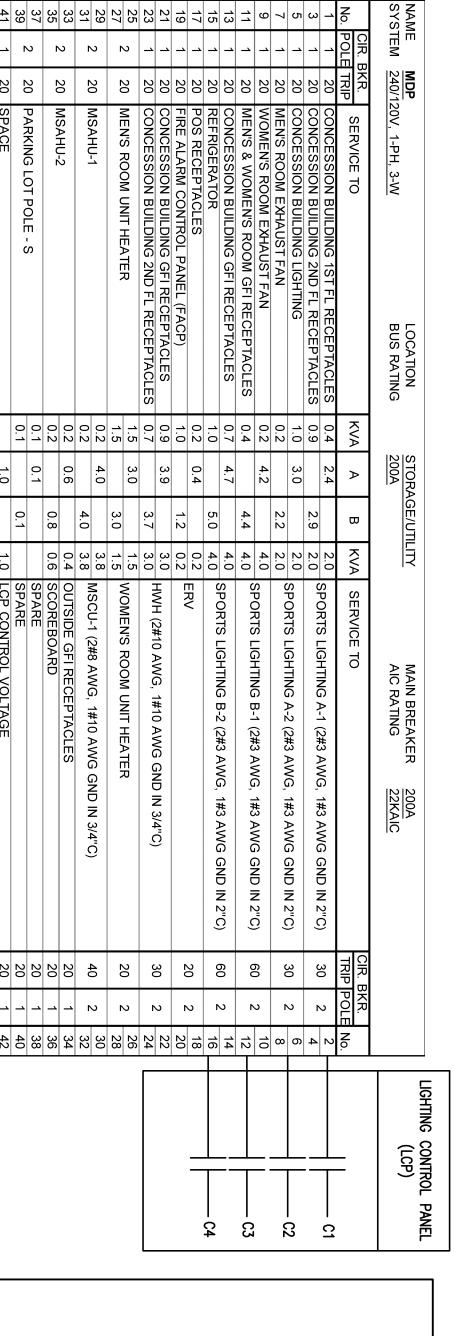

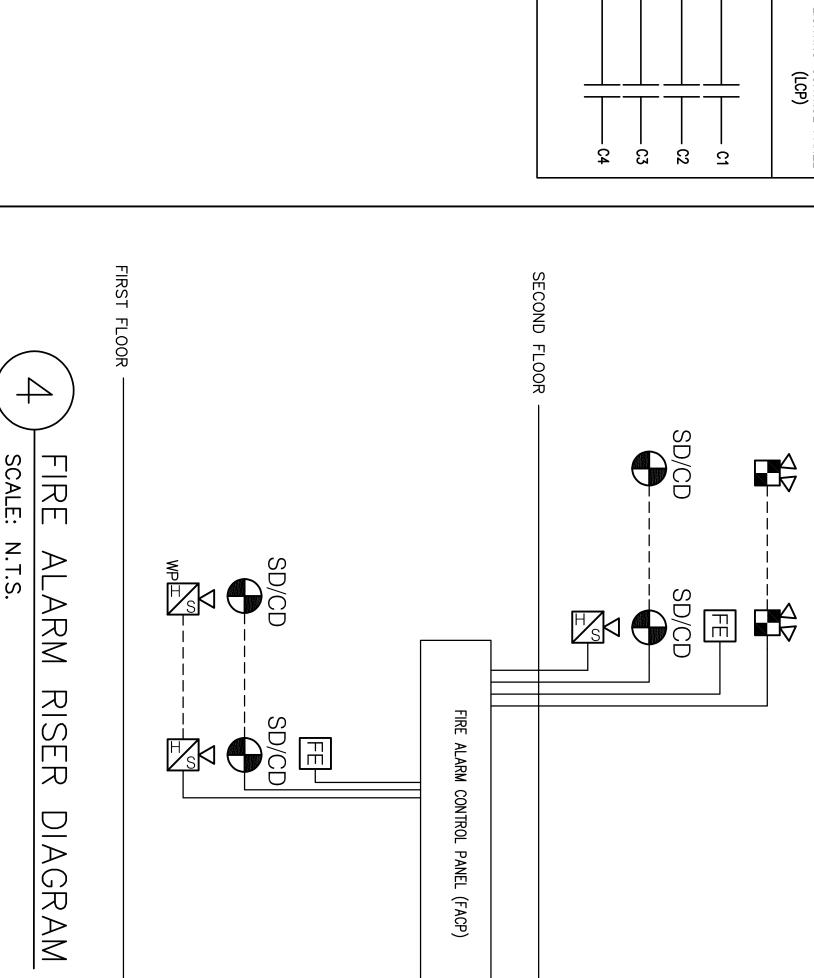

COMBINATION AUDIBLE AND VISUAL FIRE ALRM STROBE LIGHT FIRE ALARM CONTROL PANEL FIRE ALARM PULL STATION COMBINATION CARBON MONOXIDE & SMOKE DETECTOR DEVICE	"WP" DENOTES WEATHER PROOF	
		O _{SD/CD}
	FIRE ALARM PULL STATION	FE
	FIRE ALARM CONTROL PANEL	FACP
	COMBINATION AUDIBLE AND VISUAL FIRE ALRM STROBE LIGHT	
FIDE ALADM SYMBOLS	FIRE ALARM SYMBOLS	

c:\users\jghae\documents\gec, Ilc\projects\neglia\everett field\electrical sheets.dwg Layout: E101 Plotted: Friday, January 31, 2025 4:40:50 PM Login: jghae

WALL MOUNTED EMERGENCY L

LITHONIA LIGHTING
ECC R
2 X 0.75W LED
120VAC
SEALED MAINTENANCE—FREE N
DELIVERS 90 MINUTES CAPACI

-FREE NICKEL CAPACITY TO

CADMIUM

BATTERY

SCALE:

N.T.S.

DESCRIPTION:
MANUFACTURE:
MODEL:
LAMP:
VOLTAGE:
NOTES:

WALL MOUNTED EMERGENCY L
LITHONIA LIGHTING
EU2 LED M12
2 X 1.8W LED
120VAC
SEALED MAINTENANCE—FREE N
DELIVERS 90 MINUTES CAPACI
DAMP LOCATION LISTED.

-FREE NICKEL CAPACITY TO

CADMIUM BATTERY EMERGENCY LAMPS

LIGHTING FIXTURE

SCHEDULE

LIGHT

ANEL

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TOTAL DEMAND LOAD

AMPS

BOARD. REFE

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SCALE:

N.T.S.

LIGHTING

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DUL

RAB -

- SML2-5000

SURFACE-MOUNTED

35

FIRE ALARM SEQUENCE OF OPERATION Pull Station Area Smoke Activate Alarm At FACP Activate Notification Floor of Alarm Activate Notification Floor Above Transmit Alarm to Central Station

NOTES

- 1. ALL FIRE ALARM WIRING TO BE IN ACCORDANCE WITH NEC 2020 ARTICLE 760
 REQUIREMENTS, LOCAL AUTHORITIES AND APPLICABLE SECTIONS OF THE LOCAL
 BUILDING CODE.
 2. ALL EQUIPMENT SHALL BE INSTALLED AND CONNECTED IN ACCORDANCE WITH
 THE MANUFACTURERS RECOMMENDATIONS AND INSTRUCTIONS.
 3. ALL FIRE ALARM SYSTEM WIRING SHALL BE #16 AWG MINIMUM 200° PLENUM
 RATED CABLE RUN IN HUNG CEILINGS AND IN EMT WHERE NOT CONCEALED OR
 WHERE APPLICABLE BY CODES. MINIMUM CONDUIT SIZE SHALL BE 3/4".
 4. ALL CONDUCTORS TO BE FREE OF GROUNDS, OPENS, AND SHORTS.
 5. COORDINATE EXACT LOCATIONS OF ALL DEVICES AND CONDUIT ROUTING WITH
 ARCHITECT PRIOR TO INSTALLATION.
 6. MAINTAIN CONTINUITY OF FIRE ALARM SERVICE FOR ALL EXISTING SYSTEM
 DEVICES THROUGHOUT CONSTRUCTION PHASE OF THIS PROJECT.
 7. SUBMIT SHOP DRAWINGS OF DEVICES COMPATIBLE WITH EXISTING SYSTEM FOR
 APPROVAL.
 8. CONNECT CONTROLS WIRING FROM MECHANICAL SYSTEM EQUIPMENT, SUCH AS
 FIRE DAMPERS, DOOR HOLDERS/SHUTTERS, ETC TO THE NEW FIRE ALARM
- ICT CONTROLS WIRING FROM MECHANICAL SYSTEM EQUIPMENT, SUCH AS AMPERS, DOOR HOLDERS/SHUTTERS, ETC TO THE NEW FIRE ALARM OL PANEL, FACP.
 INSTALLING SHIELDED CABLE THE FOLLOWING MUST BE OBSERVED:
 ITALLIC CONTINUITY MUST BE MAINTAINED THROUGHOUT THE LENGTH OF
- 9.2
- E CABLE RUN.

 E CABLE SHIELD MUST BE ISOLATED FROM GROUND AND TERMINATED

 E CABLE SHIELD MUST BE ISOLATED FROM GROUND AND TERMINAL INDICATED ON

 LY IN THE ASSOCIATED CONTROL PANEL AT THE TERMINAL INDICATED ON

 E CONTROL PANEL DRAWINGS. THE REMOTE END OF THE SHIELD (AT

 E CONTROL PANEL DRAWINGS. THE REMOTE END OF THE SHIELD (AT

 DING MUST COMPLY WITH ARTICLE 250 OF THE NEC. GROUNDING

 CTOR MUST BE NO. 10 AWG, SINGLE-CONDUCTOR UNLESS OTHERWISE
- 10. GROUNDING MUST COMPLY WITH ARTICLE 250 OF THE NEC. GROUNDING CONDUCTOR MUST BE NO. 10 AWG, SINGLE-CONDUCTOR UNLESS OTHERWISE NOTED.

 11. ALL FIRE ALARM WIRING MUST BE INSTALLED SEPARATE FROM ANY 120VAC OR HIGHER WIRING.

 12. T-TAPPING IS NOT PERMITTED ON NOTIFICATION APPLIANCES CIRCUITS (NAC'S). ₹ WIRING. ING IS NOT PERMITTED ON NOTIFICATION APPLIANCES CIRCUITS (NAC'S).

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IMPROVEMENTS EVERETT PARK

BLOCK 707 - LOT 10

TOWNSHIP OF VERONA COUNTY OF ESSEX

STATE OF NEW JERSEY

ANTHONY KURUS, PE, PP

DRAFT

GRANT ENGINEERING CONSULTANTS, LLC

DNCESSION BUILDING POWER, LIGHTING AND IRE ALARM PLANS, PANELBOARD & LIGHTING IXTURE SCHEDULES, FIRE ALARM SYMBOLS, ISER DIAGRAM & SEQUENCE OF OPERATION

E101

- THE SPECIFICATIONS AND DRAWINGS ARE INTENDED TO SERVE THIS CONTRACTOR JOINTLY AS A BASIS UPON WHICH THE CONTRACTOR SHALL SUBMIT A CONTRACT PRICE FOR THE MATERIAL AND LABOR PROVISION.

 WHEN CONFLICTS OCCUR IN THE SPECIFICATIONS OR ON THE DRAWINGS OR BETWEEN EITHER, THE ITEMS OF GREATER QUANTITY OR HIGHER COST SHALL BE

THE CONTRACTOR SHALL PROVIDE ALL ITEMS OF LABOR OR MATERIALS NOT SPECIFICALLY INDICATED, BUT REQUIRED TO COMPLETE THE INTENDED INSTALLATION.

THE WORK UNDER THIS CONTRACT SHALL BE PERFORMED AND COORDINATED SIMULTANEOUSLY WITH WORK OF OTHER TRADES SO AS NOT TO DELAY THE OVERALL PROGRESS OF WORK.

THIS CONTRACTOR SHALL BE RESPONSIBLE FOR HIS WORK WITH ITS COMPLETION AND FINAL ACCEPTANCE AND SHALL REPLACE ANY OF SAME WHICH MAY BE DAMAGED, LOST OR STOLEN, WITHOUT ADDITIONAL COSTS TO THE OWNER. THE

GENERAL CONDITIONS

œ THE APPLICATION PROVISIONS OF THE GENERAL CONSTRUCTION SPECIFICATIONS SHALL APPLY TO THE SPECIFICATION ARTICLES.
PERFORM ALL WORK IN ACCORDANCE WITH ASHRAE, SMACNA, O.S.H.A. PERTINENT NFPA CODES AND THE RULES AND REGULATIONS OF ALL CITY, STATE AND FEDERAL AUTHORITIES HAVING JURISDICTION. PROVIDE OWNER WITH CERTIFICATES OF INSPECTION.
DO ALL NECESSARY CUTTING AND ROUGH PATCHING. THE FINISH PAINTING, POWER WIRING, AND FINAL PATCHING.

PATCHING.

THESE DRAWINGS INDICATE THE SIZE AND GENERAL LOCATION OF WORK. SCALED DIMENSIONS SHALL NOT BE USED. ANY DIMENSIONS NOT SHOWN SHALL BE OBTAINED FROM THE ARCHITECTURAL DRAWINGS. FOR EXACT LOCATIONS, CEILING HEIGHT, DOOR SWINGS, MOUNTING HEIGHT, REFLECTED CEILING PLAN, ETC., REFER TO ARCHITECTURAL DRAWINGS AND DETAILS. PRIOR TO STARTING ANY WORK, PURCHASING OF EQUIPMENT, ETC. COORDINATE THE WORK WITH OTHER TRADES. CONFER WITH OTHER CONTRACTORS WHOSE WORK MIGHT AFFECT THIS INSTALLATION AND ARRANGE ALL PARTS OF THIS WORK AND EQUIPMENT OF OTHERS WITH THE BUILDING CONSTRUCTION AND WITH ARCHITECTURAL FINISHES SO THAT IT WILL HARMONIZE IN SERVICE AND APPEARANCE. IN THE EVENT THERE IS A CONFLICT IN COORDINATION BETWEEN TRADES, THE OWNER WILL RESOLVE IT. ALL WORK SHALL BE GUARANTEED AGAINST DEFECTS FOR A MINIMUM PERIOD OF ONE YEAR, UNLESS OTHERWISE SPECIFIED, FROM THE DATE OF FINAL ACCEPTANCE OF THE INSTALLATION. ANY PORTIONS OF THE WORK WHICH DEVELOP DEFECTS DURING THAT TIME SHALL BE REPLACED OR REPAIRED IN MANNER SATISFACTORY TO THE ARCHITECT, AT NO ADDITIONAL COST TO THE OWNER.

1. SUBMIT TO THE OWNER. "AS—BUILT" PLANS AND SHOP DRAWINGS FOR ALL WORK INSTALLED.

2. ALL PARTS OF THE WORK AND ASSOCIATED DRAWINGS FOR ALL WORK INSTALLED.

3. FURNISH LIABILITY AND BE LEFT IN PERFECT OPERATING CONDITION.

CONDITION.

PRIOR TO SUBMITTING A BID FOR THE WORK AS PRIOR TO SPECIFIED, THE CONTRACTOR IS ADVISED TO VISIT THE PROJECT SITE TO FAMILIARIZE HIMSELF WITH EXISTING CONDITIONS. NO ALLOWANCE WILL BE AUTHORIZED FOR SITE CONDITIONS THAT COULD HAVE BEEN NOTED PRIOR TO BID SUBMISSION.

OPERATING AND MAINTENANCE INSTRUCTIONS

ALL MECHANICAL AND VENTILATION SYSTEM FANS NOT PART OF THE TESTED AND LISTED HVAC EQUIPMENT MEET EFFICACY AND AIR FLOW LIMITS PER TABLE R403.6.2, TESTED AND VERIFIED TO MEET MINIMUM FLOW RATES REQUIRED BY SECTION R403.6.

3. AFTER FINAL TEST AND ADJUSTMENTS FULLY INSTRUCT OWNER'S OPERATING PERSONNEL IN ALL DETAILS OF OPERATION FOR EQUIPMENT INSTALLED. A SIGNED RECEIPT OBTAINED FROM THE OPERATOR SHALL BE CONSTRUED AS EVIDENCE THAT INSTRUCTIONS WERE SATISFACTORY.

5. FURNISH THREE (3) COPIES OF WRITTEN DESCRIPTIONS OF ALL SYSTEMS COVERING ALL OPERATING PROCEDURES, AUTOMATIC CONTROL DESCRIPTIONS AND AUTOMATIC CONTROL TEMPERATURE AND PRESSURE SETTINGS. WRITTEN DESCRIPTIONS SHALL INCLUDE LUBRICATION SCHEDULES, PARTS LISTS, PERFORMANCE SERVICES FOR EQUIPMENT, FILTER SIZE/QUANTITY INSTRUCTIONS WHICH ARE UTILIZED SHALL BE CLEARLY MARKED TO INDICATE APPLICABILITY. PROVIDE MANUFACTURER MANUALS FOR MECHANICAL AND WATER HEATING SYSTEMS.

5. SHOP DRAWINGS SHALL BE REVIEWED AND SUBMITTED BY THE GENERAL CONTRACTOR. SHEET METAL AND PIPING DRAWINGS SHALL BE MINIMUM 3/8 INCH (OR LARGER) SCALE SHOWING ELEVATIONS, CLEARANCES, AND EQUIPMENT. NO MATERIAL SHALL BE FABRICATED AND/OR INSTALLED UNTIL SHOP DRAWINGS AND SHOP DETAILS HAVE BEEN REVIEWED AND ACCEPTED BY THE FURINFER.

CONTRACTOR NOT LIMITED

AIR DIFFUSERS, COMPLETE WITH SOUND RATINGS, CFM'PERFORMANCE DATA AND CONSTRUCTION FEATURES.
SHOP STANDARD DETAILS OF DUCTWORK FABRICATION, INCLUDING DAMPERS, ACCESS DOORS, ETC.
FLEXIBLE CONNECTORS.

EQUIPMENT SUCH AS: A/C UNITS, FANS, VALVES, ETC. TEMPERATURE CONTROL SYSTEM, INCLUDING DEVICES, SET-POINTS, CONTROL WIRING SCHEMATICS, PANEL LOCATIONS, POWER REQUIREMENTS AND SEQUENCE OF OPERATION.

BALANCING REPORTS FOR AIR SYSTEMS. NGERS, SUPPORTS, LAYOUT, ANCHORS AND CERTIFICATION WHEN REQUIRED. 유

INSULATION FOR DUCTWORK, AND EQUIPMENT.

EFFICIENCY HVAC PACKAGE; EFFICIENCIES >= 95 AFUE
GAS FURNACE, 16 SEER AIR CONDITIONER, 10 HSPF/16
SEER HEAT PUMP OF 3.5 COP GROUND SOURCE HEAT
PUMP.

THE CONTRACTOR SHALL OBTAIN THE SERVICES OF A TESTING AND BALANCING SUB—CONTRACTOR WITH AT LEAST 5 YEARS OF EXPERIENCE IN AIR AND WATER BALANCING. (AABC OR NEBB CERTIFIED)

THE BALANCER SHALL SUBMIT ALL BALANCING REPORTS DIRECTLY TO THE ENGINEER AS A SHOP DRAWING SUBMITTAL.

IF THE BALANCING SUB—CONTRACTOR FINDS THAT HE CANNOT BALANCE ANY SYSTEM OR PORTION THEREOF, HE SHALL IMMEDIATELY ADVISE THE ENGINEER IN WRITING AND SHALL STATE THE REASONS WHY BALANCING CANNOT BE ACHIEVED.

THE BALANCING SUB—CONTRACTOR SHALL MAKE ALL REQUIRED SYSTEM ADJUSTMENTS, AND SHALL ALSO FURNISH ALL LABOR, INSTRUMENTS, TEMPORARY CONNECTIONS AND ALL NECESSARY ACCESSORIES REQUIRED FOR PERFORMING SPECIFIED ADJUSTMENTS. AIR FLOW RATES SHALL BE BALANCED WITHIN A TOLERANCE OF PLUS OR MINUS 5 PERCENT AT THE FANS. WATER FLOW RATES ARE TO BE BALANCED TO A TOLERANCE OF PLUS 10% OR MINUS 5%.

RECORD DRAWINGS

FIVE SETS OF REPRODUCIBLE RECORD DRAWINGS
SHALL BE DELIVERED TO THE OWNER AND HIGHLAND
ASSOCIATES UPON WHICH CORRECTIONS SHALL BE
MADE TO PROVIDE AN ACCURATE AND COMPLETE
RECORD OF THE WORK AS INSTALLED.
SUBMIT AS—BUILT DRAWINGS ON CAD IN THE AUTOCAD
RELEASE 14 FORMAT UPON COMPLETION OF THE
PROJECT. SCANNED DRAWINGS ARE PROHIBITED.

PROVALS AND SUBSTITUTIONS

A. IT IS THE INTENT OF THESE SPECIFICATIONS THAT WHENEVER A MANUFACTURER IS SPECIFIED AND SUBSTITUTIONS ARE REQUESTED, THEY SHALL CONFORM IN ALL ASPECTS TO THE SPECIFIED ITEM. CRITERIA AS DELINEATED FOR EQUIPMENT SHALL BE INTERPRETED AS MINIMUM PERFORMANCE REQUIREMENTS.

B. IT SHALL BE MANDATORY FOR THIS CONTRACTOR TO SUBMIT HIS PROPOSAL PRICE BASED ON SPECIFIED MANUFACTURER OR SUPPLIER OF MATERIALS OR SERVICES. IF THE CONTRACTOR DESIRES TO SUBSTITUTE OTHER THAN SPECIFIED, HE SHALL SUBMIT SEPARATE PRICES FOR EACH OF THESE ITEMS FOR ADDITIONS OR DEDUCTION TO CONTRACT PROPOSAL PRICE FOR ACCEPTANCE OR REJECTIONS AT THE TIME WHEN BIDS ARE DUE. SHOULD THESE SUBSTITUTIONS BE REJECTED, THE CONTRACTOR SHALL BE REQUIRED TO PROVIDE SPECIFIED MATERIALS AND SERVICES.

SUBSTITUTED EQUIPMENT THAT CANNOT MEET SPACE REQUIREMENTS, WHETHER APPROVED OR NOT, SHALL BE REPLACED AT THE CONTRACTOR'S EXPENSE. ANY MODIFICATIONS OF RELATED SYSTEMS OR ADDITIONAL COSTS THAT RESULT FROM SUBSTITUTED EQUIPMENT SHALL BE BORNE BY THIS CONTRACTOR.

3. ALL BE BORNE BY THIS CONTRACTOR.

4. UNRISDICTION OVER THE WORK OF THIS PROJECT.

5. SECURE AND PAY FOR ALL PERMITS AND INSPECTION CERTIFICATES AND TRANSMIT SAME TO THE OWNER AT THIS CONTRACTOR SHALL PERMITS AND INSPECTIONS IN ACCORDANCE WITH THE LOCAL AUTHORITIES HAVING JURISDICTION.

WORK INCLUDED UNDER OTHER SECTIONS

A. ITEMS OF WORK INCLUDED UNDER O
THIS PROJECT ARE AS FOLLOWS:
GENERAL CONSTRUCTION
ELECTRICAL POWER WIRING
FIRE PROTECTION SYSTEMS ⋗

SHEET METAL DUCTWORK

ALL DUCTWORK AIR CHAMBERS, CASINGS, ENCLOSURES, DAMPERS AND ALL AUXILIARY DEVICES AND WORK NECESSARY TO MAKE THE VARIOUS AIR CONDITIONING AND VENTILATING SYSTEMS COMPLETE AND READY FOR

GALVANIZED
FACH SIDE IN

OCK-FORMING QUALITY. HAVING ZINC COATING OF ONFORMANCE WITH ASTM A90.

ABRICATE AND SUPPORT ALL DUCTWORK IN CCORDANCE WITH SMACNA APPLICABLE PRESSURE JUCT CONSTRUCTION STANDARD AND ASHRAE HANDBOOKS, EXCEPT AS MODIFIED HEREIN. PROVIDE JUCT MATERIAL GAUGES, REINFORCING AND SEALING CLASS C) FOR 2" PRESSURE CLASSIFICATION POSITIVE JUCT MATERIAL GAUGES, REINFORCING AND SEALING CLASS DOORS TO ALL CONCEALED ONTROLS, FUSIBLE LINKS, DAMPERS, ETC.

PROVIDE MANUAL DAMPERS IN EACH SPLIT OR TAPONNECTION TO TRUNK DUCTS FOR BALANCING PROPOSES, EACH PROVIDED WITH OPERATOR AND OCKING DEVICE.

ANGLES AND OTHER STRUCTURAL SHAPES USED IN ONNECTION WITH BOTH STEEL AND ALUMINUM SHEETS HALL BE J/8" MINIMUM HOT ROLLED MILL STEEL.

PROVIDE FIRE DAMPERS AND/OR FIRE—SMOKE DAMPERS WITH ACCESS DOORS WHERE SHOWN ON DRAWINGS. FIRE DAMPERS SHALL BE "RUSKIN" OR AS APPROVED. DAMPERS SHALL BE "RUSKIN" OR AS APPROVED. DAMPERS SHALL BE THE REQUIREMENTS OF NFPA BULLETIN NO. 90A, AND LOCAL BUILDING CODE.

NSULATED FLEXIBLE DUCTWORK WITH VAPOR BARRIER NSULATED FLEXIBLE DUCTWORK WITH VAPOR BARRIER OF CEILING DIFFUSERS. FLEXIBLE DUCT SHALL NOT EXCEED 3 FEET IN LENGTH, WITH CONSTRUCTION CONFORMING TO NFPA 90A AND UL181.

NSULATED FLEXIBLE DUCTS, VINYL IMPREGNATED IBERGLASS FABRIC SUPPORTED BY HELICALLY WOUND PRING STEEL WIRE OR FLAT STEEL BANDS RATED TO INCHES WG POSITIVE AND 15 INCHES WG NEGATIVE, WRAPPED WITH FLEXIBLE GLASS FIBER INSULATION, NCLOSED BY SEAMLESS ALUMINUM PIGMENTED LASTIC VAPOR BARRIER JACKET MAXIMUM 0.23K ALUE AT 75 DEGREES F.

CTWORK LAYOUTS AND ROUTES AS SHOWN ON THE AWINGS ARE SCHEMATIC. THEREFORE, CHANGES IN CT SIZES AND/OR LOCATIONS SHALL BE MADE ERE NECESSARY TO CONFORM TO SPACE NDITIONS OR TO OBTAIN MAXIMUM HEADROOM NDITIONS WITHOUT ADDITIONAL COSTS TO THE

GAUGE SHALL BE " 4. DRIVE SLIPS AND " AND "NOT CLIPS ARE

ATE WITH ALL AFFECTED TRADES TO ENSURE CEILINGS, EQUIPMENT OR OTHER MATERIALS HAN AS SPECIFICALLY PROVIDED HEREIN ARE ED FROM DUCTWORK OR THE DUCTWORK SYSTEM.

MAKE JOINTS AND SEAMS SMOOTH ON THE INSIDE AND MAKE JOINTS AND SEAMS SMOOTH ON THE INSIDE AND A NEAT FINISH ON THE OUTSIDE. DUCT JOINTS SHALL BE AIRTIGHT WITH LAPS MADE IN THE DIRECTION OF AIR FLOW AND NO FLANGES PROJECTING INTO THE AIR STREAM. DUCTS SHALL BE ADEQUATELY BRACED TO PREVENT VIBRATION. PROVIDE ADDITIONAL BRACING WHERE NECESSARY.

ALL JOINTS SHALL BE SEALED USING DUCT SEALER SIMILAR TO FOSTER 32 – 50.

PROVIDE AN AIRTIGHT FABRIC NECK AT THE INLET AND OUTLET CONNECTIONS OF AIR HANDLING SYSTEMS.

NECKS SHALL BE NOT LESS THAN 3" NOR MORE THAN 10" IN WIDTH AND BOTH SIDES SHALL BE SECURED WITH CRIMPED LOCK SEAMS THE ENTIRE PERIMETER WITH GALVANIZED STEEL SHEET BANDS 3" WIDE.

NECK FABRIC SHALL BE CLOSE WOVEN GLASS CLOTH, DOUBLE NEOPRENE COATED, 28-OUNCES PER SQUARE YARD MINIMUM WEIGHT.

RD MINIMUM WEIGHT.
ICTS, AIR HANDLERS, AND FILTER BOXES ARE
ALED WITH JOINTS/SEEMS COMPLIANT WITH
TERNATIONAL MECHANICAL CODE OR INTERNATIONAL
SIDENTIAL CODE, AS APPLICABLE.

REGISTERS AND DIFFUSERS

NO REGISTERS AS SILLES AND REGISTERS SCHEDULE OF DIFFUSERS, GRILLES AND REGISTERS WITH MANUFACTURERS MODELS, SIZES ACCESSORIES, INISHES ETC., SHALL BE SUBMITTED FOR REVIEW RIOR TO RELEASE FOR FABRICATION AND DELIVERY. REFER TO SCHEDULE OR NOTES ON DRAWINGS FOR TYPE, UNLESS BUILDING STANDARD AIR DEVICES ARE DIFFUSERS AND GRILLES SHALL IFORMANCE WITH ARCHITECTURAL H AND INSTALL ALL METAL DIFFUSERS, GISTERS AS SPECIFIED. L REFLECTED IN

CORD OPERATED DAMPERS FOR BRANCH DUCTWORK BALANCING

EXPOSED

JACKET

CONDENSER

JACKET

E: ALL SUPPLY DUCTWORK, NEW AND EN CONTRACT LIMITS SHALL BE INSULATE ERWISE NOTED. RETURN DUCTWORK SHALL BE INSULATED ILATED WHEN SO SPECIFIED. SUPPLY AND IS IN ATTICS INSULATED >= R-8, WHERE IN ATTICS INSULATED OR >= R-6 WHERE IN DIAMETER OR PER IN DIAMET ND EXISTING
JLATED UNLESS
SHALL BE
' AND RETURN
WHERE DUCT IS
WHERE <3

PERFORM ALL WORK IN STRICT ACCORDANCE WITH MANUFACTURERS' RECOMMENDATIONS.

SEAL ALL VAPOR BARRIERS TO PREVENT MOISTURE PENETRATION.

EXPOSED DUCTWORK TO ELEMENT SHALL BE WRAPPED 2" INSULATION WITH TWO LAYERS OF BITUMINOUS ROOFING FELT AND TWO COATS OF BITUMINOUS.

HVAC PIPING CONVEYING FLUIDS ABOVE 105 DEGREES F OR CHILLED FLUIDS BELOW 55 DEGREES F ARE INSULATED TO >= R-3.

AND SPECIFIED HEREIN.

ACOUSTIC LINING: ACOUSTIC LINE ALL DUCTWORK,

SUPPLY AND RETURN WITHIN MECHANICAL EQUIPMENT
ROOMS, OR A DISTANCE OF NOT LESS THAN 15'-0"
FROM SYSTEM FANS, OR AS SHOWN ON DRAWING.

LINING SHALL BE 1-1/2 LB PER CU. FT. DENSITY,

OWENS CORNING, JOHNS MANSVILLE, KNAUF, OR

CERTAINTEED WITH A MINIMUM THICKNESS OF 1",

EXCEPT AS MODIFIED HEREIN OR ON DRAWINGS. LINING
SHALL BE COATED TO PREVENT FIBER DETERIORATION
AT VELOCITIES BELOW 2000 FPM.

DUCT SIZES INDICATED ON DRAWINGS ARE CLEAR,
INSIDE DIMENSIONS WITHOUT THE ACOUSTICAL LINING

DISTRIBUTION SYSTEM INSTALLATION

DUCTWORK.

DUCTWORK.

PROVIDE GALVANIZED ANGLE IRON AND BANDS PROVIDE HANGER INSERTS SUITABLE FOR THE PROVIDE HANGER INSERTS SUITABLE FOR THE STRUCTURE FROM WHICH THE DUCTS WILL BE HUNG. INSERTS SHALL NOT BE PERMITTED IN "CINDER CONCRETE" SLABS. HUNG.

L — FURNISH AND INSTALL THERMAL TION AS SPECIFIED IN THIS SECTION.

TION SHALL BE MANUFACTURED BY OWENS

G, MANSVILLE, CERTAINTEED OR APPROVED

ALL INSTALLED INSULATION IS LABELED AND

STALLED R—VALUES PROVIDED.

ISSARY TO ACCOMMODATE CONTENTS

SSARY TO ACCOMMODATE CONTENTS

TO FIELD CONDITIONS.

PE ALL CHANGES IN DIRECTION, BOTH HORIZONTAL VERTICAL, TO PERMIT THE EASIEST POSSIBLE AIR VOR USE SQUARE DOUBLE VANED ELBOWS.

T DIMENSIONS OF OPENINGS MUST AWAIT REVIEW REGISTERS AND DIFFUSERS. EXACT LOCATIONS LL BE SUBMITTED FOR REVIEW. REGISTER BOXES OTHER OPENINGS OF THE DUCTWORK MUST BE ITLY CLOSED DURING CONSTRUCTION TO KEEP DIRT, T AND OTHER FORMS OF RUBBISH OUT OF THE

CASES

CONCRETE" SLABS.
PROVIDE DOUBLE THICK TURNING VANES PROVIDE DOUBLE THICK TURNING VANES WHERE 90° DEGREE SQUARE ELBOWS ARI AIR HANDLER LEAKAGE DESIGNATED BY MANUFACTURER AT <=2% OF DESIGN AIF

₩TH

ED, SET-POINTS, PHYSICAL LAYOUT, LOCATION OR ALL EQUIPMENT SUCH AS THERMOSTATS, PANELS, STARTERS, ETC., OF DEVICES SHALL ITTED PRIOR TO INSTALLATION FOR REVIEW OWNER, ENGINEER, AND ARCHITECT AS INSTALLATION OF DEVICES SHALL NOT UNTIL REVIEWED.

ONE YEAR FREE SERVICE AND GUARANTEE OF TURE CONTROL SYSTEM.

ALL NECESSARY WIRING DIAGRAMS AND SEQUENCE FOR THE COMPLETE SYSTEM.

MOUNTAINSIDE

200 CENTRAL AVENUE, SUITE 102

MOUNTAINSIDE

NEW JERSEY 07092

PHONE: 201.939.8805

FAX: 732.943.7249

NEGLIAGROUP.COM

W SHALL BE PROVIDED WITH

SMOKE DETEC
PLENUM AT U
SYSTEM. MECH
INSTALL DUCT
CONTROL PAN
CONTROL PAN COOLING DIGITAL THERMOSTAT WITH TIME REEKEND AND NIGHT SET BACK FEATURES FIOR IN RETURN DUCT AFTER FILTER AIR INIT AND INTERFACED WITH THE ALARM ANICAL CONTRACTOR SHALL PROVIDE AND SMOKE DETECTOR. PROVIDE A LOCKABLE JEL. LOCATE ALL CONTROLS IN NITS SUPPLIED WITH CERTAIN CONTROL H SHALL BE INTEGRATED WITH OTHER TEMS NECESSARY TO OBTAIN A FULLY SYSTEM AS DESCRIBED HEREIN.

LYNDHURST

34 PARK AVENUE, PO BOX 426

LYNDHURST

NEW JERSEY 07071

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FAX: 201.939.0846

INFO@NEGLIAGROUP.COM

VIBRATION ISOLATION

FURNISH VIBRATION ISOLATION DEVICES FOR ALL EQUIPMENT WITH ROTATING MOTORS AND FANS. DEVICES SHALL BE SUITABLE FOR NOT LESS THEN 95 ISOLATION.

DEVICES INSTALLED SUBJECT TO OUTDOOR WEATHER

DEVICES INSTALLED SUBJECT TO OUTDOOR WEATHER CONDITIONS SHALL BE SUITABLY PROTECTED TO PREVENT CORROSION ISOLATION SHALL BE PROVIDED FOR ALL PIPING AND PUMPS WITHIN MECHANICAL EQUIPMENT ROOMS, AND/OR NOT LESS THAN 50' FROM PUMPS AND FANS, AND/OR BETWEEN ALL MECHANICAL EQUIPMENT AND BUILDING STRUCTURE UNLESS OTHERWISE NOTED OR SHOWN ON DRAWINGS.

										1		1
		\ ™	T	~ \ \ \ \ \ \	\\\\\\\\\\\\\\\\\\\\\\\\\\\\\\\\\\\\\\	7 2						
		VOLUME DAMPER	THERMOSTAT	TOILET EXHAUST FAN	SUPPLY DUCTWORK/GRILLE	RETURN/EXHAUST REGISTER/GRILLE	NEW WORK (SINGLE LINE)	ENERGY RECOVERY VENTILATOR	ELECTRIC UNIT HEATER	MINI SPLIT CONDENSING UNIT	MINI SPLIT AIR HANDLING UNIT	SYMBOL LIST
EF	OA	TEF	SP	SG	RG	EUH	8	CFM	MSCU	MSAHU	ERV	Ä
EXHAUST FAN	OUTSIDE AIR	TOILET EXHAUST FAN	STATIC PRESSURE	SUPPLY DIFFUSER	RETURN REGISTER	ELECTRIC UNIT HEATER	DIAMETER	CUBIC FEET PER MINUTE	MINI-SPLIT CONDENSING UNIT	MINI-SPLIT AIR HANDLING UNIT	ENERGY RECOVERY VENTILATOR	

ST SHOWN ABOVE IS FOR GENERAL REFERENCE ONLY, THE PRESENCE OF A SYMBOL DOES ITS USE ON THIS PROJECT. REFER TO DRAWINGS FOR SPECIFIC SYMBOLS USED.

APPLICABLE CODES

INTERNATIONAL NEW JERSEY BUILDING CODES: MECHANICAL CODE

INTERNATIONAL STANDARD PLUMBING CODE

> DRAWN DESIGNED CHECKED NEGLIA G
> EXPERIENCED DEDICATED **NEGLIA GROUP**

EVERETT PARK

DRAFT

PRODUCT OF

IMPROVEMENTS

TOWNSHIP OF VERONA STATE OF NEW JERSEY BLOCK 707 - LOT 10 COUNTY OF ESSEX

ANTHONY KURUS, PE, PP


DRAFT

GRANT ENGINEERING
CONSULTANTS, LLC DODD STREET EN RIDGE, NJ 07028 862 702.3637 F: 862.


MECHANICAL NOTES, SYMBOLS & ABBREVIATIONS


M001

RID GHAEMI, PE

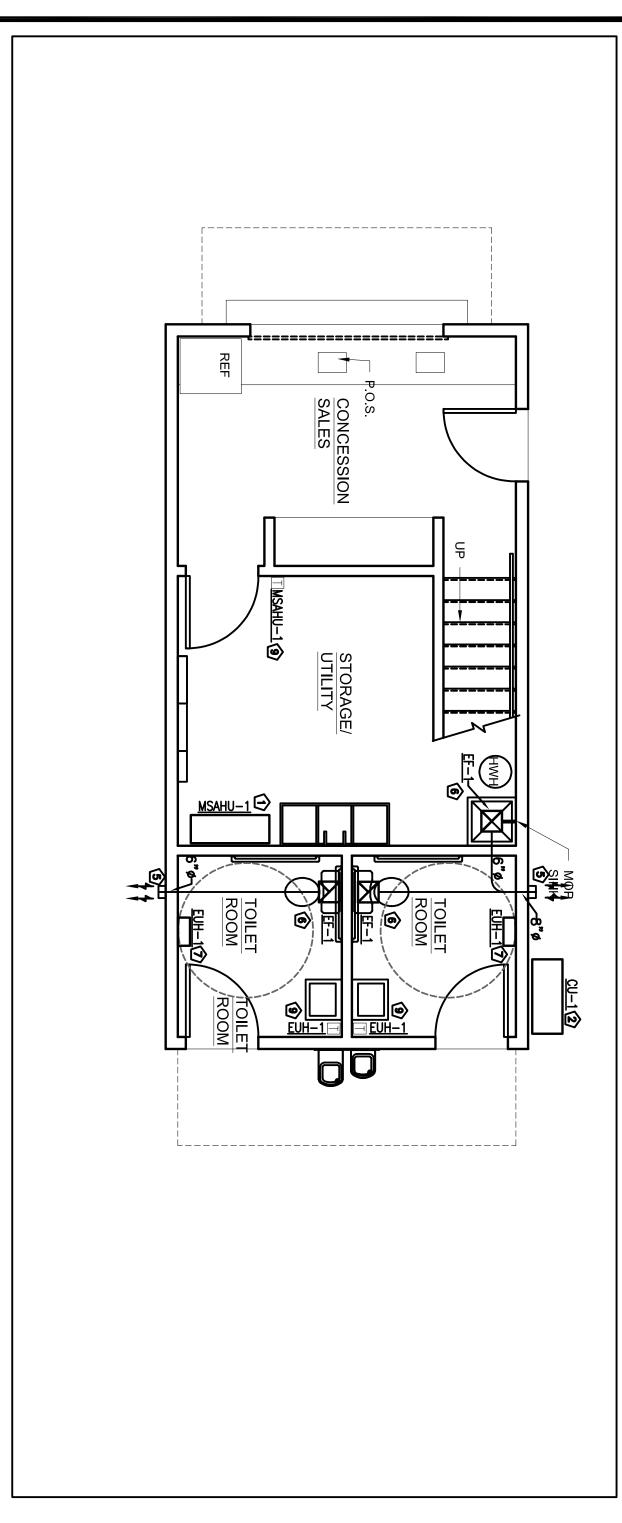

SCALE: CONCES 1/4" O, BUILDING .00R HVAC

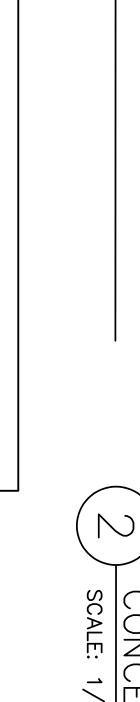

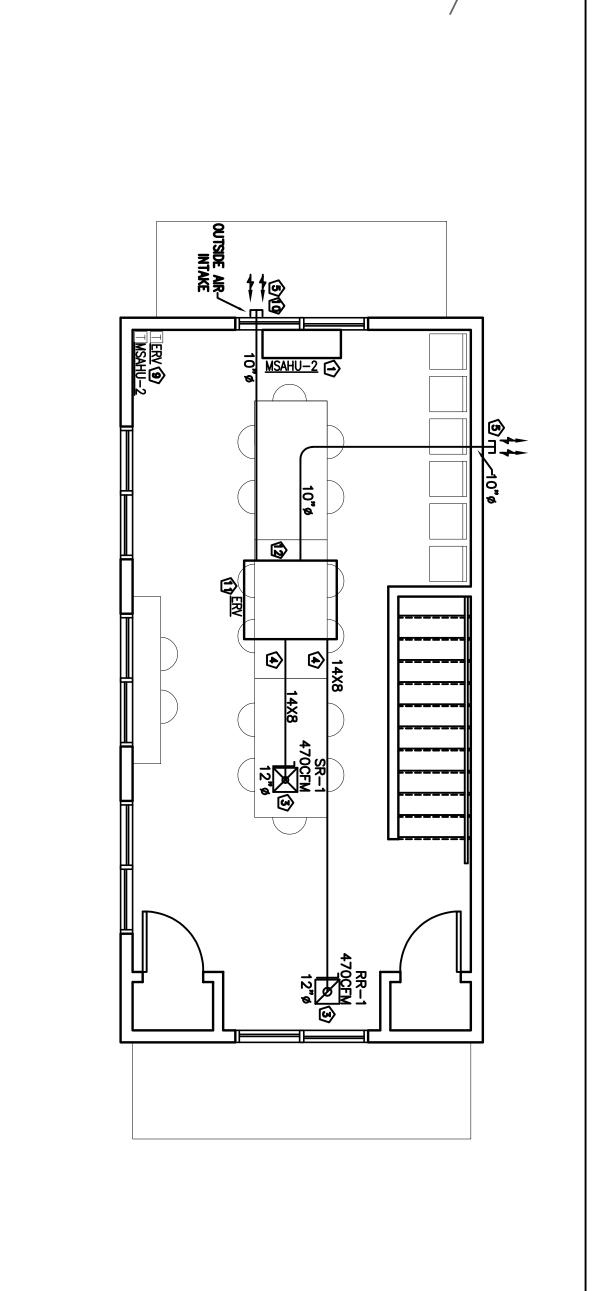

NEGLIA GROUP
EXPERIENCED DEDICATED RESPONSIVE

MOUNTAINSIDE

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CONCESSION 1'-0" BUILDING 2ND FLOOR

HVAC

OPERATE AS PER INTENDED OUTSIDE AIR VENTILATION UNIT AND ACCESSORIES TO OPERATE AS PER INTENDED OUTSIDE AIR VENTILATION RATE, FOR A COMPLETE AND OPERABLE HVAC SYSTEM, PER SCHEDULE AND AS SHOWN ON PLANS. NOTIFY OWNER'S REPRESENTATIVE OF ANY DISCREPANCIES PRIOR TO BID/INSTALLATION. STANDARD III WIRED REMOTE CONTROLLER ACCESSORY, PREMTB100, TO BE PROVIDED AND INSTALLED. PROVIDE/INSTALL CEILING ACCESS PANELS FOR REQUIRED, PERIODIC MAINTENANCE. CONFIRM LOCATION AND FINISH WITH OWNER'S REPRESENTATIVE. ERV UNIT OUTSIDE AIR INTAKE SHALL BE A MINIMUM OF TEN (10) FEET FROM ANY EXHAUST AIR DISCHARGE. 22 ERV UNIT EXHAUST AIR DISCHARGE AND OUTSIDE AIR INTAKE DUCTWORK OUTWARD THROUGH 2ND LEVEL CEILING SPACE THROUGH ASSOCIATED WALL CAPS. REFER TO SCHEDULE FOR ROOF CAP MANUFACTURER INFORMATION. CONFIRM LOCATION AND FINISH WITH OWNER'S REPRESENTATIVE. OUTSIDE AIR INTAKE MUST BE MINIMUM OF TEN (10) FEET FROM ANY EXHAUST DISCHARGE. REFER TO SCHEDULE FOR ROOF CAP & WALL CAP MANUFACTURER INFORMATION; CONFIRM FINAL LOCATION AND FINISH WITH OWNER'S REPRESENTATIVE.

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SCALE:

N.T.S.

MECHANIC

5 DUCTLESS

SUPPLY THE OF THE PROPERTY OF

OUTDOOR SIDE DUCT GRADIENT SLOPED TO PREVENT RAINWATER PENETRATION

8 ENERGY RECOVERY

MOULAR DUCTI (0.022 N.) (0.028 N.) (0.034 N.) (0.044 N.) (0.062 N.)

0AUGE 0AUGE

S DUCT STEEL MN OAL
DAMETER NCHES SHT. GAUGE
THROUGH 12 29 (0.019 N.)
13 THROUGH 28 24 (0.022 N.)
19 THROUGH 28 24 (0.023 N.)
29 THROUGH 38 22 (0.034 N.)
37 THROUGH 32 20 (0.040 N.)

ZAM DUCT STEEL NAM GALV. SHT. GALGE 28 (0.022 H.) 24 (0.028 H.) 22 (0.034 H.) 20 (0.040 H.) 18 (0.062 H.)

35 STEEL MAN.
SHT. GAUGE
(0.022 N.)
(0.025 N.)
(0.034 N.)
(0.040 N.)
(0.062 N.)

NOTES:
VOLUME CONTROL SHOULD BE BY
BRANCH DAMPERS. IF SPLITTER
NCLIOED IN DESIGN, SPLITTER
LENGTH 2 1.5W OR 1.5D

3 PROVIDE, ON PLAN

INSTALL AIR DEVICE AND MANUAL VOLUME DAMPER PER SCHEDULE AND AS NS.

NAOHS

DRAFT

PRODUCT OF

(2) PROVIDE/INSTALL NEW CONDENSER UNIT AND ACCESSORIES FOR A COMPLETE AND OPERABLE SYSTEM AS SHOWN ON PLANS. MAINTAIN MANUFACTURER CLEARANCES CONDENSING UNITS REQUIRE NEOPRENE VIBRATION PADS ON RATED CONCRETE SLAB. NOTIFY OWNER'S REPRESENTATIVE OF ANY DISCREPANCIES PRIOR TO BID/INSTALLATION

PROVIDE/INSTALL NEW WALL MOUNTED DUCTLESS MINI-SPLIT AIR HANDLER UNIT
AND ACCESSORIES FOR A COMPLETE AND OPERABLE HVAC SYSTEM PER SCHEDULE AND AS
SHOWN ON PLANS. NOTIFY OWNER'S REPRESENTATIVE OF ANY DISCREPANCIES PRIOR TO
BID/INSTALLATION. INSTALL CONDENSATE DRAIN PIPING TO THE NEAREST SINK DRAIN, ABOVE
THE TRAP. REFER TO PLUMBING DRAWINGS FOR EXACT LOCATION.

KEY NOTES

REVISION

DRAWN DESIGNED CHECKED

PROVIDE/INSTALL NEW SUPPLY, RETURN, AND OUTSIDE AIR DUCTWORK AND INSULATION AS REQUIRED BY CODE. SUPPLY AND RETURN AIR OUTLETS CAN BE CONNECTED TO FLEX OR RIGID DUCT, DEPENDING ON AVAILABLE CEILING SPACE AND ASSOCIATED BRANCH DUCT DIMENSION REQUIREMENTS. FLEX DUCT THROUGHOUT CORRIDORS MUST REMAIN UNDER 5 FEET IN LENGTH. PROVIDE/INSTALL RATED FIRE DAMPERS AT HORIZONTAL DUCTWORK PENETRATIONS THROUGH FIRE RATED WALLS OR STRUCTURES. FIELD VERIFY AVAILABLE CEILING SPACE AND NOTIFY OWNER'S REPRESENTATIVE OF ANY DISCREPANCIES.

SEAL ALL SUCH CONNEC.

2 ROUND DL

3) TYPICAL DUCT DETAILS

PARALLEL FLOW BRANCH DETAILS

- METAL STRAP CLAMP (TYPICAL) 2 PLACES

RETURN AIR -

DEFINE
DUCT HE RE N A
WITH TH
RE AS
JURSIN
TO LES. IT'S 18 QA. MIN (DUCTS OVER 2 SQ. FT.) MAX.
700 LES. IT'S 18 QA. MIN (DUCTS OVER 40" NOE.
THE NAME ASTON DUCTS OVER 40" NOE.
THE N

DUCT SIZE
36" DIA. MAX
MAX WEIGHT PER
FOOT = 16 LBS.

® PROVIDE/INSTALL CEILING CABINET EXHAUST FAN PER SCHEDULE AND MANUFACTURER SPECIFICATIONS. 6"0/8"0 EXHAUST DISCHARGE TERMINATION OUTWARD THROUGH WALL OPEROVIDE MANUAL TOGGLE SWITCH FOR MOP SINK EXHAUST FAN CONTROL. RESTROOM EXHAUST FANS TO BE CONTROLLED VIA LIGHT SWITCH. EXHAUST AIR DISCHARGE MUST MINIMUM OF TEN (10) FEET FROM ANY OUTSIDE AIR INTAKE. (S) PROVIDE/INSTALL NEW FIRE BARRIER DUCT WRAP PER SCHEDULE. INSTALL PER MANUFACTURER INSTALLATION SPECIFICATIONS AND LOCAL CODE HAVING JURISDICTION. CAP.

NEGLIA GROUP

EVERETT PARK

BE

IMPROVEMENTS

BLOCK 707 - LOT 10

TOWNSHIP OF VERONA COUNTY OF ESSEX

THERMOSTAT PER SCHEDULE. INSTALL 5'-0" FROM THE FLOOR. PROVIDE LOCKABLE COVER. COORDINATE FINAL LOCATION AND TEMPERATURE SET POINTS WITH OWNER'S REPRESENTATIVE, PRIOR TO INSTALLATION.

PROVIDE/INSTALL NEW WALL MOUNTED ELECTRIC UNIT HEATER. REFER TO MANUFACTURER SPECIFICATIONS FOR WALL MOUNTING POSITION AND REQUIRED HARDWARE. CONFIRM FINAL LOCATIONS AND THERMOSTAT SET POINTS WITH OWNER'S REPRESENTATIVE.

® NOT USED.

STATE OF NEW JERSEY

ANTHONY KURUS, PE, PP

GRANT ENGINEERING CONSULTANTS, LLC CONSULTANTS,

)ODD STREET EN RIDGE, NJ 07028 122 702 3637 F: 862.7 ID GHAEMI, PE

CONCESSION BUILDING HVAC FLOOR PLANS, KEY NOTES, & DETAILS

M100

SCALE: MECHANIC N.T.S. \geq



	1-5	148.0	2.8	1/471/338 0.80/0.44/0.24 208~230/1/60	0.80/0.44/0.24	471/471/338	470	LG ARVU053ZEA2	RESIDENTIAL UNITS	ERV
- [REMARKS	WEIGHT (LB)	RATED AMPS (AMP)	VOLT/PH/HZ	E.S.P. (IN. W.G.) (SH/H/L)	AIR FLOW RATE (CFM) (SH/H/L)	NOMINAL CAPACITY (CFM)	MODEL #	LOCATION	# CZ
" D		i i	DATA	ELECTRIC		UNIT DATA				
<u>=</u>				ENERGY RECOVERY VENTILATOR SCHEDULE	TILATOR S	/ERY VEN	RECO\	ENERGY		

BASIS OF DEIGN:

NEW ENERGY RECOVERY VENTILATOR UNIT WIT HAIR TO AIR HEAT EXHCHANGER TO PROVIDE HEAT AND ENTHALPY EXCHANGE TO SERVE ASSOCIATED RESIDENTIAL SUPPLY AND RETURN AIR IN CONJUNCTION WITH OUTSIDE AIR INTAKE AND EXHAUST AIR. ERV US SHALL ENGAGE OPERATION UPON ACTIVATION OF ASSOCIATED DUCTLESS MINI-SPLIT AIR HANDLING UNIT, MSAHU-2. CNIT

"EWC"

STANDARDS

REMARKS:

- -CONTRACTOR SHALL PROVIDE/INSTALL NEW CONDENSING UNIT AND ACCESSORIES FOR A COMPLETE AND OPERABLE SYSTEM AS SHOWN ON PLANS. INSTALL PER LOCAL CODE HAVING JURISDICTION. HVAC
- MAINTAIN MANUFACTURER SPECIFIED CLEARANCES.

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- PROVIDE/INSTALL ENERGY RECOVERY VENTILATION SYSTEM AS SHOWN ON PLANS. MANUFACTURER INSTALLATION INSTRUCTION AND OWNER'S REPRESENTATIVE. FOR **ADDITIONAL** INFORMATION FE S 70
- 4. PROVIDE/INSTALL BOTH PRE-FILTERS AND MERV-13 FILTER AS PER MANUFACTURER DIMENSIONS ₽ND **SPECIFCIATIO** NS.
- STANDARD III WIRED REMOTE CONTROLLER PREMTB100.

Ŋ

	WA	LL MOUN.	TED	ELECTRI	WALL MOUNTED ELECTRIC UNIT HEATER SCHEDULE	ATER S	CHED	ULE		
					ELECTRIC DATA		HEATING CAPACITY	CAPACITY		
#UNIT	SERVICE	MANUTACIORER MODEL #	CFM	AMPS	VOLT/PH/HZ FAN MOTOR SIZE (HP)	FAN MOTOR SIZE (HP)	(kW)	(BTUh)	WEIGHT (LBS)	(kW) (BTUh) (LBS) REMARKS
EUH-1	RESTROOMS	QMARK MUH0321	350	11.0/12.5	208/240/1/60 1/100		2.2/3.0	2.2/3.0 7.5/10.2 N/A 1-3	N/A	1-3

REMARKS:

- PROVIDE/INSTALL WALL MOUNTED THERMOSTAT, SET **@** 70 DEG. Ψ.
- REFER TO MANUFACTURER SPECIFICATIONS OPERATION OF UNIT AND ACCESSORIES. REGARDING WALL MOUNTING CONFIGURATION, HEIGHT, INSTALLATION,
- CONFIRM FINAL HEATER LOCATIONS AND **THERMOSTAT TEMPERATURE** SET-POINT W∏H OWNER'S REPRESENTATIVE

MOP SINK & RESTROOMS	SERVICE			
PANASONIC FV-0511VKS2	MODEL #	MANUFACTURER		
80	CFM	PERFORM/		
0.125	SP TOTAL (IN WG)	PERFORMANCE DATA	FAN SCH	
CEILING	TYPE		AN SCHEDULE	
DIRECT	DRIVE	FAN DATA		
1280	RPM			
120/1/60	VOLT/PH/HZ	MOTOR D		
1/10	HP	ATA		
7	(LB)	WFIGHT		
1,2		RFMARKS		

REMARKS:

TINO

#

- PLUG DISCONNECT AND FACTORY MOUNTED BACK-DRAFT DAMPER.
- UNIT CONTROLLED BY LIGHT SWITCH.

OUTSIDE AIR INTAKE WALL CAP SCHEDUL THE OUTSIDE AIR INTAKE WALL VENT CAP SHALL BE MANUFACTURED BY FAMCO, MODEL: "PLASTIC WALL VENT WITH FIXED LOUVERS", 10"ø, OR APPROVED EQUIVALENT. EXHAUST VENTILATION GRILLE IS UL 723/ASTM E84 STANDARDS COMPLIANT. CAP SCHEDULE

N.T.S. MECHA <u>Z</u> SCH IEDUL

MSCU-1

OUTDOOR

LMU361HHV

Ö

4238

1.6

× 2

22.0

50,000

47,000

208~230/1/60

40.0

MSAHU-

BASIS

OF DEIGN:

#UNIT

LOCATION

MANUFACTURER
MODEL #

SNOT

TOTAL CFM

FAN MOTOR
(A)

COMPRESSOR

HEATING (BTU/H)

MAX

COOLING CAPACITY

ELECTRIC

DATA

(BTU/H)

₽ ₩

VOLT/PH/HZ

MCA (AMP)

MOP (AMP)

WEIGHT (LBS)

INDOOR

STINU

SERVED

REMARKS

<u>S</u>

SPLIT

CONDENSING UNIT SCHEDULE

REMARKS:

NEW OUTDOOR DUCTLESS MINI-SPLIT CONDENSING UNITS TO SERVE ASSOCIATED WALL MOUNTED MINI-SPLIT AIR HANDLING UNITS. REFER TO MANUFACTURER INSTALLATION. RATED CAPACITY IS BASED ON 95°F DB/75°F WB OUTDOOR TEMPERATURE. AS PER 2021 EPA REQUIREMENTS, R410A IS NO LONGER ALLOWED 1ST, 2025, OR LATER. TWO-PORT BRANCH DISTRIBUTION UNIT REQUIRED FOR INSTALLATION, MODEL# LG PMBD3620.

3

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8 INCH LIQUID LINE

AND 3 INCH GAS

LINE.

4.

COORDINATE DISCONNECT SWITCH WITH ELECTRICAL

CONTRACTOR.

AS

SHOWN ON PLANS.

FOR ADDITIONAL INFORMATION REFER

T0

MANUFACTURER

SPECIFICATIONS AND OWNER'S

REPRESENTATIVE.

PROVIDE/INSTALL CONDENSING UNIT ON ROOF LEVEL

MAINTAIN MANUFACTURER SPECIFIED CLEARANCES.

CONTRACTOR SHALL PROVIDE/INSTALL JURISDICTION.

NEW CONDENSING UNIT

AND

ACCESSORIES

FOR

➤

COMPLETE

AND

OPERABLE

YSTEM

AS

SHOWN ON

PLANS.

INSTALL

PER

LOCAL

CODE

5

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FIRE BARRIER DUCT WRAP SCHEDULE BDW. THE 1 HOUR FIRE BARRIER VENTILATION

BY 3M MODEL#: FIRESTOP WRAP

615+48, OR APPROVED EQUIVALENT.

FIRE BARRIER DRYER VENTILATION WRAP

MUST MEET THE REQUIREMENTS FOR

FIRE PROTECTION. FIRE BARRIER DRYER

VENTILATION WRAP IS UL 1479/NFPA

96/NFPA 92A/NFPA 92B/ISO

6944-1985/ASTM E814 APPROVED.

THE EXHAUST WALL VENT CAP SHALL E MANUFACTURED BY BROAN MODEL#: 64 "6"ø/8"ø/10"ø, OR APPROVED EQUIVALENT. EXHAUST VENTILATION GRILLE IS UL 723/ASTM E84 STANDARI COMPLIANT. XHAUST WALL CAP SCHEDULE

		AIR DEVICE SC		HEDULE		
UNIT	TYPE	MANUFACTURER MODEL #	SIZE (IN)	MOUNTING	MATERIAL	REMARKS
SR-1	SUPPLY DIFFUSER	TITUS 250	16X16	CEILING	STEEL	1,2
RR-1	RETURN REGISTER	TITUS 350	12X12	CEILING	STEEL	1,4

MOUNTAINSIDE

200 CENTRAL AVENUE, SUITE 102 MOUNTAINSIDE

NEW JERSEY 07092

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REMARKS:

- FINISH BY ARCHITECT.
- CONSTRUCTION **CURVED** BLADE CEILING DIFFUSER WITH 4-WAY DISCHARGE.
- STEEL CONSTRUCTION LOUVERED RETURN REGISTER WITH MODEL AG-15 OPPOSED BLADE DAMPER.
- SUPPLY AND RETURN AIR OUTL AVAILABLE CEILING SPACE AND MANUAL VOLUME DAMPERS FOR REPRESENTATIVE. FOR ETS CAN BE CONNECTED TO FLEX OR RIGID DUCT, CONDITIONAL ON ASSOCIATED BRANCH DUCT DIMENSION REQUIREMENTS. PROVIDE ALL AIR OUTLETS. REPORT ANY DISCREPANCIES TO OWNER'S

LYNDHURST 34 PARK AVENUE, PO BOX 426

> LYNDHURST NEW JERSEY 07071

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MINI SPLIT AIR HANDLER **SCHEDULE**

			H) -	1	NOMINAL CAPACITY	CAPACITY	ELECTRIC	DATA	
UNIT #	LOCATION	MODEL NUMBER	ON	CFM	COOLING	HEATING	VOLT/PH/HZ	RATED	WEIGHT
					(BTU/H)	(BTU/H)	***************************************	AMPS	(LBS)
MSAHU-1	1ST STORAGE	LG LSN181HSV5	1.5	55 435 88 88 8	18,000	21,600	208~230/1/60	0.4	25.6
MSAHU-2	MSAHU-2 2ND ANNOUNEMENT	LG LSN181HSV5	1.5	77 77 77 88 88	18,000	21,600	208~230/1/60	0.4	25.6

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NEW INDOOR WALL MOUNTED DUCTLESS MINI—SPLIT AIR HANDLING UNITS. INSTALLATION. RATED CAPACITY IS BASED ON 95°F DB/75°F WB OUTDOOR LONGER ALLOWED IN ANY UNITS MANUFACTURED JANUARY 1ST, 2025, OR INSTALLATION, MODEL# LG PMBD3620. REFER TO MANUFACTURER SPECIFICATIONS REGARDING TEMPERATURE. AS PER 2021 EPA REQUIREMENTS, R410A IS NO LATER. TWO-PORT BRANCH DISTRIBUTION UNIT REQUIRED FOR

REVISION

REMARKS:

- CONTRACTOR SHALL PROVIDE/INSTALL HVAC SYSTEM AS SHOWN ON PLANS. REQUIREMENTS. DUCTLESS MINI-SPLIT AIR REFER TO MANUFACTURER HANDLING UNIT SPECIFICATIONS FOR AND ACCESSORIES FOR A COMPLETE AND PROPER INSTALLATION RESTRICTIONS OPERABLE AND
- COORDINATE ELECTRICAL DISCONNECT WITH ELECTRICAL CONTRACTOR.

MAINTAIN MANUFACTURER CLEARANCES.

- 4. PROVIDE THERMOSTAT CONTROL VIA LG PREMTB101 STANDARD III WIRED REMOTE CONTROLLER
- REFER TO MSAHU SCHEDULE AND MANUFACTURER SPECIFICATIONS FOR PROPER INSTALLATION RESTRICTIONS AND REQUIREMENTS.
- RUN $\frac{32}{32}$ O.D. & & I.D. INCH DRAIN LINE TO NEAREST BY CODE LOCATION.

DRAFT

NEGLIA GROUP

TOWNSHIP OF VERONA BLOCK 707 - LOT 10

IMPROVEMENTS

EVERETT PARK

STATE OF NEW JERSEY COUNTY OF ESSEX

ANTHONY KURUS, PE, PP

DRAFT

GRANT ENGINEERING

SPECIFICATIONS IN ANY UNITS N

MANUFACTURED

JANUARY

3 DODD STREET LEN RIDGE, NJ 07028 - 962.702.3637 F: 862.7 CONSULTANTS, LLC

MECHANICAL SCHEDULES

RID GHAEMI, PE

M200

- IT IS THE INTENT OF THESE SPECIFICATIONS TO PROVIDE A COMPLETE, FINISHED, TESTED, ADJUSTED, AND OPERATIONAL PLUMBING SYSTEM. ANY APPARATUS, MATERIAL, WORK, OR INCIDENTAL ITEMS REQUIRED TO MAKE THE SYSTEM COMPLETE AND READY FOR OPERATION SHALL BE INCLUDED IN THE PLUMBING CONTRACTOR'S PROPOSAL (BID) WHETHER OR NOT IT IS SHOWN ON THE DRAWINGS OR NOTED.
- THE DRAWINGS ARE GENERALLY DIAGRAMMATIC. THEY ARE INTENDED TO CONVEY THE SCOPE OF THE WORK AND TO INDICATE THE GENERAL ARRANGEMENT OF THE EQUIPMENT, PIPING, ETC. THE PLUMBING CONTRACTOR MUST OBTAIN APPROVED CONSTRUCTION DRAWINGS FROM THE GENERAL CONTRACTOR BEFORE BEGINNING ANY
- THE PLUMBING CONTRACTOR SHALL OBTAIN AND PAY FOR ALL NECESSARY PERMITS AND LICENSES PERTAINING TO THE WORK.
- THE PLUMBING CONTRACTOR SHALL BE RESPONSIBLE FOR COORDINATED PLUMBING WORK WITH OTHER TRADES SO AS TO PROVIDE THE SYSTEM AS DESCRIBED.

PLUMBING NOTES:

- THE PLUMBING CONTRACTOR SHALL PROVIDE THE WORK INDICATED ON THE DRAWINGS AND SPECIFIED HEREIN FOR ALL PLUMBING WORK. THE WORD "WORK" SHALL MEAN ALL LABOR, TRANSPORTATION, MATERIAL, EQUIPMENT, TOOLS, INSTALLATION, SUPERVISION AND ANY OTHER INCIDENTAL ITEMS OR SERVICES OBVIOUSLY NECESSARY FOR THE PROPER INSTALLATION AND OPERATION OF THE COMPLETE SYSTEMS. THE WORD "PROVIDE" SHALL MEAN FURNISH AND INSTALL, MAKE ALL FINAL CONNECTIONS AND LEAVE IN AN APPROVED OPERATING CONDITION.
- THE PLUMBING CONTRACTOR SHALL NOTIFY LOCAL INSPECTOR FOR ALL REQUIRED INSPECTIONS THROUGHOUT THE CONSTRUCTION THAT ARE UNDER THE LOCAL INSPECTOR'S JURISDICTION.
- TRASH
- THE PLUMBING CONTRACTOR SHALL PROVIDE ALL SUPPORTS AND HANGERS FOR ALL EQUIPMENT INSTALLED UNDER THIS WORK.
- THE PLUMBING CONTRACTOR SHALL CONNECT ALL KITCHEN EQUIPMENT. ALL EXPOSED PIPING IN KITCHEN SHALL BE CHROME PLATED.

SUBMITTALS:

- THE PLUMBING CONTRACTOR SHALL SUBMIT SUBMITTAL SHEETS AND EQUIPMENT SPECIFICATIONS (SHOP DRAWINGS) OF ALL EQUIPMENT, PIPING, VALVES, ACCESSORIES, ETC. BEFORE PROCEEDING WITH ANY WORK. INCLUDING THE FOLLOWING:

- MAINTENANCE MANUALS OF WATER HEATERS.
- 5. THE PLUMBING CONTRACTOR SHALL PREPARE THREE (3) SETS OF AS-BUILT DRAWINGS OF THE PROJECT. THE THREE (3) SETS SHALL BE GIVEN TO THE OWNER AT THE COMPLETION OF THE PROJECT. ANY DEVIATIONS, CHANGES, OR ADDITIONS TO THE CONTRACT DRAWINGS MUST BE INDICATED ON THE AS-BUILT DOCUMENTS.

D. D.DELIVER, STORAGE AND HANDLING:

GENERAL PIPING, VALVES AND SUPPORTS FOR PLUMBING SYSTEMS:

SANITARY PIPING:

. UNDERGROUND SANITARY SEWER PIPING: CAST IRON AND PVC PIPING.
. COMPLY WITH ASTM A74, ASTM A888, AND CISPI 301.
ABOVE GROUND SANITARY AND VENT PIPING: CAST IRON AND PVC PIPING.
. COMPLY WITH ASTM A74, ASTM A888, AND CISPI 301.
CONNECT NEW SANITARY PIPING AND VENT PIPING TO EXISTING SEWER AND VENT PIPING. PROVIDE TRANSITION FITTING. VERIFY LOCATION WITH SITE ENGINEER & ARCHITECT.

- PROVIDE EXTERNAL PROTECTIVE 0.025 INCH WRAPPING AROUND ALL PIPING PASSING THROUGH OR IN CONCRETE WALLS.

- PROVIDE AN ACCESSIBLY LOCATED VALVE IN EACH CONNECTION TO A PIECE OF EQUIPMENT AND AT ALL OTHER POINTS WHERE INDICATED OR REQUIRED FOR A PROPER SYSTEM OPERATION AND MAINTENANCE.
- BALL VALVES: 600 PSI WOG, FULL PORT, TWO PIECE, BRONZE BODY PLATED STEEL BALL AND STEM. NIBCO T595Y SERIES, THREADED ENDS; OS595Y SERIES, SWEAT ENDS.

BACKFLOW PREVENTERS:

- a. REDUCED PRESSURE BACKFLOW PREVENTER: /
 b. FURNISHED WITH TWO GATE VALVES, STRAINER
 c. PROVIDE WHERE SHOWN ON DRAWINGS AND OBEPARTMENT FOR MODEL TYPE AND BUILDING
 d. BASIS OF DESIGN: "WATTS" MANUFACTURER.
 e. ACCEPTABLE MANUFACTURERS: "FEBCO", "WILKI
- IS" AND "WATTS"
- H. PROVIDE EXPANSION LOOPS FOR HOT AND COLD STRAIGHT RUN.

- THE PLUMBING CONTRACTOR SHALL BE RESPONSIBLE FOR THE FOLLOWING WITH REGARD TO THE PLUMBING WORK: WORKMAN IDENTIFICATION, WORKER'S SAFETY CONTRACTOR'S LIABILITY INSURANCE, SAFETY BARRICADES, WARNING SIGNS AND TREMOVAL.
- THE PLUMBING CONTRACTOR WILL PROTECT THE WORK AND MATERIALS AGAINST DIRT, THEFT, INJURY OR DAMAGE UNTIL ACCEPTED BY THE OWNER. ALL WORK SHALL BE TURNED OVER TO THE OWNER CLEAN AND IN NEW CONDITION READY FOR SATISFACTORY SERVICE. THE PLUMBING CONTRACTOR SHALL PROVIDE ALL RIGGING, HANDLING OF MATERIALS AND EQUIPMENT, AND THE NECESSARY PROTECTION FOR MATERIALS AND EQUIPMENT. TOOLS AND EQUIPMENT WILL ONLY BE STORED IN OWNER DESIGNATED AREAS ONLY.
- THE PLUMBING CONTRACTOR SHALL CHECK AND VERIFY ALL SIZES, DIMENSIONS AND CONDITIONS BEFORE STARTING ANY WORK. ANY DEVIATIONS OR PROBLEMS SHALL BE TRANSMITTED TO THE ARCHITECT FOR REVIEW.

- SPECIAL PURPOSE VALVES
 PLUMBING FIXTURES
 FLOOR DRAINS
 BACKFLOW PREVENTER IF APPLICABLE
 WATER HEATER

INSPECTION AND TEST REPORTS.

- CERTIFICATES OF INSPECTIONS AND TESTS FROM AN INDEPENDENT TESTING AGENCY.

DELIVER AND STORE EQUIPMENT ON FACTORY INSTALLED SHIPPING SKIDS, SMALL SPECIALTIES IN FACTORY FABRICATED CONTAINERS AND PIPING WITH SEALING PLUGS IN ENDS OR WITH OTHER PROTECTION.

G. WATER PIPING WITHIN BUILDING AND ABOVE GROUND SHALL BE TYPE "L" HARD COPPER WITH WROUGHT COPPER FITTINGS AND VALVES AT EQUIPMENT MAKEUP INLET CONNECTIONS.

SOLDER SHALL BE LEAD FREE

- CONNECT NEW COLD WATER PIPING TO WATER SERVICE AS REQUIRED. VERIFY EXACT LOCATION IN FIELD. CONNECT NEW HOT AND COLD WATER PIPING TO ALL EQUIPMENT NOTED.
- INSULATE WITH 1/2" THICK OWENS CORNING FIBERGLASS WITH ALL SERVICE JACKET. PROVIDE PIPE SHIELDS AT HANGER LOCATIONS.
- PROVIDE FLUSHING AND DISINFECTING AS PRESCRIBED IN LOCAL HEALTH AUTHORITIES' STANDARDS. IN ABSENCE, PROVIDE AS PRESCRIBED IN AWWA C-651.
- SHUTOFF VALVES - DOMESTIC WATER

- ANSI/ASSE 1013.
 R, AND TEST COCK.
 CONFORM TO LOCAL
- WATER PIPING OVER **1**00
- I. EQUIPMENT SCHEDULE IS PROVIDED TO INDICATE REQUIREMENTS OF SPECIFIED EQUIPMENT. SUBMITTAI PERMITTED SUBJECT TO APPROVAL. PERFORMANCE AND QUALITY
 L OF SUBSTITUTE PRODUCTS SHALL 晤
- J. PLUMBING CONTRACTOR SHALL BE RESPONSIBLE BALANCING ON ALL PLUMBING INSTALLED, MODIFIED CONTRACT. THIS INCLUDES ALL TESTING REQUIRED E JURISDICTION, FLUSHING, AND DISINFECTING OF DON FOR TESTING, START UP AND OR REVISED BY WORK OF THIS BY THE AUTHORITY HAVING MESTIC WATER SYSTEM.
- K. ALL EQUIPMENT OR PIPE PENETRATIONS SEALED. THROUGH H WALL SHALL BE SLEEVED AND
- PANELS FOR ANY CONCEALED VALVES,
- L. PLUMBING CONTRACTOR SHALL PROVIDE ACCESS CLEANOUTS, OR TRAPS.
- M. ALL PIPE SUPPORTS SHALL CONFORM TO LATEST STHE INTERNATIONAL PLUMBING CODE. MAXIMUM SPACIN NOT EXCEED SPACING IN PLUMBING CODE. MINIMUM READDITIONAL SUPPORTS AT CONCENTRATED LOADS (VALVIN PIPING DIRECTION. PROVIDE A SUPPORT AT EACH JOUNG—HUB PIPING. PROVIDE A RISER CLAMP AT FLOOR INSULATION SHIELDS ON ALL INSULATED LINES. PROVIDINSULATION INSERTS WHERE NECESSARY TO PREVENT OF ATTACHMENTS SHALL BE COORDINATED WITH BUILDING SUBMITTED FOR APPROVAL. DROP IN ANCHORS OR WEILDING SUBMITTED FOR APPROVAL. EST SECTION 308 "PIPING SUPPORT" OF PACING FOR HORIZONTAL PIPING SHALL UM ROD SIZE SHALL BE 3/8". PROVIDE (VALVES, ETC.) IN ADDITION, AT CHANGES ICH JOINT FOR CAST IRON HUB AND JOR IN VERTICAL PIPING. PROVIDE ROVIDE HIGH STRENGTH CALCIUM SILICATE ENT CRUSHING INSULATION. STRUCTURAL DING CONSTRUCTION, AND SHALL BE R WEDGE ANCHORS BY HILTI OR PHILLIPS IE ENGINEER.
- DRAINAGE SPECIALTIES (CARRIERS, CLEANOUTS AI URGLE MANUFACTURER. PRODUCTS OF J. SMITH, JCJRN MANUFACTURERS ARE ACCEPTABLE. CONTRACIR FLOOR DRAINS AND CLEANOUTS WITH FINAL FLOARE TOPS IN TILE FLOORS, AND ROUND TOPS IN ND FLOOR DRAINS) SHALL BE FROM A DSAM, WADE, WATTS DRAINAGE, OR CTOR SHALL COORDINATE TOP SHAPE COOR FINISHES. IN GENERAL, PROVIDE IN OTHER AREAS.
- SEE ARCHITECTURAL DRAWINGS FOR PLUMBING F
- INCOMING WATER PRESSURE IS GREATER THAN 80 PSI, PROVIDE A WATTS PRESSURE EDUCING VALVE AT WATER SERVICE ENTRANCE. BUILDING SHALL BE PROVIDED WITH NO REATER THAN 80 PSI.

GENERAL NOTES:

- 1. ALL WORK SHALL BE IN ACCORDANCE WITH THE PLUMBING CODE, ALL LOCAL ORDINANCES AND THE AUTHORITY HAVING JURISDICTION.
- ALL PLUMBING MATERIALS, INSTALLATION PROCE APPROVED BY ALL APPLICABLE CODE ENFORCEME THE CONTRACTOR SHALL OBTAIN ALL NECESS. INSTALLATION. DURES AND SYSTEM LAYOUTS SHALL BE ENT AUTHORITIES HAVING JURISDICTION. ARY PERMITS AND APPROVALS FOR THIS
- PLUMBING DRAWINGS ARE SCHEMATIC IN NATURE. DO NOT SCALE FROM THESE DRAWINGS.
- CHANGES OR SUBSTITUTIONS OF EQUIPMENT WILL NOT BE ALLOWED WITHOUT SPECIFIC WRITTEN APPROVAL FROM THE ENGINEER. ALL COSTS RESULTING FROM THE SELECTION OF EQUIPMENT OTHER THAN SPECIFIED SHALL BE BORNE BY THE CONTRACTOR, INCLUDING, BUT NOT LIMITED TO WORK AFFECTING OTHER CONTRACTORS, THE OWNER, OR REDESIGN ISSUES.
- ALL CONTRACT WORK SHALL BE PERFORMED IN ACCORDANCE WITH ALL REQUIREMENTS OF THE WRITTEN SPECIFICATIONS AND ARE CONSIDERED TO BE AN INTEGRAL PART OF THESE CONTRACT DOCUMENTS.
- ALL PLUMBING WORK SHALL BE INSTALLED IN DEPARTMENT OF HEALTH. ACCORDANCE WITH THE STATE
- PROVIDE CLEAN OUTS AT THE BASE OF ALL S ACCORDANCE WITH THE LATEST EDITION OF THE SANITARY AND STORM STACKS IN CODE
- THE CONTRACTOR SHALL COORDINATE HIS WORK WITH EXISTING CONDITIONS AND ALL OTHER CONTRACTORS IN ESTABLISHING PIPE RUNS AND SPACE CONDITIONS.
- THE CONTRACTOR SHALL REVIEW THESE PLANS AND SPECIFICATIONS, AS WELL AS THE RELATED HVAC, ELECTRICAL, 9. STRUCTURAL, ARCHITECTURAL INTERIOR DECOR AND SITE ENGINEERING DRAWINGS TO BECOME FAMILIAR WITH THE FULL PROJECT SCOPE. DURING THE COURSE OF CONSTRUCTION COORDINATION AND ACTUAL CONSTRUCTION, THE CONTRACTOR SHALL COOPERATE WITH ALL OTHER CONTRACTORS AND TRADES ON THIS PROJECT, TO ENSURE A SMOOTH RUNNING AND CAREFULLY COORDINATED INSTALLATION.
- THESE BID DOCUMENTS AND THE RELATED HVAC, ELECTRICAL, STRUCTURAL, ARCHITECTURAL, INTERIOR DECOR AND SITE ENGINEERING DRAWINGS, OR BETWEEN THE BID DOCUMENTS AND FIELD CONDITIONS SHALL BE BROUGHT TO THE ATTENTION OF THE ENGINEER PRIOR TO BID SUBMISSION.

 11. RUN ALL DOMESTIC WATER AND SANITARY WASTE AT LOWEST LEVEL, AND SANITARY VENT AS HIGH AS POSSIBLE THROUGHOUT ENTIRE BUILDING. INSTALL LONG RUNS OF PIPING WITHIN STEEL (JOIST) SPACE AND OTHER PIPING TIGHT TO BOTTOM OF STEEL. COORDINATE AND VERIFY WITH OTHER CONTRACTORS SO AS NOT TO INTERFERE WITH DUCTWORK, LIGHTING SYSTEMS, ETC. IN THESE BID DOCUMENTS OR BETWEEN C, ELECTRICAL, STRUCTURAL, SINEERING DRAWINGS, OR BETWEEN THESE BE BROUGHT TO THE ATTENTION OF THE
- . ALL PIPING, EXCEPT IN MECHANICAL ROOMS TIGHT TO WALLS AND CEILINGS WITH STANDARD GENERAL CONTRACTOR. SHALL BE ORGANIZED NEATLY AND KEPT CLEARANCE FOR FUTURE FURRING BY
- ARRANGEMENT IN LOCATIONS WHICH ARE THE MOSHALL BE KEPT TO AN ABSOLUTE MINIMUM AND COORDINATED AND RUN WITHIN CHASES, WALLS, SMECHANICAL/ELECTRICAL FEEDS. ALL SUCH LOCAENGINEER PRIOR TO INSTALLATION. NG SHALL BE INSTALLED IN A NEAT STINCONSPICUOUS. VERTICAL DROPS THEIR FINAL LOCATIONS SHALL BE SOFFITS WITH OTHER ATIONS ARE TO BE REVIEWED WITH THE
- ALL PLUMBING FIXTURES/APPLIANCES SHALL ISHUT-OFF VALVES, INSTALLED IN AN EASILY ACCEDOMESTIC WATER BRANCH LINE SHALL HAVE ITS OF HAVE THEIR OWN INDEPENDENT ESSIBLE AND OPERABLE POSITION. OWN SHUT-OFF VALVE.
- . DOMESTIC HOT WATER HEATER TEMPERATURE/PRESSURE RELIEF VALVES SHALL BE PIPED FULL SIZE TO THE NEAREST APPROVED MOP SINK OR FLOOR DRAIN. THIS REQUIREMENT SHALL BE APPLICABLE TO ALL DOMESTIC WATER HEATERS EXCEPT INSTANTANEOUS WATER HEATERS.
- . FURNISH AND INSTALL PIPE SLEEVES PASSING THROUGH INTERIOR WALLS. SLEEVES SHALL BE STEEL PIPE: ASTM A 53, TYPE E, GRADE A, SCHEDULE 40, GALVANIZED, PLAIN ENDS, LENGTH EQUAL TO WIDTH OF WALL.
- . INSULATE ALL HOT WATER, HOT WATER RECIRCULATION, AND COLD WATER PIPING SYSTEMS. INSULATION SHALL BE INSTALLED AS A COMPLETE SYSTEM INCLUDING VALVES, FITTINGS, ETC.
- . ALL PENETRATIONS IN FOUNDATION WALLS AND FLOORS INCLUDING SLAB PENETRATIONS SHALL BE SEALED BY UTILIZING A NON-CRACKING POLYURETHANE OR SIMILAR CAULK, OR EQUIVALENT IN ORDER TO CLOSE OFF THE SOIL GAS (RADON) ENTRY ROUTES AS REQUIRED BY THE UNIFORM CONSTRUCTION CODE, SECTION 5:23 10.4 (b) 6.
- 19. HWH INDICATES PLUMBING EQUIPMENT. SCHEDULES FOR ADDITIONAL INFORMATION.

- AND VIBRATION ISOLATORS SHALL BE SELECTED IN ACCORDANCE WITH THE SPECIFICATIONS AND BASED ON ACTUAL WEIGHT DISTRIBUTION OF THE EQUIPMENT FURNISHED. DEFLECTIONS SHALL BE AS NOTED ON THE EQUIPMENT SHOP DRAWING SUBMITTALS. THE MANUFACTURER SHALL PROVIDE INSTALLATION INSTRUCTIONS, DRAWINGS, DETAILS, AND FIELD SUPERVISION AS NOTED IN SPECIFICATIONS. ALL VIBRATION ISOLATORS AND SEISMIC RESTRAINTS WILL BE IN STRICT ACCORDANCE WITH THE LATEST EDITIONS OF THE BUILDING CODES AND AUTHORITY HAVING JURISDICTION. THE MANUFACTURER OF THE VIBRATION AND SEISMIC COLUMN AND SEISMIC RESTRAINT TYPES, SIZES, LOCATIONS, DEFLECTIONS, DEAD LOADS, ANCHORING METHODS, BOLT DIAMETERS, EMBEDMENT AND WELD LENGTHS BASED ON ACTUAL EQUIPMENT BEING INSTALLED. THE MANUFACTURER WILL SUBMIT THESE CALCULATIONS SIGNED AND SEALED BY A PROFESSIONAL MECHANICAL ENGINEER LICENSED IN THE STATE OF NEW JERSEY, AS PART OF THE VIBRATION ISOLATION AND SEISMIC RESTRAINTS SHOP DRAWINGS. SEISMIC DESIGN ERRORS AND OMISSION INSURANCE CERTIFICATE SHALL BE A PART OF THIS SHOP DRAWING SUBMITTAL. NLESS OTHERWISE NOTED ON THESE DRAWINGS, ALL NICAL EQUIPMENT SHALL BE MOUNTED ON SEISMIC AINTS AND VIBRATION ISOLATORS TO PREVENT THE MISSION OF VIBRATION AND MECHANICALLY TRANSMIT OF THE BUILDING STRUCTURE. SEISMIC RESTRAINT
- 21. REFER TO HVAC DRAWINGS AND SPECIFICATIONS FOR SIZES OF ALL HVAC EQUIPMENT/DUCTWORK SHOWN ON THESE DRAWINGS.

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TAG

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22. FLOOR DRAINS SHALL BE MOUNTED DIRECTLY ADJACENT TO CONCRETE PADS ON WHICH EQUIPMENT IS SET. COORDINATE EXACT LOCATION WITH OTHER CONTRACTORS INVOLVED PRIOR TO SETTING.

MIXING VALVES

****C

DRAWN DESIGNED CHECKED

A TEMPERATURE ACTUATED MIXING VALVE SHALL BE INSTALLED IN CONJUNCTION WITH THE WATER HEATING SOURCE TO DISTRIBUTE TEMPERED WATER TO THE SYSTEM. THE VALVE SHALL BE CERTIFIED TO ASSE 1017, CSA B 125.3, NSF 372 STANDARDS AND SHALL BE LISTED BY A THIRD PARTY. THE TEMPERATURE ACTUATED MIXING VALVE SHALL CONTROL THE DELIVERED WATER TEMPERATURE VIA A REGULATING PISTON MADE FROM ENGINEERED POLYMER. THE ADJUSTING MECHANISM SHALL USE A UNIQUE, PURPOSE DESIGNED ADJUSTED TO MINIMITY HAMILTHORIZED TAMBERING WITH

APP'D ARCH. BLDG. COORD. CO DET.('S) EA. ELEC. EQ ETC. EXIST. FL. IN., " INANUF. MAX. MECH. MIN. N.T.S. SAN. SCHED. SQ. FT. SQ. IN. TYP. V.I.F. V.I.F.	LIST OF ABBREVIATIONS
AND AT APPROVED ARCHITECTURAL BUILDING COORDINATE CLEANOUT DETAIL(S) EACH ELECTRICAL EQUAL ETCETERA EXISTING FLOOR INCH MANUFACTURER MANIMUM MECHANICAL MINIMUM NOT TO SCALE SANITARY SCHEDULE SQUARE FEET SQUARE INCHES TYPICAL VERIFY IN FIELD WITH	REVIATIONS

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APPLICABLE CODES

NATIONAL STANDARD PLUMBING CODE 2021 INTERNATIONAL NEW JERSEY BUILDING CODES: MECHANICAL CODE 2021

PLUMBING GENERAL NOTES

1.DESIGN DRAWINGS ARE SCHEMATIC. THIS CONTRACTOR SHALL VISIT THE SITE PRIOR TO BIDDING OR AWARD OF CONTRACT TO INSPECT EXISTING FIELD CONDITIONS. THIS CONTRACT SHALL INCLUDE ALL LABOR AND MATERIALS NECESSARY FOR FIELD MODIFICATIONS DUE TO EXISTING CONDITIONS.

2.THE CONTRACTOR SHALL CONTACT THE CLARIFICATIONS OF THE DESIGN AND INCL BY THE ARCHITECT, ENGINEER OR OWNER COST. ARCHITECT, ENGINEER OR OWNER PRIOR TO BIDDING FOR INTERPRETATIONS AND JUDE IN HIS BID ALL COSTS TO MEET THE DESIGN INTENT. CLARIFICATIONS MADE AFTER BIDDING WILL BE FINAL AND SHALL BE IMPLEMENTED AT CONTRACTORS

3.BIDDING CONTRACTORS SHALL HAVE A WORKING KNOWLEDGE OF LOCAL CODES AND ORDINANCES AND SHALL INCLUDE IN THEIR BIDS THE COSTS FOR ALL WORK INSTALLED IN STRICT ACCORDANCE WITH GOVERNING CODES, THE PLANS AND SPECIFICATIONS NOT WITHSTANDING. THE CONTRACTOR SHALL ALERT ARCHITECT, ENGINEER OR OWNER OF ANY APPARENT DISCREPANCIES BETWEEN GOVERNING CODES AND DESIGN INTENT.

			HEN			•			^		•	
MIXING VALVE	TRAP PRIMER	WATER HAMMER ARRESTOR	KITCHEN SINK WITH HOT & COLD WATER FAUCET	WATER FOUNTAIN	SERVICE SINK FAUCET FAUCET BLOCK HANDIFLO FITTING	MOP SINK	TOILET DRAIN FLANGE	TOILET	LAVATORY FOUCET	LAVATORY	FIXTURE	
MANUF: MODEL #:	MANUF: MODEL #:	*	MANUF: MODEL 来	MANUF: MODEL #: MOUNTING: COLOR:	MANUF: MODEL #	MANUF: MODEL #:		MANUF: MODEL #: STYLE: COLOR:	MANUF: MODEL # STYLE:	MANUF: MODEL #: STYLE: COLOR:		PL
WATTS MMV	PRECISION PLUMBING PRODUCTS, INC. P2-500	SIOUX CHEIF 750 SERIES	ELKAY, LUSTERTONE DROP-IN TRIPLE BASIN 18 GAUGE STAINLESS STEEL	ELKAY EZSTL8LC WALL LIGHT GRAY GRANITE	MUSTEE 93.600 CHROME FINISH MUSTEE 20.600 MUSTEE 94.700	MUSTEE 17F		AMERICAN STANDARD 2462.016 2462.016 CADET PRO RIGHT HEIGHT 29-1/4"H PRESSURE ASSISTED TOILET WHITE (SEAT TO MATCH)	AMERICAN STANDARD 5500-170-002CQ5 MONTEREY	AMERICAN STANDARD LUCERN WALL-HUNG LAVATORY VITEOUS WHITE	MODEL #	PLUMBING FIXTURE S
1/2" PIPE SIZE	ADJUSTABLE FLOW RATE, INTEGRAL VACCUUM BREAKER AND INTEGRAL BACKFLOW PREVENTER.	750 SERIES OR EQUAL BY PRECISION PLUMBING PRODUCTS, INC.		8.0 GPH WATER COOLER, ADA, PUSHBALL CONTROLS ON FRONT AND SIDES, NON-FILTERED		FLOOR MOUNTED. CONNECTS TO STANDARD 1 ½"P OR S TRAP. 19 GALLON CAPACITY. 13" DEEP TUB.	PVC OR ABS WITH PLASTIC RING. FITS OUTSIDE 3" OR INSIDE 4" SCHEDULE 40 DWV PIPE.	VITEOUS CHINA 1.6 GPF	TWO-HANDEL CENTERSET LAVATORY FOUCET	VITEOUS CHINA W/ WALL HANGER	DESCRIPTION	SCHEDULE
SHALL CONFORM W/ ASSE 1017, ASSE 1069 & ASSE 1070.	MOUNT IN AN ACCESSIBL LOCATION PER MANUF PRINTED INSTRUCTIONS.										REMARKS	

REVISION

CHECK VALVE	
UNION	
SLEEVE	11
WATER PROOF SLEEVE	}
WATER HAMMER ARRESTER	<u> </u>
DOMESTIC HOT WATER PIPING	
DOMESTIC COLD WATER PIPE	
VENT PIPE	
SANITARY PIPE	
LEGEND	

NEGLIA GROUP

IMPROVEMENTS

EVERETT PARK

TOWNSHIP OF VERONA STATE OF NEW JERSEY BLOCK 707 - LOT 10 COUNTY OF ESSEX

DRAFT

GRANT ENGINEERING
CONSULTANTS, LLC

PLUMBING SPECIFICATIONS, NOTES, ABBREVIATION, DETAILS & APPLICABLE CODES

NEW JERSEY 07092

NEGLIA GROUP

EXPERIENCED DEDICATED RESPONSIVE


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MOUNTAINSIDE

200 CENTRAL AVENUE, SUITE 102

MOUNTAINSIDE


P001

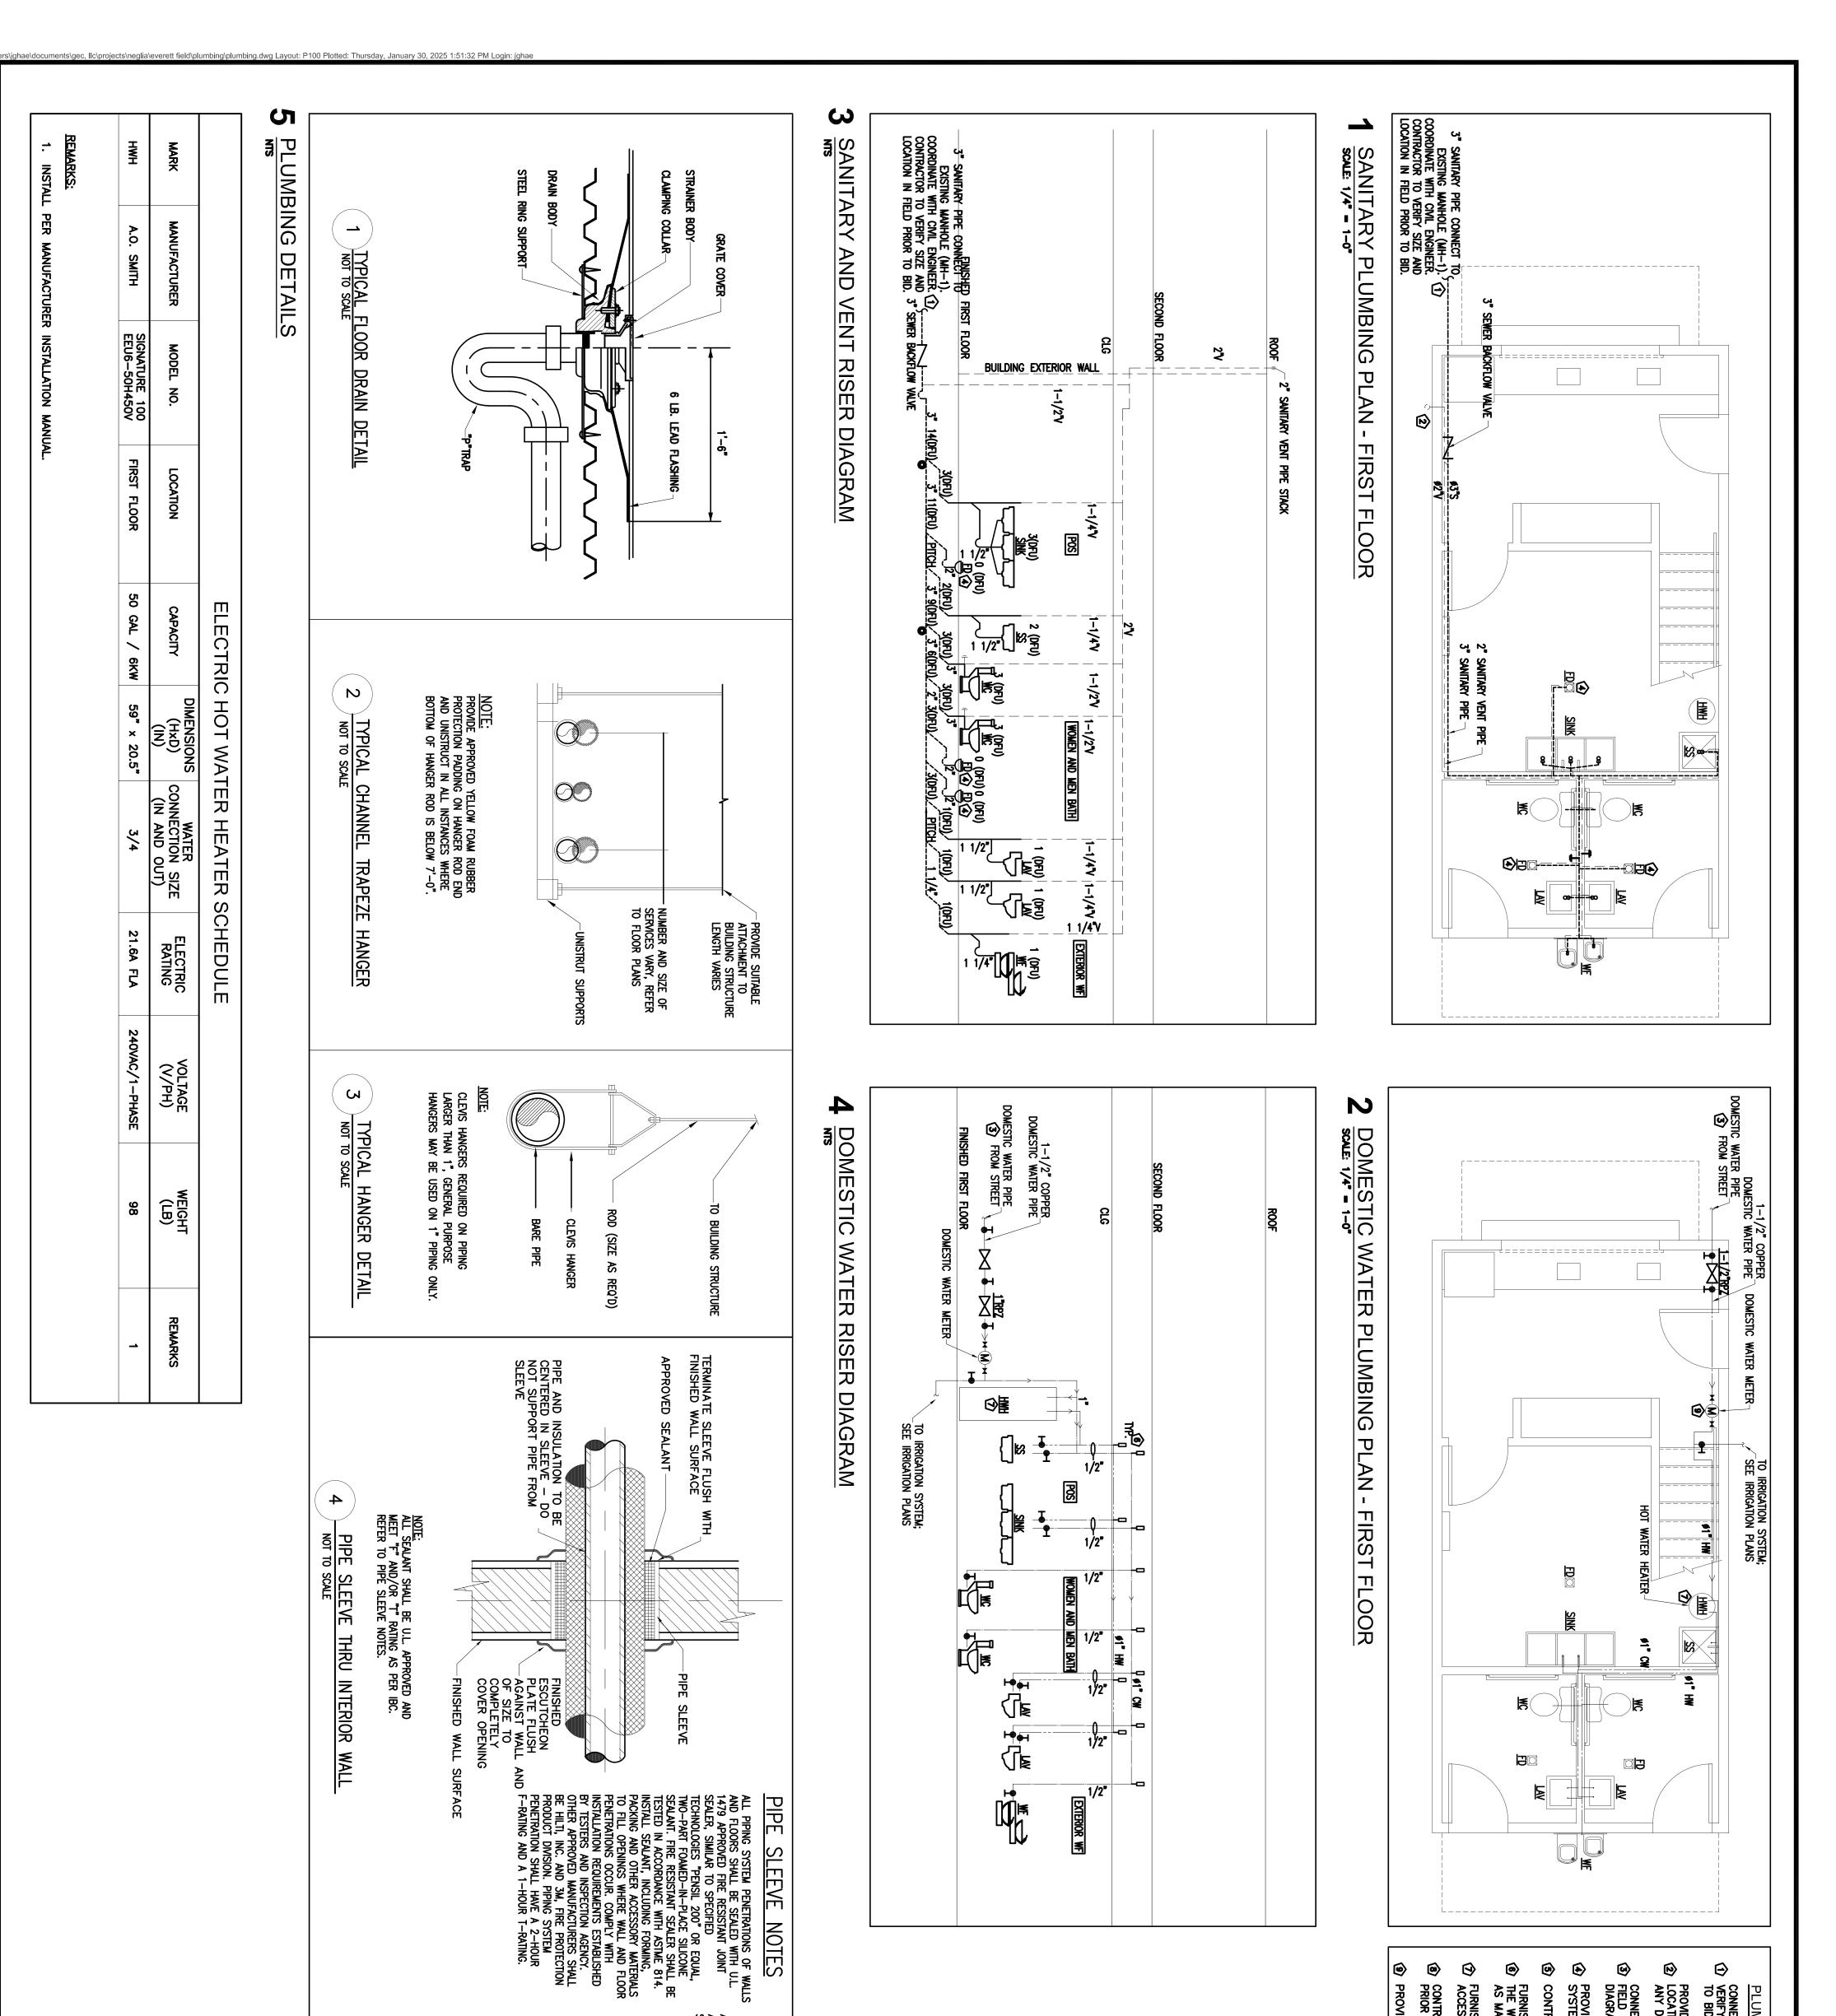

REMARKS:

INSTALL

PER MANUFACTURER INSTALLATION MANUAL

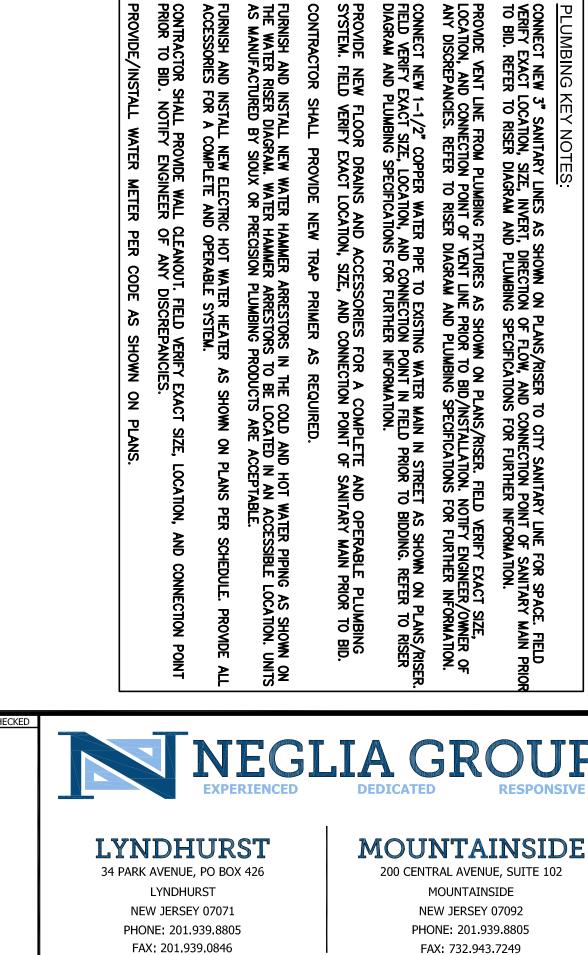

INFO@NEGLIAGROUP.COM

©

PROVIDE/INSTALL WATER METER PER CODE AS SHOWN ON PLANS.

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CONTRACTOR SHALL PROVIDE NEW TRAP PRIMER AS REQUIRED.

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DRAWN DESIGNED CHECKED REVISION **NEGLIA GROUP IMPROVEMENTS** ANTHONY KURUS, PE, PP **EVERETT PARK** TOWNSHIP OF VERONA STATE OF NEW JERSEY BLOCK 707 - LOT 10 COUNTY OF ESSEX DRAFT DRAFT **≅**P

NOTES

APPROVED WATERTIGHT ASPHALT OR MASTIC SEALANT

INTERIOR FACE OF FOUNDATION WALL

WALL PENETRATION SEAL

WATER STOP AND ANCHOR COLLAR

SHALL SHALL SHED

SEAL OUTSIDE OF PENETRATION WITH APPROVED SEALANT

SLEEVE

APPROVED SEALANT BACKED MATERIAL

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PIPE SLEEVE

THRU EXTERIOR WALL

GRANT ENGINEERING
CONSULTANTS, LLC

SANITARY & DOMESTIC WATER
'LUMBING PLANS, RISER DIAGRAMS,
KEY NOTES, PLUMBING DETAILS &
SCHEDULE

P100

NOTE: ALL SEALANT SHALL BE U.L. APPROVED AND MEET "F" AND/OR "T" RATING AS PER IBC. REFER TO PIPE SLEEVE NOTES.

GENERAL STRUCTURAL AND CONSTRUCTION NOTES

GENERAL

- ALL WORK SHALL CONFORM TO THE "2021 INTERNATIONAL BUILDING CODE NJ EDITION" AND TO ALL OTHER APPLICABLE FEDERAL, STATE, AND LOCAL REGULATIONS.
- 2. IN CASE OF CONFLICT BETWEEN THE GENERAL NOTES AND DETAILS, THE MOST RIGID REQUIREMENTS SHALL GOVERN.
- WORK NOT INDICATED ON A PART OF THE DRAWINGS BUT REASONABLY IMPLIED TO BE SIMILAR TO THAT SHOWN AT CORRESPONDING PLACES SHALL BE REPEATED.
- 4. JOB SITE SAFETY AND CONSTRUCTION PROCEDURES ARE THE SOLE RESPONSIBILITY OF THE CONTRACTOR.
- THE CONTRACTOR SHALL PROVIDE FOR DEWATERING AS REQUIRED DURING EXCAVATION AND CONSTRUCTION. REFER TO SPECIFICATIONS FOR ADDITIONAL INFORMATION
- ALL COSTS OF INVESTIGATION AND/OR REDESIGN DUE TO CONTRACTOR IMPROPER INSTALLATION OF STRUCTURAL ELEMENTS OR OTHER ITEMS NOT IN CONFORMANCE WITH THE CONTRACT DOCUMENTS SHALL BE AT THE CONTRACTOR'S EXPENSE.
- THE STRUCTURAL DRAWINGS SHALL BE USED IN CONJUNCTION WITH THE SITE CIVIL DRAWINGS. IF THERE IS A DISCREPANCY BETWEEN DRAWINGS, IT IS THE CONTRACTOR'S RESPONSIBILITY TO NOTIFY THE ENGINEER PRIOR TO PERFORMING THE WORK.
- THE CONTRACTOR SHALL VERIFY ALL EXISTING BUILDING INFORMATION SHOWN (DIMENSIONS, ELEVATIONS, ETC.) AND NOTIFY THE ENGINEER OF ANY DISCREPANCIES PRIOR TO FABRICATION OF ANY STRUCTURAL COMPONENT.
- THE CONTRACTOR SHALL VERIFY AND/OR ESTABLISH ALL EXISTING CONDITIONS AND DIMENSIONS AT THE SITE. FAILURE TO NOTIFY ENGINEER OF UNSATISFACTORY CONDITIONS CONSTITUTES ACCEPTANCE OF UNSATISFACTORY CONDITIONS.
- 10. IF THE EXISTING FIELD CONDITIONS DO NOT PERMIT THE INSTALLATION OF THE WORK IN ACCORDANCE WITH THE DETAILS SHOWN. THE CONTRACTOR SHALL NOTIFY THE ENGINEER IMMEDIATELY AND PROVIDE A SKETCH OF THE CONDITION WITH HIS PROPOSED MODIFICATION OF THE DETAILS GIVEN ON THE CONTRACT DOCUMENTS. DO NOT COMMENCE WORK UNTIL CONDITION IS RESOLVED AND MODIFICATION IS APPROVED BY THE ENGINEER.
- 11. THE CONTRACTOR SHALL BE RESPONSIBLE TO DETERMINE ALLOWABLE CONSTRUCTION LOADS AND TO PROVIDE DESIGN AND CONSTRUCTION OF FALSEWORK, FORMWORK, STAGINGS, BRACING, SHEETING, AND SHORING, ETC.
- 12. CONTRACTOR TO PROVIDE SHEETING, BRACING, AND UNDERPINNING AS NECESSARY TO PREVENT ANY LATERAL OR VERTICAL MOVEMENTS OF EXISTING STAIRS, RETAINING WALLS, STREETS, AND ANY EXISTING UTILITY LINES.
- 13. SHOP DRAWINGS FOR ALL STRUCTURAL MATERIALS TO BE SUBMITTED TO ENGINEER FOR REVIEW PRIOR TO THE START OF FABRICATION OR COMMENCEMENT OF WORK. REVIEW PERIOD SHALL BE A MINIMUM OF TWO (2) WEEKS.

EARTHWORK

- EXCAVATION SHALL BE PERFORMED SO AS NOT TO DISTURB EXISTING ADJACENT BUILDINGS, SIDEWALKS, STREETS, AND UTILITY LINES, UNLESS WHERE PAVEMENT AND SIDEWALKS ARE NOTED FOR REPLACEMENT ON SITE PLANS. VERIFY LOCATION OF ALL UTILITIES AND EXISTING ADJACENT FOUNDATION ELEVATIONS PRIOR TO COMMENCEMENT OF WORK. HAND EXCAVATE AROUND UTILITIES AS REQUIRED.
- DO NOT EXCAVATE BELOW THE INFLUENCE LINE DRAWN FROM THE BOTTOM OF EXISTING ADJACENT FOUNDATIONS ELEVATIONS AT A SLOPE OF 2H:1V.
- THE OWNER SHALL RETAIN THE SERVICES OF A PROFESSIONAL GEOTECHNICAL ENGINEER, SUBJECT TO THE APPROVAL OF THE ENGINEER, TO PERFORM SOIL TESTING AND INSPECTION.
- THE RETAINING WALL DESIGNS HAVE BEEN PREPARED BASED ON RECOMMENDATIONS, CRITERIA AND BORING INFORMATION INCLUDED IN A GEOTECHNICAL ENGINEERING REPORT PREPARED BY GZA GEOENVIRONMENTAL INC. DATED OCTOBER 27, 2023. CONTRACTOR SHALL REVIEW THE GEOTECHNICAL REPORT INFORMATION PRIOR TO BID.
- THE CONTRACTOR SHALL OBSERVE WATER CONDITIONS AT THE SITE AND TAKE THE NECESSARY PRECAUTIONS TO ENSURE THAT THE FOUNDATION EXCAVATIONS REMAIN DRY DURING CONSTRUCTION. ANY DEWATERING SHALL BE THE RESPONSIBILITY OF THE CONTRACTOR.

SHEETING AND SHORING

- 1. SHEETING, SHORING, AND ASSOCIATED EXCAVATION SHALL BE PERFORMED IN ACCORDANCE WITH OSHA GUIDELINES.
- TEMPORARY BRACING, SHEETING, SHORING, ETC., REQUIRED FOR WALL EXCAVATION AND WALL INSTALLATION, SHALL BE DESIGNED BY A PROFESSIONAL ENGINEER ENGAGED BY THE CONTRACTOR. DETAILED SIGNED AND SEALED SHOP DRAWINGS SHALL BE PREPARED INDICATING ALL WORK TO BE PERFORMED. SUBMIT THE SHOP DRAWINGS IN ACCORDANCE WITH THE CONTRACT REQUIREMENTS.

FOUNDATIONS

- FOUNDATIONS HAVE BEEN DESIGNED AND FOOTING ELEVATIONS ESTABLISHED ON THE BASIS OF A SUBSURFACE INVESTIGATION REPORT AND RECOMMENDATIONS PREPARED BY GZA GEOENVIRONMENTAL INC. DATED DECEMBER 12, 2024. SEE THE REPORT FOR ADDITIONAL REQUIREMENTS. THE REQUIREMENTS CONTAINED IN THE GEOTECHNICAL REPORT ARE PART OF THE CONSTRUCTION DOCUMENTS.
- RETAINING WALL AND BUILDING FOOTINGS SHALL BEAR ON VIRGIN SOIL OR CONTROLLED COMPACTED FILL PER THE REQUIREMENTS
- PRIOR TO FOOTING CONCRETE PLACEMENT, THE FOOTING SUBGRADE SHALL BE APPROVED BY THE INSPECTING GEOTECHNICAL ENGINEER. IF CONDITIONS PROVE TO BE UNACCEPTABLE AT ELEVATIONS SHOWN, FOOTING BOTTOMS SHALL BE LOWERED TO ACCEPTABLE SUBGRADE MATERIAL. FILL OVER-EXCAVATION WITH LEAN CONCRETE (2,500 PSI)

OF THE GEOTECHNICAL REPORT WITH A MINIMUM BEARING CAPACITY OF 4,000 PSF.

- THE BOTTOM OF EXTERIOR FOOTINGS SHALL BE A MINIMUM OF 3'-0"(3) FEET BELOW FINISHED GRADE, OR AS REQUIRED BY LOCAL BUILDING CODES.
- 5. THE BEARING ELEVATIONS OF NEW FOOTINGS ADJACENT TO EXISTING FOOTINGS ARE TO MATCH THE ADJACENT EXISTING FOOTING BEARING ELEVATIONS UNLESS INDICATED OTHERWISE ON PLANS.
- SLABS ON GRADE SHALL BEAR ON MECHANICALLY COMPACTED SOIL CAPABLE OF SUPPORTING 500 PSF. DRAINAGE FILL UNDER SLABS SHALL BE COMPACTED GRAVEL OR CRUSHED STONE.
- CONCRETE FOR FOUNDATIONS SHALL BE POURED ON THE SAME DAY THE SUBGRADE IS APPROVED BY THE GEOTECHNICAL
- 8. UTILITY LINES SHALL NOT BE PLACED THROUGH OR BELOW FOUNDATIONS WITHOUT THE STRUCTURAL ENGINEER'S APPROVAL.
- THE CONTRACTOR SHALL OBSERVE WATER CONDITIONS AT THE SITE AND TAKE THE NECESSARY PRECAUTIONS TO ENSURE THAT THE FOUNDATION EXCAVATIONS REMAIN DRY DURING CONSTRUCTION. ANY SHEETING OR SHORING REQUIRED FOR DEWATERING SHALL BE THE RESPONSIBILITY OF THE CONTRACTOR.

CAST-IN-PLACE CONCRETE

- CONCRETE SHALL BE DESIGNED AND DETAILED IN ACCORDANCE WITH THE BUILDING CODE REQUIREMENTS FOR STRUCTURAL CONCRETE (ACI-318-18), AND CONSTRUCTED IN ACCORDANCE WITH THE CRSI MANUAL OF STANDARD PRACTICE.
- LEAN CONCRETE SHALL HAVE A MINIMUM COMPRESSIVE 28-DAY STRENGTH OF 1,500 PSI. AIR ENTRAINMENT 4.5% TO 7.5% IN ALL EXPOSED CONCRETE WORK.
- ALL CONCRETE SHALL BE NORMAL WEIGHT CONCRETE (144 PCF +) WITH ALL CEMENT CONFORMING TO ASTM C150. TYPE I. MAXIMUM AGGREGATE SIZE SHALL BE 1-1/2" FOR FOOTINGS AND 3/4" FOR WALLS AND SLABS, CONFORMING TO ASTM C33.
- 4. REINFORCING STEEL: ASTM A615 GRADE 60
- LEVELING GROUT SHALL BE NON-SHRINK, NON-METALLIC TYPE, FACTORY PRE-MIXED GROUT IN ACCORDANCE WITH CE-CRD-C621 OR ASTM C109, WITH A MINIMUM COMPRESSIVE 28-DAY STRENGTH OF 5,000 PSI.
- THE CONCRETE SLABS SHALL BE FINISHED FLAT AND LEVEL WITHIN TOLERANCE, TO THE ELEVATION INDICATED ON THE DRAWINGS.
- EARLY DRYING OUT OF CONCRETE, ESPECIALLY DURING THE FIRST 24 HOURS, SHALL BE CAREFULLY GUARDED AGAINST. ALL SURFACES SHALL BE MOIST CURED OR PROTECTED USING A MEMBRANE CURING AGENT APPLIED AS SOON AS FORMS ARE REMOVED. IF MEMBRANE CURING AGENT IS USED, EXERCISE CARE NOT TO DAMAGE COATING.
- COLD WEATHER CONCRETING SHALL BE IN ACCORDANCE WITH ACI-306. HOT WEATHER CONCRETING SHALL BE IN ACCORDANCE WITH ACI-305R.
- THROUGHOUT CONSTRUCTION, THE CONCRETE WORK SHALL BE ADEQUATELY PROTECTED AGAINST DAMAGE DUE TO EXCESSIVE LOADING, CONSTRUCTION EQUIPMENT, MATERIALS OR METHODS, ICE, RAIN, SNOW, EXCESSIVE HEAT, AND FREEZING TEMPERATURES.
- 10. PREPARE CONCRETE TEST CYLINDERS FROM EACH DAY'S POUR. CYLINDERS SHALL BE PROPERLY CURED AND STORED. SAMPLE FRESH CONCRETE IN ACCORDANCE WITH ASTM C172.
- 11. RETAIN LABORATORY TO PROVIDE TESTING SERVICE. SLUMP PER ASTM C143L AIR CONTENT PER ASTM C231 OR C173, CYLINDER TESTS PER ASTM C31 AND C39. ONE SET OF SIX (6) CYLINDERS FOR EACH 50 CUBIC YARDS FOR EACH MIX USED. REPORTS OF ALL TESTS TO BE SUBMITTED TO THE ARCHITECT.

SEGMENTAL BLOCK RETAINING WALLS

PART 1: GENERAL

1.1 SCOPE

WORK INCLUDES FURNISHING AND INSTALLING CONCRETE RETAINING WALL UNITS TO THE LINES AND GRADES DESIGNATED ON THE CONSTRUCTION DRAWINGS AND AS SPECIFIED HEREIN.

1.2 REFERENCE STANDARDS

ASTM C94 READY-MIXED CONCRETE

ASTM C1372 SEGMENTAL RETAINING WALL UNITS

- 1.3 DELIVERY, STORAGE, AND HANDLING
- A. CONTRACTOR SHALL CHECK THE MATERIALS UPON DELIVERY TO ASSURE PROPER MATERIAL HAS BEEN RECEIVED.
- B. CONTRACTOR SHALL PREVENT EXCESSIVE MUD, WET CEMENT AND LIKE MATERIALS FROM COMING IN CONTACT WITH THE
- C. CONTRACTOR SHALL PROTECT THE MATERIALS FROM DAMAGE. DAMAGED MATERIAL SHALL NOT BE INCORPORATED IN

PART 2: MATERIALS

2.1 WALL UNITS

- A. WALL UNITS SHALL BE REDI-ROCK® AS PRODUCED BY A LICENSED MANUFACTURER OR AN APPROVED EQUAL LARGE BLOCK SEGMENTAL WALL SYSTEM. THE CONSTRUCTION DOCUMENTS ARE BASED ON A REDI-ROCK WALL SYSTEM. IF AN ALTERNATE SYSTEM IS SUBMITTED THE CONTRACTOR SHALL SUBMIT SIGNED AND SEALED SHOP DRAWINGS AND DESIGN CALCULATIONS INCLUDING INTERNAL WALL STABILITY AS WELL AS GLOBAL SLOPE STABILITY DESIGN AND CHECKS.
- B. WALL UNITS SHALL BE MADE WITH READY-MIXED CONCRETE IN ACCORDANCE WITH ASTM C94, 4,000 PSI 28TH DAY COMPRESSIVE STRENGTH AND 41/3% TO 71/3% AIR ENTRAINMENT NOTWITHSTANDING ANYTHING STATED ABOVE, ALL MATERIAL USED IN THE WALL UNITS MUST MEET APPLICABLE ASTM AND LOCAL REQUIREMENTS FOR EXTERIOR CONCRETE.
- C. EXTERIOR BLOCK DIMENSIONS SHALL BE UNIFORM AND CONSISTENT. MAXIMUM DIMENSIONAL DEVIATIONS SHALL BE 1% EXCLUDING THE ARCHITECTURAL SURFACE. MAXIMUM WIDTH (FACE TO BACK) DEVIATION INCLUDING THE ARCHITECTURAL SURFACE SHALL BE 1.0 INCH.
- D. EXPOSED FACE SHALL BE FINISHED AS SELECTED BY OWNER. SUBMIT SAMPLES OF MANUFACTURER'S COMPLETE LINE OF AVAILABLE FINISHES FOR OWNER'S SELECTION. OTHER SURFACES TO BE SMOOTH FORM TYPE. DIME-SIZE BUG HOLES ON THE BLOCK FACE MAY BE PATCHED AND/OR SHAKE-ON COLOR STAIN CAN BE USED TO BLEND INTO THE REMAINDER OF THE BLOCK FACE.
- 2.2 LEVELING PAD AND FREE DRAINING BACKFILL
 - A. LEVELING PAD SHALL BE AS NOTED IN THE TYPICAL DETAILS.
- B. FREE DRAINING BACKFILL MATERIAL SHALL BE WASHED STONE AND SHALL BE PLACED TO A MINIMUM OF 1' WIDTH BEHIND THE BACK OF THE WALL AND SHALL EXTEND VERTICALLY FROM THE LEVELING PAD TO AN ELEVATION 4" BELOW THE TOP OF WALL.
- C. NON-WOVEN GEOTEXTILE CLOTH SHALL BE PLACED BETWEEN THE FREE DRAINING BACKFILL AND RETAINED SOIL. E. WHERE ADDITIONAL FILL IS NEEDED, CONTRACTOR SHALL SUBMIT SAMPLE AND SPECIFICATIONS TO THE GEOTECHNICAL ENGINEER FOR APPROVAL

2.3 DRAINAGE

A. INTERNAL AND EXTERNAL DRAINAGE SHALL BE PROVIDED AS NOTED ON THE PLANS.

2.4 BACKFILL

A. BACKFILL BEHIND CRUSHED STONE SHALL BE COMPACTED GRANULAR FILL WITH A MINIMUM FRICTION ANGLE OF 32 DEGREES.

PART 3: CONSTRUCTION OF WALL SYSTEM

3.1 EXCAVATION

- A. CONTRACTOR SHALL EXCAVATE TO THE LINES AND GRADES SHOWN ON THE CONSTRUCTION DRAWINGS. ALL EXCAVATION SHALL BE PERFORMED IN ACCORDANCE WITH OSHA STANDARDS. CONTRACTOR SHALL BE RESPONSIBLE FOR PROVIDING DESIGN AND CONSTRUCTION OF TEMPORARY SHORING AS NEEDED TO MAINTAIN SLOPE STABILITY BEHIND WALL AND A SAFE EXCAVATION.
- 3.2 FOUNDATION SOIL PREPARATION
 - A. NATIVE FOUNDATION SOIL SHALL BE COMPACTED TO 95% OF STANDARD PROCTOR OR 90% OF MODIFIED PROCTOR PRIOR TO PLACEMENT OF THE LEVELING PAD MATERIAL.
- B. IN-SITU FOUNDATION SOIL SHALL BE EXAMINED BY THE ENGINEER TO ENSURE THAT THE ACTUAL FOUNDATION SOIL STRENGTH MEETS OR EXCEEDS ASSUMED DESIGN STRENGTH. SOIL NOT MEETING THE REQUIRED STRENGTH SHALL BE REMOVED AND REPLACED WITH ACCEPTABLE. COMPACTED MATERIAL.

3.3 LEVELING PAD PLACEMENT


- A. LEVELING PAD SHALL BE PLACED AS SHOWN ON THE CONSTRUCTION DRAWINGS.
- B. LEVELING PAD SHALL BE PLACED ON UNDISTURBED NATIVE SOILS OR SUITABLE REPLACEMENTS FILLS.
- C. LEVELING PAD SHALL BE COMPACTED TO 95% OF STANDARD PROCTOR OR 90% OF MODIFIED PROCTOR TO ENSURE A LEVEL, HARD SURFACE ON WHICH TO PLACE THE FIRST COURSE BLOCKS. PAD SHALL BE CONSTRUCTED TO THE PROPER ELEVATION TO ENSURE THE FINAL ELEVATION SHOWN ON THE PLANS.
- LEVELING PAD SHALL HAVE A 6 INCH MINIMUM DEPTH FOR WALLS UNDER 8 FEET IN HEIGHT AND A 12 INCH MINIMUM DEPTH FOR WALLS OVER 8 FEET. PAD DIMENSIONS SHALL EXTEND BEYOND THE BLOCKS IN ALL DIRECTIONS TO A DISTANCE AT LEAST EQUAL TO THE DEPTH OF THE PAD OR AS DESIGNED BY ENGINEER.
- E. FOR STEPS AND PAVERS, A MINIMUM OF 1" 11/2" OF FREE DRAINING SAND SHALL BE SCREEDED SMOOTH TO ACT AS A PLACEMENT BED FOR THE STEPS OR PAVERS.

3.4 UNIT INSTALLATION

- A. THE FIRST COURSE OF WALL UNITS SHALL BE PLACED ON THE PREPARED LEVELING PAD WITH THE AESTHETIC SURFACE FACING OUT AND THE FRONT EDGES TIGHT TOGETHER. ALL UNITS SHALL BE CHECKED FOR LEVEL AND ALIGNMENT AS THEY ARE PLACED.
- B. ENSURE THAT UNITS ARE IN FULL CONTACT WITH LEVELING PAD. PROPER CARE SHALL BE TAKEN TO DEVELOP STRAIGHT LINES AND SMOOTH CURVES ON BASE COURSE AS PER WALL LAYOUT.
- C. THE BACKFILL IN FRONT AND BACK OF ENTIRE BASE ROW SHALL BE PLACED AND COMPACTED TO FIRMLY LOCK THEM IN PLACE. CHECK ALL UNITS AGAIN FOR LEVEL AND ALIGNMENT. ALL EXCESS MATERIAL SHALL BE SWEPT FROM TOP OF
- D. INSTALL NEXT COURSE OF WALL UNITS ON TOP OF BASE ROW. POSITION BLOCKS TO BE OFFSET FROM SEAMS OF BLOCKS BELOW. BLOCKS SHALL BE PLACED FULLY FORWARD SO KNOB AND GROOVE ARE ENGAGED. CHECK EACH BLOCK FOR PROPER ALIGNMENT AND LEVEL. BACKFILL TO 12 INCH WIDTH BEHIND BLOCK WITH FREE DRAINING BACKFILL. SPREAD BACKFILL IN UNIFORM LIFTS NOT EXCEEDING 9 INCHES. EMPLOY METHODS USING LIGHTWEIGHT COMPACTION EQUIPMENT THAT WILL NOT DISRUPT THE STABILITY OR BATTER OF THE WALL. HAND-OPERATED PLATE COMPACTION EQUIPMENT SHALL BE USED AROUND THE BLOCK AND WITHIN 3 FEET OF THE WALL TO ACHIEVE CONSOLIDATION. COMPACT BACKFILL TO 95% OF STANDARD PROCTOR (ASTM D 698, AASHTO T-99) DENSITY WITHIN 2% OF ITS OPTIMUM MOISTURE CONTENT.
- E. INSTALL EACH SUBSEQUENT COURSE IN LIKE MANNER. REPEAT PROCEDURE TO THE EXTENT OF WALL HEIGHT.
- F. ALLOWABLE CONSTRUCTION TOLERANCE AT THE WALL FACE IS 2 DEGREES VERTICALLY AND 1 INCH IN 10 FEET
- G. ALL WALLS SHALL BE INSTALLED IN ACCORDANCE WITH LOCAL BUILDING CODES AND REQUIREMENTS.


PART 4: AVAILABILITY

RFDI-ROCK® INTERNATIONAL 05481 SOUTH US-31, CHARLEVOIX, MI 49720 1-866-222-8400 WWW.REDI-ROCK.COM INFO@REDI-ROCK.COM

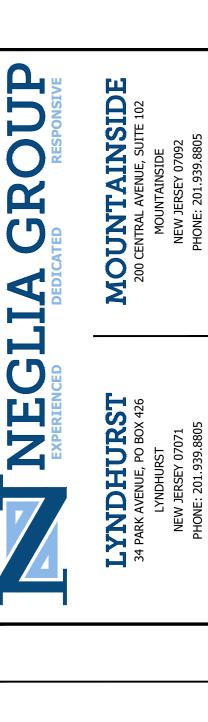

YNDHURST 14 PARK AVENUE, PO BOX 426

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EVERETT PARK IMPROVEMENTS

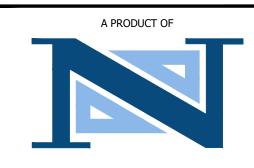BLOCK 707 - LOT 10 TOWNSHIP OF VERONA COUNTY OF ESSEX STATE OF NEW JERSEY




MPP Engineers LLC 34 S Main St Allentown, NJ 08501 Phone: (609) 489-5511


DELCHO G. PALECHEV PROFESSIONAL ENGINEER, N.J. LIC. No.48732

GENERAL NOTES

DRAWN BY:	MPP	SCALE:		NTS
DESIGNED BY:	DGP	CHECKED	BY:	DGP
PROJECT NO.: 2	4-0230			

S0.00 DATE: FEBRUARY 2025

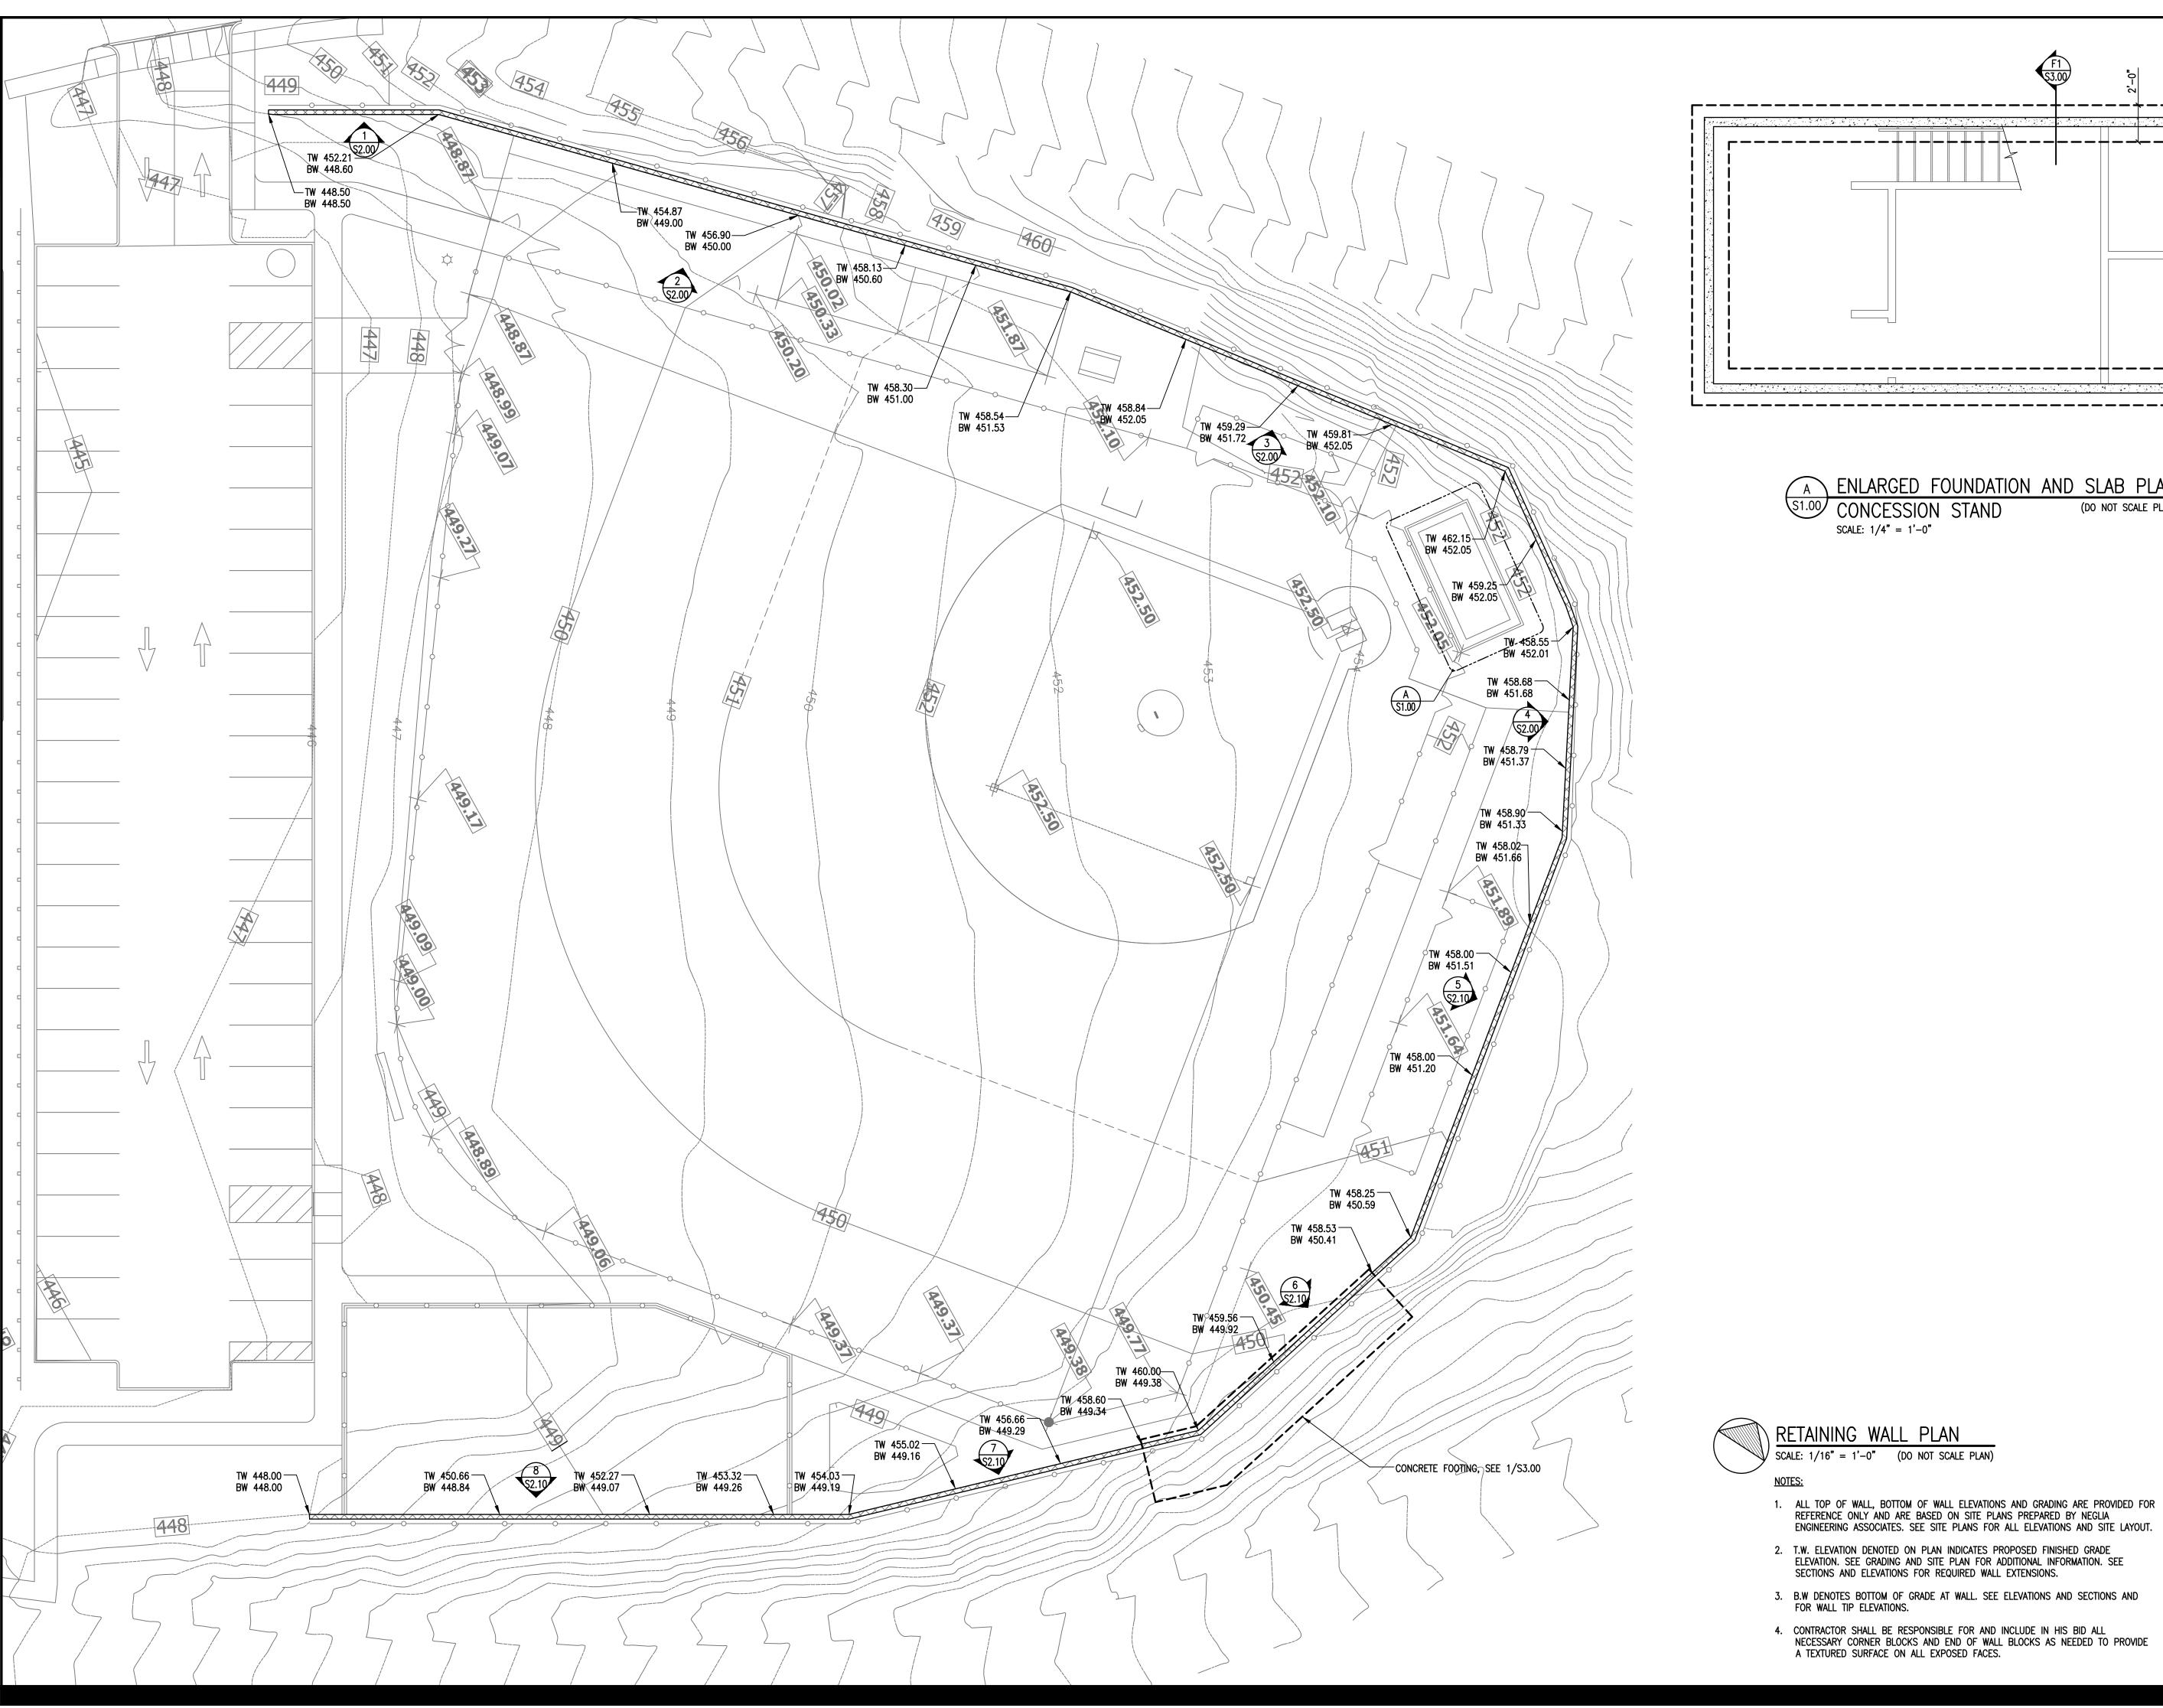

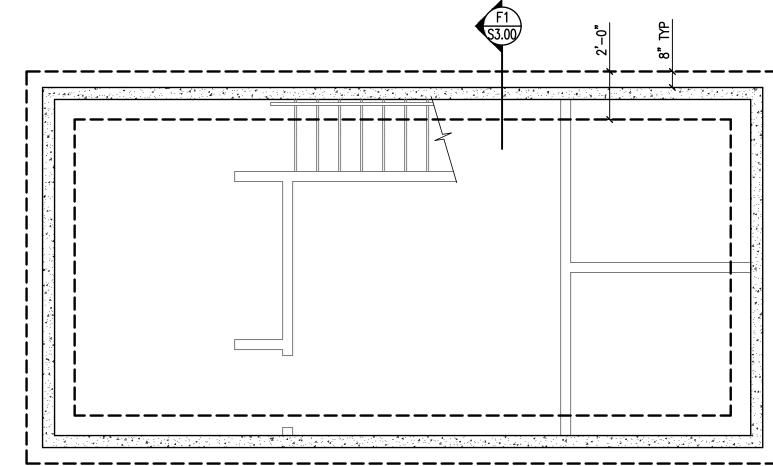

A ENLARGED FOUNDATION AND SLAB PLAN S1.00 CONCESSION STAND SCALE: 1/4" = 1'-0" (DO NOT SCALE PLAN)

NEGLL

LYNDHURST 34 PARK AVENUE, PO BOX 426

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EVERETT PARK IMPROVEMENTS

BLOCK 707 - LOT 10 TOWNSHIP OF VERONA COUNTY OF ESSEX STATE OF NEW JERSEY




MPP Engineers LLC 34 S Main St Allentown, NJ 08501 Phone: (609) 489-5511

DELCHO G. PALECHEV PROFESSIONAL ENGINEER, N.J. LIC. No.48732

RETAINING WALL PLAN, **ENLARGED FOUNDATION**


AND SLAB PLAN SCALE: 1/16"=1'-0"


DRAWN BY: MPP DESIGNED BY: DGP CHECKED BY: DGP PROJECT NO.: 24-0230 S1.00 DATE: FEBRUARY 2025

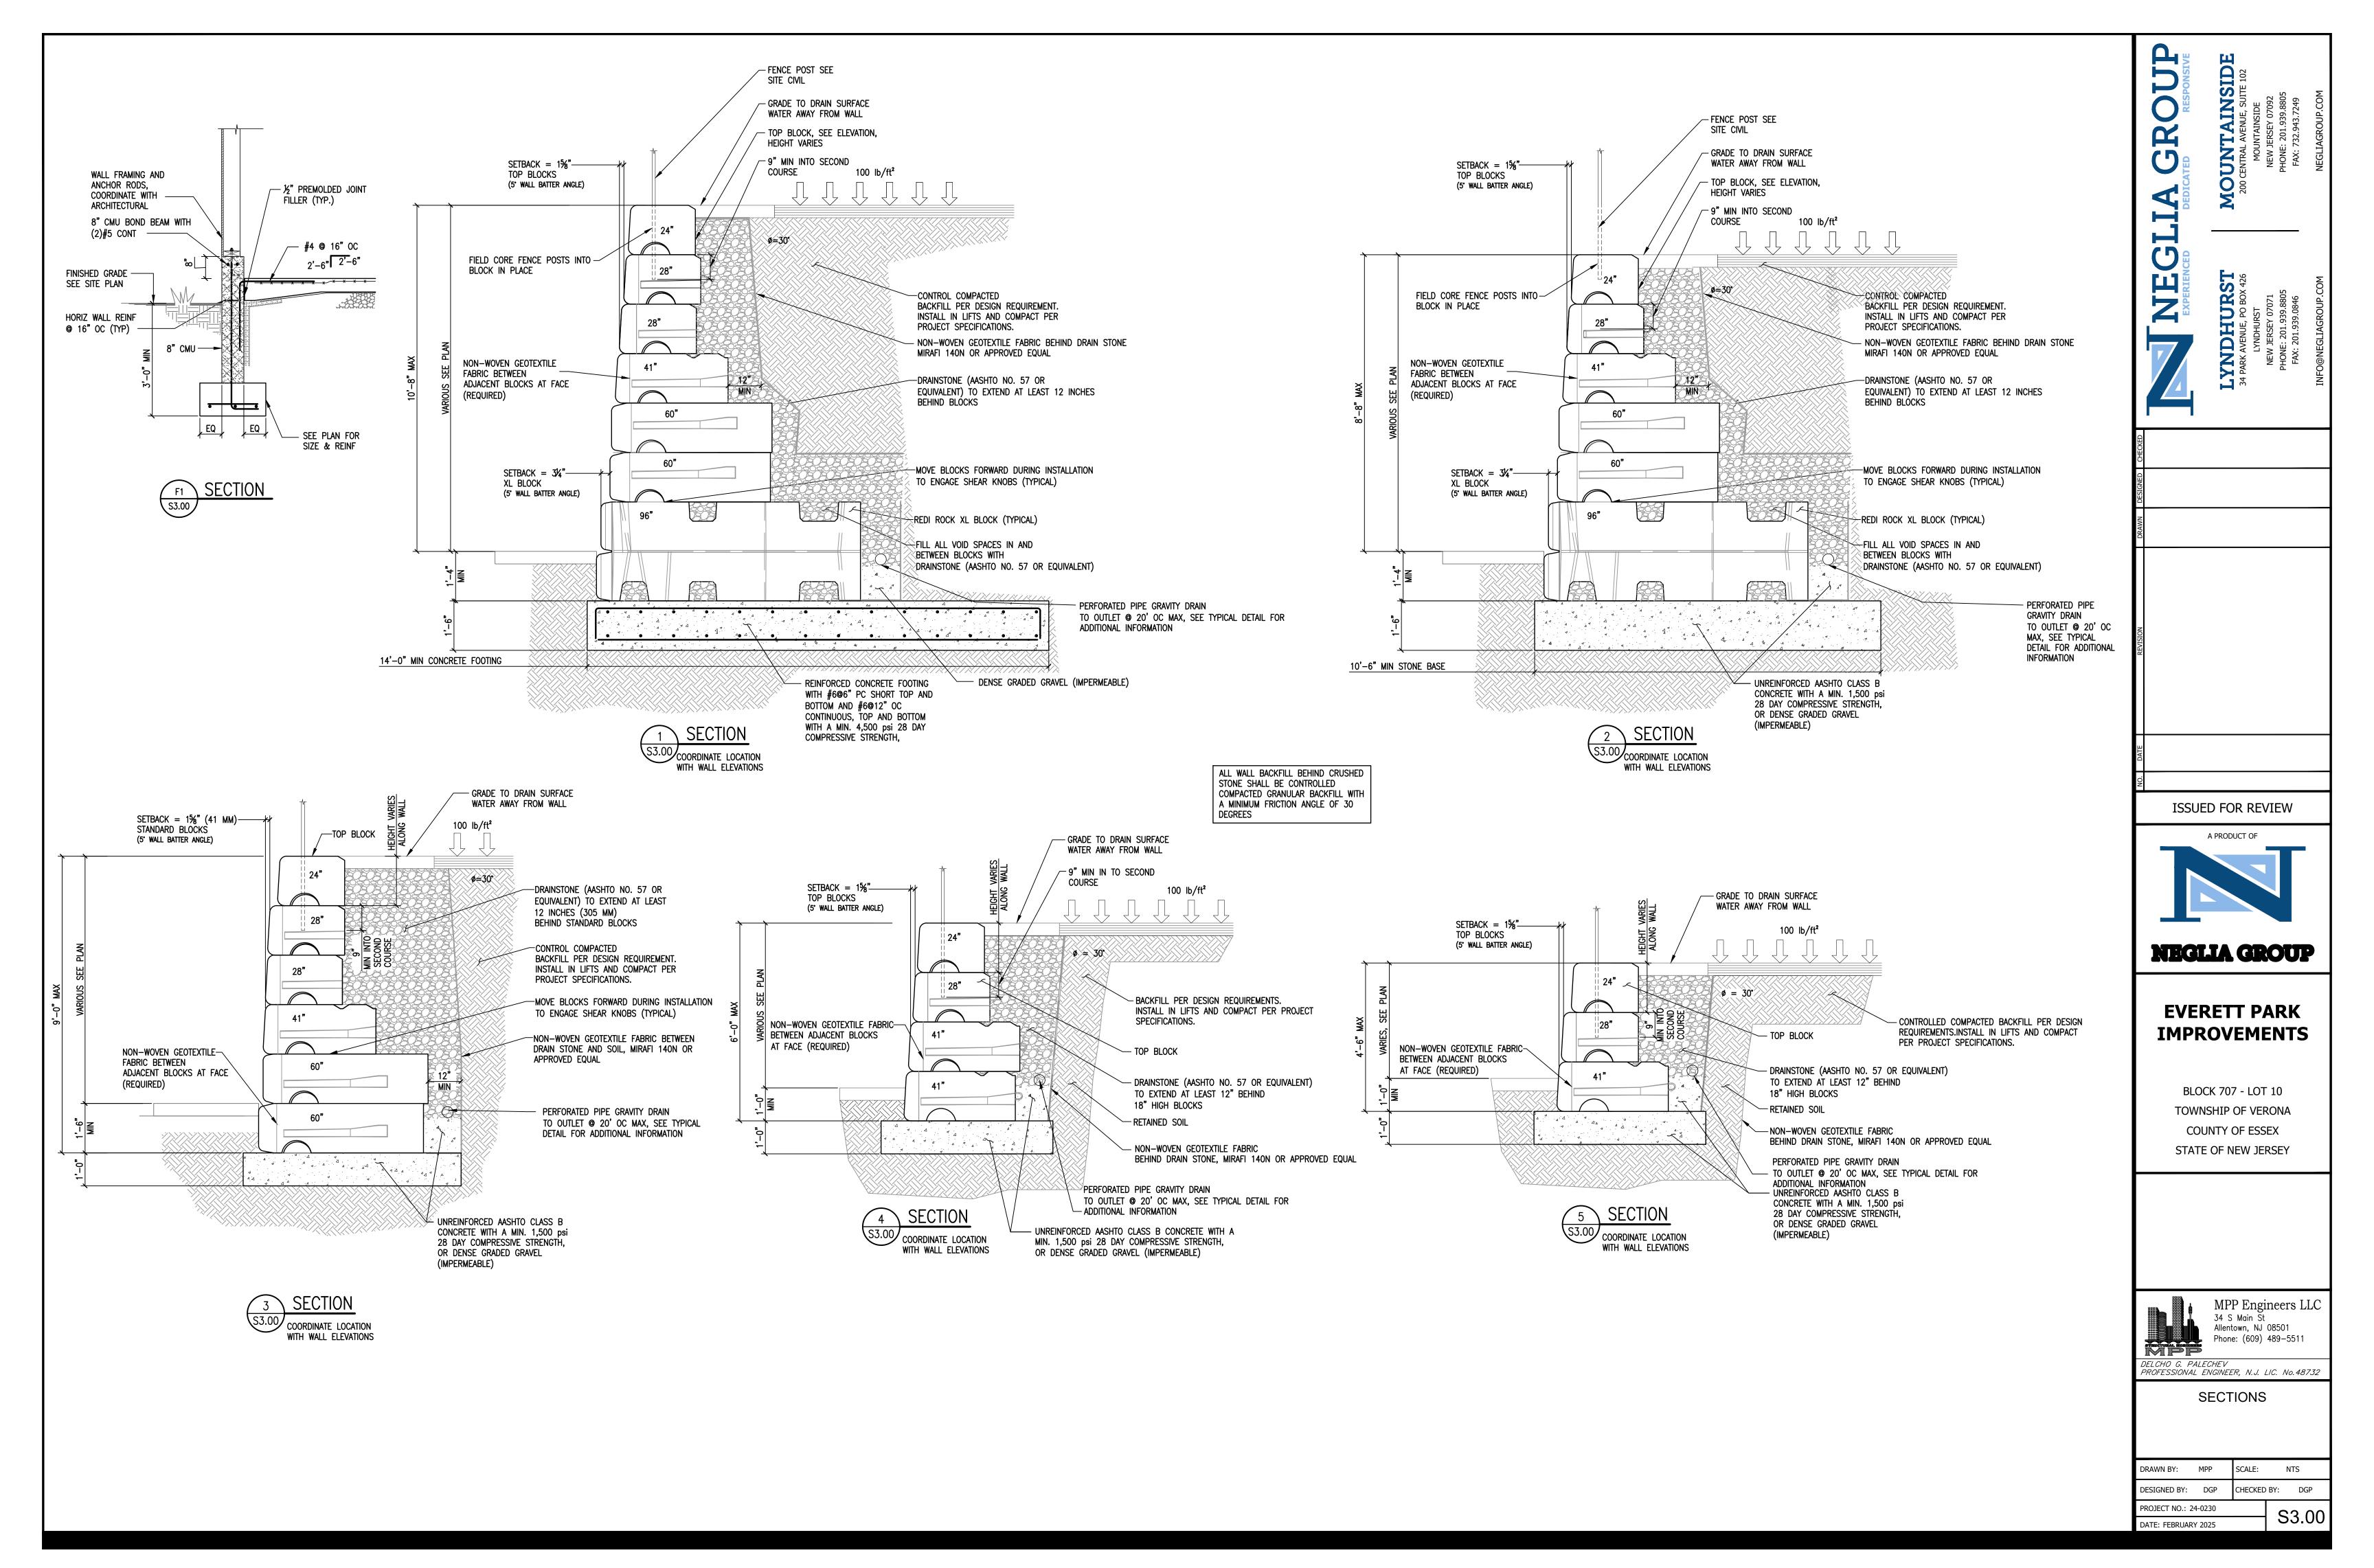

ROWS 2, 4, 6, AND 8 REQUIRE APPROXIMATELY ¹/₈" (3 MM) GAPS BETWEEN BLOCKS FOR LENGTH OF WALL GIVEN.
 SOLUTION SHOWN BASED ON A 24" (610 MM) WIDE CORNER

CORNER BLOCK (TYPICAL) -

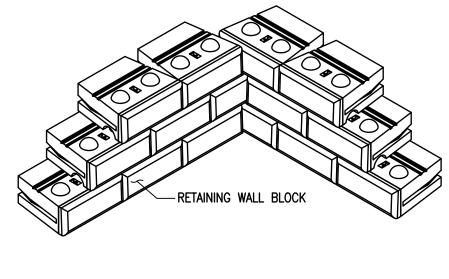

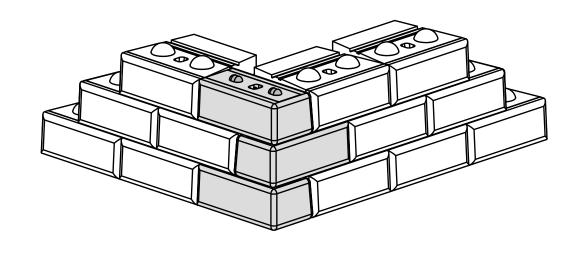


90° INSIDE CORNER (41" AND 28" SERIES)

WALL DRAIN WEEP HOLE OPTIONS

TD2 TYPICAL DETAIL

ISOMETRIC VIEW OF CORNER

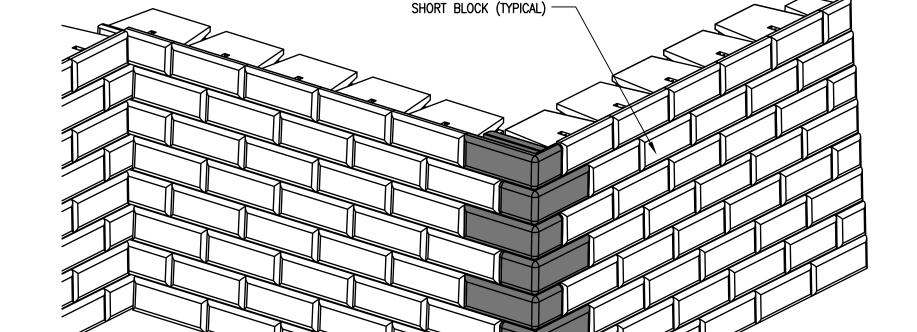



90° BATTERED CORNER – FLUSH END

ROW	SHORT BLOCK REQUIRED
1	0
2 AND 3	1 PER ROW
4 AND 5	2 PER ROW
6 AND 7	3 PER ROW
8	4 PER ROW

PIPE TO EXTEND 6" (152 MM) TO 8" (203 MM) FROM BACK OF BLOCK FOR CONNECTION TO PERFORATED WALL DRAIN

CUSTOM PIPE CAST INTO BLOCK

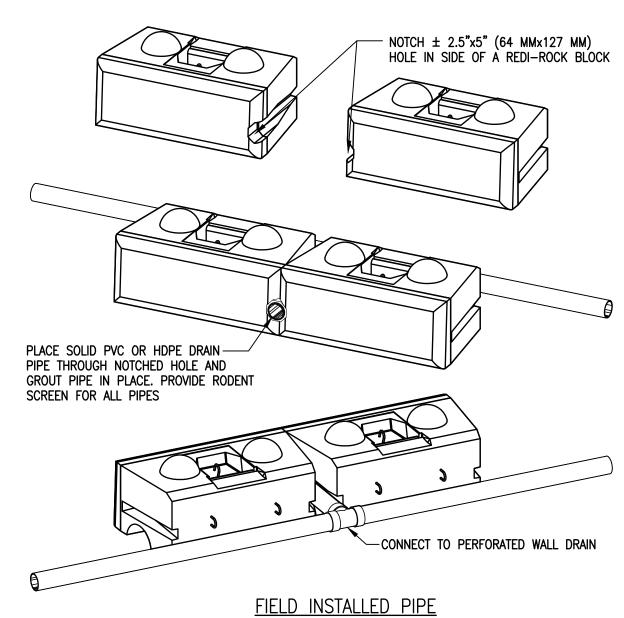


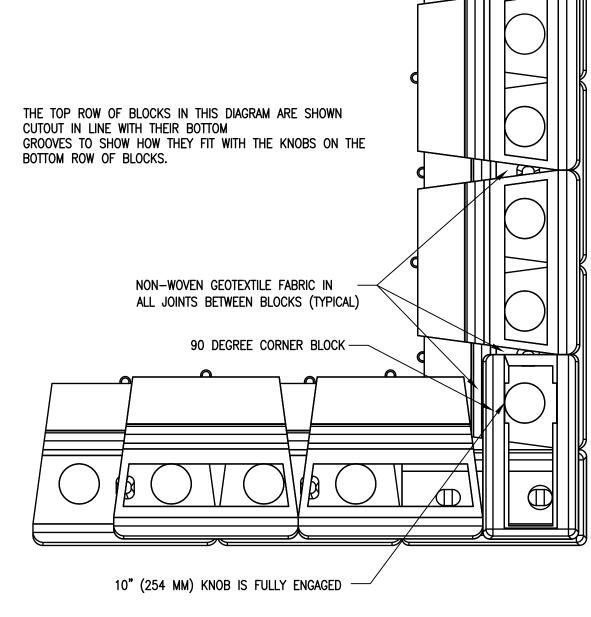


TOP VIEW OF BOTTOM TWO ROWS

TD4 TYPICAL DETAIL 90° CORNER BLOCK OPTION

TD3 TYPICAL DETAIL
S4.00 DRAINAGE WEEP OPTIONS

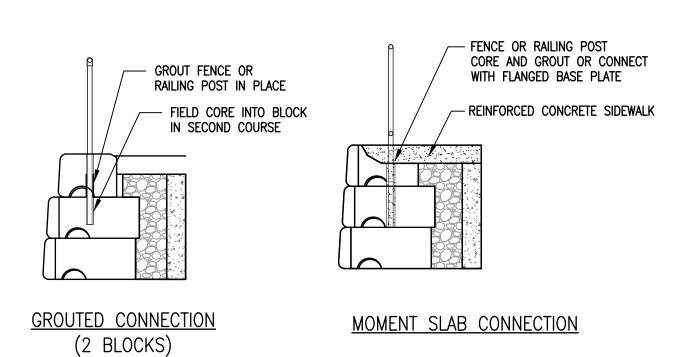


FENCE OR PEDESTRIAN GUARD CONNECTION OPTIONS

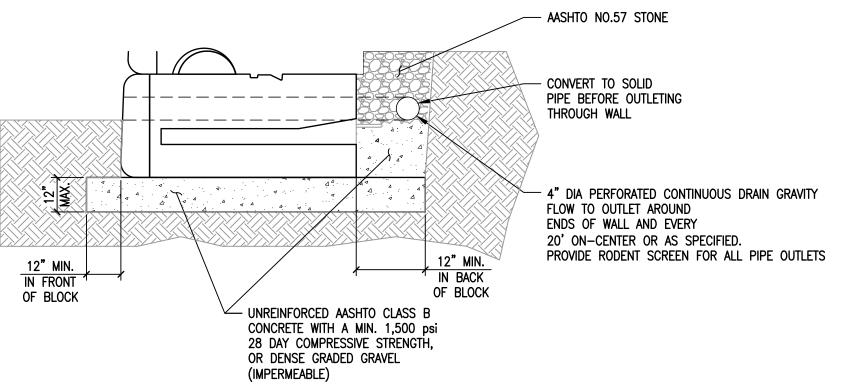

DENSE GRADED GRAVEL LEVELING PAD

TD6 TYPICAL DETAIL S4.00 LEVELING PAD AND DRAIN FOR RETAINING WALL

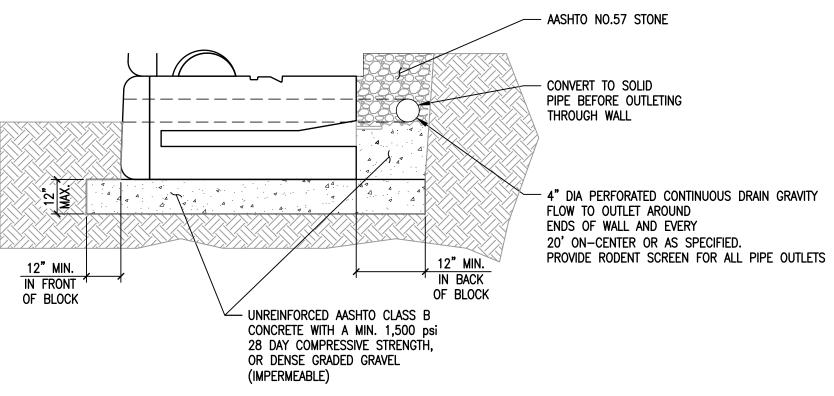

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IMPROVEMENTS

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TYPICAL DETAILS

DRAWN BY:	MPP	SCALE:	NTS
DESIGNED BY:	DGP	CHECKED	BY: DGP
PROJECT NO.: 2	4-0230		94.00
DATE: FEBRUAR		S4.00	